
California High-Speed Rail Authority Merced to Fresno Section: Central Valley Wye

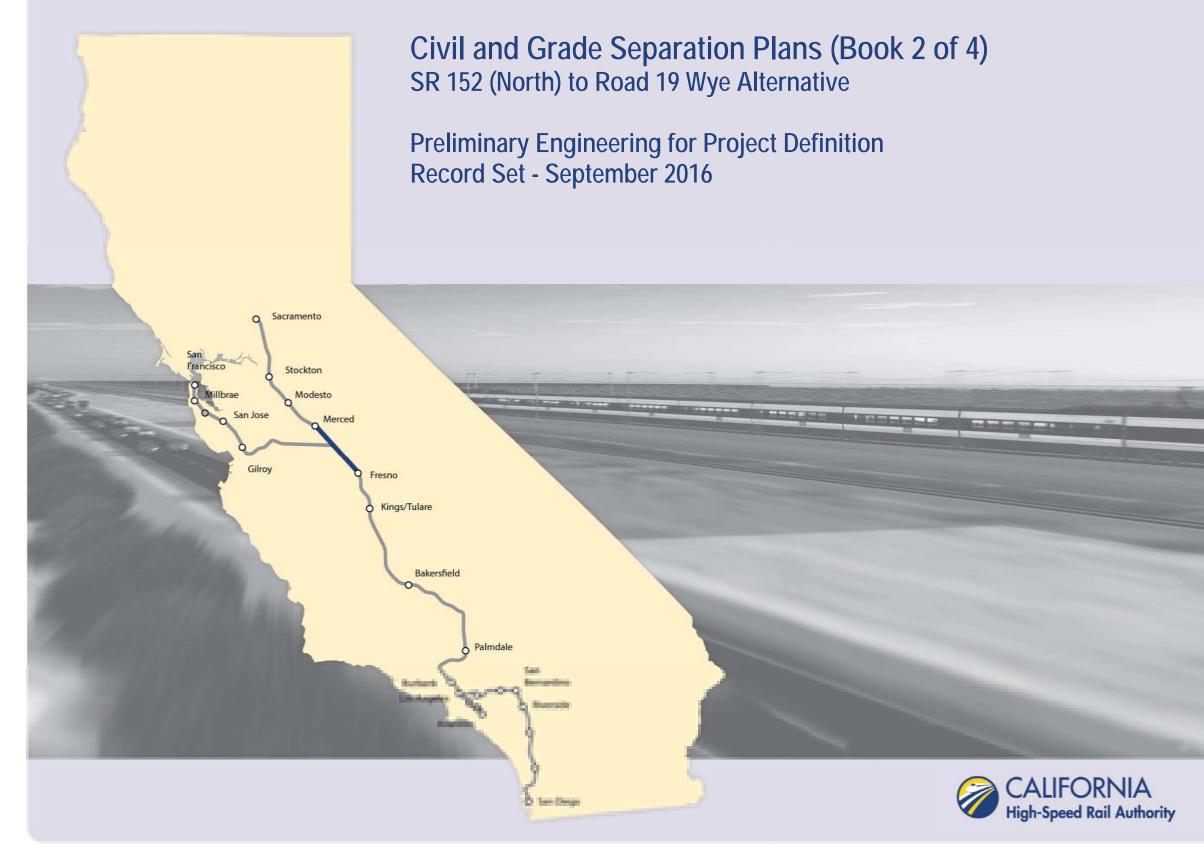





of Transportation

		11	NDEX OF DRAWINGS	
DRAWING NO.	SECTION	ALIGNMENT / PLAN SET	TITLE	DESCRIPTION
	F		GENERAL	
CV-B0001	CENTRAL VALLEY WYE	CIVIL AND GRADE SEPARATION PLANS	COVER	
CV-B0002	CENTRAL VALLEY WYE	CIVIL AND GRADE SEPARATION PLANS	INDEX OF DRAWINGS	SHEET 1 OF 17
CV-B0003	CENTRAL VALLEY WYE	CIVIL AND GRADE SEPARATION PLANS	INDEX OF DRAWINGS	SHEET 2 OF 17
CV-B0004	CENTRAL VALLEY WYE	CIVIL AND GRADE SEPARATION PLANS	INDEX OF DRAWINGS	SHEET 3 OF 17
CV-B0005	CENTRAL VALLEY WYE	CIVIL AND GRADE SEPARATION PLANS	INDEX OF DRAWINGS	SHEET 4 OF 17
CV-B0006	CENTRAL VALLEY WYE	CIVIL AND GRADE SEPARATION PLANS	INDEX OF DRAWINGS	SHEET 5 OF 17
CV-B0007	CENTRAL VALLEY WYE	CIVIL AND GRADE SEPARATION PLANS	INDEX OF DRAWINGS	SHEET 6 OF 17
CV-B0008	CENTRAL VALLEY WYE	CIVIL AND GRADE SEPARATION PLANS	INDEX OF DRAWINGS	SHEET 7 OF 17
CV-B0009	CENTRAL VALLEY WYE	CIVIL AND GRADE SEPARATION PLANS	INDEX OF DRAWINGS	SHEET 8 OF 17
CV-B0010	CENTRAL VALLEY WYE	CIVIL AND GRADE SEPARATION PLANS	INDEX OF DRAWINGS	SHEET 9 OF 17
CV-B0011	CENTRAL VALLEY WYE	CIVIL AND GRADE SEPARATION PLANS	INDEX OF DRAWINGS	SHEET 10 OF 17
CV-B0012	CENTRAL VALLEY WYE	CIVIL AND GRADE SEPARATION PLANS	INDEX OF DRAWINGS	SHEET 11 OF 17
CV-B0013	CENTRAL VALLEY WYE	CIVIL AND GRADE SEPARATION PLANS	INDEX OF DRAWINGS	SHEET 12 OF 17
CV-B0014	CENTRAL VALLEY WYE	CIVIL AND GRADE SEPARATION PLANS	INDEX OF DRAWINGS	SHEET 13 OF 17
CV-B0015	CENTRAL VALLEY WYE	CIVIL AND GRADE SEPARATION PLANS	INDEX OF DRAWINGS	SHEET 14 OF 17
CV-B0016	CENTRAL VALLEY WYE	CIVIL AND GRADE SEPARATION PLANS	INDEX OF DRAWINGS	SHEET 15 OF 17
CV-B0017	CENTRAL VALLEY WYE	CIVIL AND GRADE SEPARATION PLANS	INDEX OF DRAWINGS	SHEET 16 OF 17
CV-B0018	CENTRAL VALLEY WYE	CIVIL AND GRADE SEPARATION PLANS	INDEX OF DRAWINGS	SHEET 17 OF 17
CV-B0020	CENTRAL VALLEY WYE	CIVIL AND GRADE SEPARATION PLANS	ABBREVIATIONS	SHEET 1 OF 2
CV-B0021	CENTRAL VALLEY WYE	CIVIL AND GRADE SEPARATION PLANS	ABBREVIATIONS	SHEET 2 OF 2
CV-B4000	CENTRAL VALLEY WYE	CIVIL AND GRADE SEPARATION PLANS	LOCATION PLAN	
CV-B0030	CENTRAL VALLEY WYE	CIVIL AND GRADE SEPARATION PLANS	GENERAL NOTES	
		SR 152 (NORTH) TO ROAD 13 WYE ALTERNATIVE	
CV-B4050-A	CENTRAL VALLEY WYE	SR 152 (NORTH) TO ROAD 13 WYE ALTERNATIVE	KEY MAP	SHEET 1 OF 4
CV-B4051-A	CENTRAL VALLEY WYE	SR 152 (NORTH) TO ROAD 13 WYE ALTERNATIVE	ΚΕΥ ΜΑΡ	SHEET 2 OF 4
CV-B4052-A	CENTRAL VALLEY WYE	SR 152 (NORTH) TO ROAD 13 WYE ALTERNATIVE	ΚΕΥ ΜΑΡ	SHEET 3 OF 4
CV-B4053-A	CENTRAL VALLEY WYE	SR 152 (NORTH) TO ROAD 13 WYE ALTERNATIVE	ΚΕΥ ΜΑΡ	SHEET 4 OF 4
CV-B0060-A	CENTRAL VALLEY WYE	SR 152 (NORTH) TO ROAD 13 WYE ALTERNATIVE	GEOMETRY DATA TABLE	SHEET 1 OF 6
CV-B0061-A	CENTRAL VALLEY WYE	SR 152 (NORTH) TO ROAD 13 WYE ALTERNATIVE	GEOMETRY DATA TABLE	SHEET 2 OF 6
CV-B0062-A	CENTRAL VALLEY WYE	SR 152 (NORTH) TO ROAD 13 WYE ALTERNATIVE	GEOMETRY DATA TABLE	SHEET 3 OF 6
CV-B0063-A	CENTRAL VALLEY WYE	SR 152 (NORTH) TO ROAD 13 WYE ALTERNATIVE	GEOMETRY DATA TABLE	SHEET 4 OF 6
CV-B0064-A	CENTRAL VALLEY WYE	SR 152 (NORTH) TO ROAD 13 WYE ALTERNATIVE	GEOMETRY DATA TABLE	SHEET 5 OF 6
CV-B0065-A	CENTRAL VALLEY WYE	SR 152 (NORTH) TO ROAD 13 WYE ALTERNATIVE	GEOMETRY DATA TABLE	SHEET 6 OF 6
CV-B0070-A	CENTRAL VALLEY WYE	SR 152 (NORTH) TO ROAD 13 WYE ALTERNATIVE	UTILITY CONFLICT TABLE	SHEET 1 OF 4
CV-B0071-A	CENTRAL VALLEY WYE	SR 152 (NORTH) TO ROAD 13 WYE ALTERNATIVE	UTILITY CONFLICT TABLE	SHEET 2 OF 4
CV-B0072-A	CENTRAL VALLEY WYE	SR 152 (NORTH) TO ROAD 13 WYE ALTERNATIVE	UTILITY CONFLICT TABLE	SHEET 3 OF 4
CV-B0073-A	CENTRAL VALLEY WYE	SR 152 (NORTH) TO ROAD 13 WYE ALTERNATIVE	UTILITY CONFLICT TABLE	SHEET 4 OF 4
CV-B0080-A	CENTRAL VALLEY WYE	SR 152 (NORTH) TO ROAD 13 WYE ALTERNATIVE	TYPICAL SECTION	SHEET 1 OF 3
CV-B0081-A	CENTRAL VALLEY WYE	SR 152 (NORTH) TO ROAD 13 WYE ALTERNATIVE	TYPICAL SECTION	SHEET 2 OF 3

p0021811 06-9	EV DATE	BY CHK APP	DESCRIPTION	DESIGNED BY S. WELLS DRAWN BY W. JOHNSEN CHECKED BY J. RAY IN CHARGE C. LEMLEY DATE 09/09/2016	RECORD SET 15% design Submittal Not for Construction	PARSONS	CALIFORNIA HIGH-SPEED RAIL AUTHORITY	CALIFORM M
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		SHE	ET 1	OF 1	7		

CONTRACT NO. HSR08-05 DRAWING NO. CV-B0002

SCALE NO SCALE

		Ι	NDEX OF DRAWINGS			
DRAWING NO.	SECTION	ALIGNMENT / PLAN SET	TITLE	DESCRIPTION		
CV-B0082-A	CENTRAL VALLEY WYE	SR 152 (NORTH) TO ROAD 13 WYE ALTERNATIVE	TYPICAL SECTION	SHEET 3 OF 3		
CV-S1010-A	CENTRAL VALLEY WYE	SR 152 (NORTH) TO ROAD 13 WYE ALTERNATIVE	CIVIL PLAN	SJD-FRE STA 5338+00 TO 5	5394+00	
CV-S1020-A	CENTRAL VALLEY WYE	SR 152 (NORTH) TO ROAD 13 WYE ALTERNATIVE	CIVIL PLAN	SJD-FRE STA 5394+00 TO 5	5450+00	
CV-S1030-A	CENTRAL VALLEY WYE	SR 152 (NORTH) TO ROAD 13 WYE ALTERNATIVE	CIVIL PLAN	SJD-FRE STA 5450+00 TO 5	5506+00	
CV-S1040-A	CENTRAL VALLEY WYE	SR 152 (NORTH) TO ROAD 13 WYE ALTERNATIVE	CIVIL PLAN	SJD-FRE STA 5506+00 TO 5	5562+00	
CV-S1050-A	CENTRAL VALLEY WYE	SR 152 (NORTH) TO ROAD 13 WYE ALTERNATIVE	CIVIL PLAN	SJD-FRE STA 5562+00 TO 5	5618+00	
CV-S1060-A	CENTRAL VALLEY WYE	SR 152 (NORTH) TO ROAD 13 WYE ALTERNATIVE	CIVIL PLAN	SJD-FRE STA 5618+00 TO 5	5674+00	
CV-S1070-A	CENTRAL VALLEY WYE	SR 152 (NORTH) TO ROAD 13 WYE ALTERNATIVE	CIVIL PLAN	SJD-FRE STA 5674+00 TO 5	5730+00	
CV-S1080-A	CENTRAL VALLEY WYE	SR 152 (NORTH) TO ROAD 13 WYE ALTERNATIVE	CIVIL PLAN	SJD-FRE STA 5730+00 TO 5	5786+00	
CV-S1090-A	CENTRAL VALLEY WYE	SR 152 (NORTH) TO ROAD 13 WYE ALTERNATIVE	CIVIL PLAN	SJD-FRE STA 5786+00 TO 5	5842+00	
CV-S1100-A	CENTRAL VALLEY WYE	SR 152 (NORTH) TO ROAD 13 WYE ALTERNATIVE	CIVIL PLAN	SJD-FRE STA 5842+00 TO S	5898+00	
CV-S1110-A	CENTRAL VALLEY WYE	SR 152 (NORTH) TO ROAD 13 WYE ALTERNATIVE	CIVIL PLAN	SJD-FRE STA 5898+00 TO 5	5954+00	
CV-S1120-A	CENTRAL VALLEY WYE	SR 152 (NORTH) TO ROAD 13 WYE ALTERNATIVE	CIVIL PLAN	SJD-FRE STA 5954+00 TO 6	5010+00	
CV-S1130-A	CENTRAL VALLEY WYE	SR 152 (NORTH) TO ROAD 13 WYE ALTERNATIVE	CIVIL PLAN	SJD-FRE STA 6010+00 TO 6	5066+00	
CV-S1140-A	CENTRAL VALLEY WYE	SR 152 (NORTH) TO ROAD 13 WYE ALTERNATIVE	CIVIL PLAN	SJD-FRE STA 6066+00 TO 6	5122+00	
CV-S1150-A	CENTRAL VALLEY WYE	SR 152 (NORTH) TO ROAD 13 WYE ALTERNATIVE	CIVIL PLAN	SJD-FRE STA 6122+00 TO 6	5178+00	
CV-S1160-A	CENTRAL VALLEY WYE	SR 152 (NORTH) TO ROAD 13 WYE ALTERNATIVE	CIVIL PLAN	SJD-FRE STA 6178+00 TO 6	6234+00	
CV-S1161-A	CENTRAL VALLEY WYE	SR 152 (NORTH) TO ROAD 13 WYE ALTERNATIVE	CIVIL PLAN	SJD-FRE ACCESS ROA	D	
CV-S1170-A	CENTRAL VALLEY WYE	SR 152 (NORTH) TO ROAD 13 WYE ALTERNATIVE	CIVIL PLAN	SJD-FRE STA 6234+00 TO 6	5290+00	
CV-S1180-A	CENTRAL VALLEY WYE	SR 152 (NORTH) TO ROAD 13 WYE ALTERNATIVE	CIVIL PLAN	SJD-FRE STA 6290+00 TO 6	5346+00	
CV-S1190-A	CENTRAL VALLEY WYE	SR 152 (NORTH) TO ROAD 13 WYE ALTERNATIVE	CIVIL PLAN	SJD-FRE STA 6346+00 TO 6	6402+00	
CV-S1200-A	CENTRAL VALLEY WYE	SR 152 (NORTH) TO ROAD 13 WYE ALTERNATIVE	CIVIL PLAN	SJD-FRE STA 6402+00 TO 6	6458+00	
CV-S1210-A	CENTRAL VALLEY WYE	SR 152 (NORTH) TO ROAD 13 WYE ALTERNATIVE	CIVIL PLAN	SJD-FRE STA 6458+00 TO 6	5514+00	
CV-S1220-A	CENTRAL VALLEY WYE	SR 152 (NORTH) TO ROAD 13 WYE ALTERNATIVE	CIVIL PLAN	SJD-FRE STA 6514+00 TO 6	5570+00	
CV-S1230-A	CENTRAL VALLEY WYE	SR 152 (NORTH) TO ROAD 13 WYE ALTERNATIVE	CIVIL PLAN	SJD-FRE STA 6570+00 TO 6	6626+00	
CV-S1240-A	CENTRAL VALLEY WYE	SR 152 (NORTH) TO ROAD 13 WYE ALTERNATIVE	CIVIL PLAN	SJD-FRE STA 6626+00 TO 6	6682+00	
CV-S1241-A	CENTRAL VALLEY WYE	SR 152 (NORTH) TO ROAD 13 WYE ALTERNATIVE	CIVIL PLAN	SJD-FRE ACCESS ROA	D	
CV-S1250-A	CENTRAL VALLEY WYE	SR 152 (NORTH) TO ROAD 13 WYE ALTERNATIVE	CIVIL PLAN	SJD-FRE STA 6682+00 TO 6	5738+00	
CV-S1260-A	CENTRAL VALLEY WYE	SR 152 (NORTH) TO ROAD 13 WYE ALTERNATIVE	CIVIL PLAN	SJD-FRE STA 6738+00 TO 6	5794+00	
CV-S1270-A	CENTRAL VALLEY WYE	SR 152 (NORTH) TO ROAD 13 WYE ALTERNATIVE	CIVIL PLAN	SJD-FRE STA 6794+00 TO 6	6850+00	
CV-S1280-A	CENTRAL VALLEY WYE	SR 152 (NORTH) TO ROAD 13 WYE ALTERNATIVE	CIVIL PLAN	SJD-FRE STA 6850+00 TO 6	5906+00	
CV-S1290-A	CENTRAL VALLEY WYE	SR 152 (NORTH) TO ROAD 13 WYE ALTERNATIVE	CIVIL PLAN	SJD-FRE STA 6906+00 TO 6	5962+00	
CV-S1291-A	CENTRAL VALLEY WYE	SR 152 (NORTH) TO ROAD 13 WYE ALTERNATIVE	CIVIL PLAN	SJD-FRE ACCESS ROA		
CV-S1300-A	CENTRAL VALLEY WYE	SR 152 (NORTH) TO ROAD 13 WYE ALTERNATIVE	CIVIL PLAN	SJD-FRE STA 6962+00 TO		
CV-S1310-A	CENTRAL VALLEY WYE	SR 152 (NORTH) TO ROAD 13 WYE ALTERNATIVE	CIVIL PLAN	SJD-FRE STA 7018+00 TO		
CV-S1320-A	CENTRAL VALLEY WYE	SR 152 (NORTH) TO ROAD 13 WYE ALTERNATIVE	CIVIL PLAN	SJD-FRE STA 7074+00 TO		
CV-S1330-A	CENTRAL VALLEY WYE	SR 152 (NORTH) TO ROAD 13 WYE ALTERNATIVE	CIVIL PLAN	SJD-FRE STA 7130+00 TO 71		
CV-S1410-A	CENTRAL VALLEY WYE	SR 152 (NORTH) TO ROAD 13 WYE ALTERNATIVE	CIVIL PLAN	MER-FRE STA 14946+67.02 TO		
CV-S1420-A	CENTRAL VALLEY WYE	SR 152 (NORTH) TO ROAD 13 WYE ALTERNATIVE	CIVIL PLAN	MER-FRE STA 14996+00 TO 7		
CV-S1430-A	CENTRAL VALLEY WYE	SR 152 (NORTH) TO ROAD 13 WYE ALTERNATIVE	CIVIL PLAN	MER-FRE STA 15052+00 TO 7		
CV-S1440-A	CENTRAL VALLEY WYE	SR 152 (NORTH) TO ROAD 13 WYE ALTERNATIVE	CIVIL PLAN	MER-FRE STA 15108+00 TO 7		
		DESIGNED BY S. WELLS DRAWN BY W. JOHNSEN CHECKED BY J. RAY IN CHARGE C. LEMLEY DRAWNEY CONSTRUCTION	RSONS		HIGH-SPEED TRAIN PROJECT ED TO FRESNO SECTION CENTRAL VALLEY WYE AND GRADE SEPARATION PLANS INDEX OF DRAWINGS	CONTRACT N HSR08 DRAWING NO. CV-BO SCALE NO SC SHEET NO.

SEP-201613:58 MF-CV-B00

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p0021811

			INDEX OF DRAWINGS		
DRAWING NO.	SECTION	ALIGNMENT / PLAN SET	TITLE	DESCRIPTION	1
CV-S1450-A	CENTRAL VALLEY WYE	SR 152 (NORTH) TO ROAD 13 WYE ALTERNATIVE	CIVIL PLAN	MER-FRE STA 15164+00 TO 15220+00	1
CV-S1460-A	CENTRAL VALLEY WYE	SR 152 (NORTH) TO ROAD 13 WYE ALTERNATIVE	CIVIL PLAN	MER-FRE STA 15220+00 TO 15276+00	1
CV-S1470-A	CENTRAL VALLEY WYE	SR 152 (NORTH) TO ROAD 13 WYE ALTERNATIVE	CIVIL PLAN	MER-FRE STA 15276+00 TO 15332+00	1
CV-S1480-A	CENTRAL VALLEY WYE	SR 152 (NORTH) TO ROAD 13 WYE ALTERNATIVE	CIVIL PLAN	MER-FRE STA 15332+00 TO 15388+00	
CV-S1490-A	CENTRAL VALLEY WYE	SR 152 (NORTH) TO ROAD 13 WYE ALTERNATIVE	CIVIL PLAN	MER-FRE STA 15388+00 TO 15444+00	1
CV-S1500-A	CENTRAL VALLEY WYE	SR 152 (NORTH) TO ROAD 13 WYE ALTERNATIVE	CIVIL PLAN	MER-FRE STA 15444+00 TO 15500+00	1
CV-S1510-A	CENTRAL VALLEY WYE	SR 152 (NORTH) TO ROAD 13 WYE ALTERNATIVE	CIVIL PLAN	MER-FRE STA 15500+00 TO 15556+00	1
CV-S1520-A	CENTRAL VALLEY WYE	SR 152 (NORTH) TO ROAD 13 WYE ALTERNATIVE	CIVIL PLAN	MER-FRE STA 15556+00 TO 15612+00	4
CV-S1530-A	CENTRAL VALLEY WYE	SR 152 (NORTH) TO ROAD 13 WYE ALTERNATIVE	CIVIL PLAN	MER-FRE STA 15612+00 TO 15655+00	4
CV-S1610-A	CENTRAL VALLEY WYE	SR 152 (NORTH) TO ROAD 13 WYE ALTERNATIVE	CIVIL PLAN	SJD-MER STA 36246+00 TO 36302+00	4
CV-S1620-A	CENTRAL VALLEY WYE	SR 152 (NORTH) TO ROAD 13 WYE ALTERNATIVE	CIVIL PLAN	SJD-MER STA 36302+00 TO 36358+00	4
CV-S1630-A	CENTRAL VALLEY WYE	SR 152 (NORTH) TO ROAD 13 WYE ALTERNATIVE	CIVIL PLAN	SJD-MER STA 36358+00 TO 36414+00	4
CV-S1631-A	CENTRAL VALLEY WYE	SR 152 (NORTH) TO ROAD 13 WYE ALTERNATIVE	CIVIL PLAN	SJD-MER ACCESS ROAD	1
CV-S1640-A	CENTRAL VALLEY WYE	SR 152 (NORTH) TO ROAD 13 WYE ALTERNATIVE	CIVIL PLAN	SJD-MER STA 36414+00 TO 36470+00	1
CV-S1650-A	CENTRAL VALLEY WYE	SR 152 (NORTH) TO ROAD 13 WYE ALTERNATIVE	CIVIL PLAN	SJD-MER STA 36470+00 TO 36526+00	1
CV-S1660-A	CENTRAL VALLEY WYE	SR 152 (NORTH) TO ROAD 13 WYE ALTERNATIVE	CIVIL PLAN	SJD-MER STA 36526+00 TO 36542+78.70	1
CV-R1030-A	CENTRAL VALLEY WYE	SR 152 (NORTH) TO ROAD 13 WYE ALTERNATIVE	PLAN AND PROFILE	HENRY MILLER ROAD REALIGNMENT	1
CV-R1031-A	CENTRAL VALLEY WYE	SR 152 (NORTH) TO ROAD 13 WYE ALTERNATIVE	PLAN AND PROFILE	HENRY MILLER ROAD REALIGNMENT	1
CV-R1032-A	CENTRAL VALLEY WYE	SR 152 (NORTH) TO ROAD 13 WYE ALTERNATIVE	PLAN AND PROFILE	HENRY MILLER ROAD REALIGNMENT	1
CV-R1033-A	CENTRAL VALLEY WYE	SR 152 (NORTH) TO ROAD 13 WYE ALTERNATIVE	PLAN AND PROFILE	HENRY MILLER ROAD REALIGNMENT	1
CV-R1050-A	CENTRAL VALLEY WYE	SR 152 (NORTH) TO ROAD 13 WYE ALTERNATIVE	PLAN AND PROFILE	INDIANA ROAD GRADE SEPARATION	1
CV-R1051-A	CENTRAL VALLEY WYE	SR 152 (NORTH) TO ROAD 13 WYE ALTERNATIVE	PLAN AND PROFILE	INDIANA ROAD GRADE SEPARATION	1
CV-R1090-A	CENTRAL VALLEY WYE	SR 152 (NORTH) TO ROAD 13 WYE ALTERNATIVE	PLAN AND PROFILE	COYOTE ROAD REALIGNMENT	1
CV-R1091-A	CENTRAL VALLEY WYE	SR 152 (NORTH) TO ROAD 13 WYE ALTERNATIVE	PLAN AND PROFILE	COYOTE ROAD REALIGNMENT	1
CV-R1100-A	CENTRAL VALLEY WYE	SR 152 (NORTH) TO ROAD 13 WYE ALTERNATIVE	PLAN AND PROFILE	SR 152 REALIGNMENT AT SR 59	1
CV-R1101-A	CENTRAL VALLEY WYE	SR 152 (NORTH) TO ROAD 13 WYE ALTERNATIVE	PLAN AND PROFILE	SR 152 REALIGNMENT AT SR 59	1
CV-R1102-A	CENTRAL VALLEY WYE	SR 152 (NORTH) TO ROAD 13 WYE ALTERNATIVE	PLAN AND PROFILE	SR 152 REALIGNMENT AT SR 59	1
CV-R1103-A	CENTRAL VALLEY WYE	SR 152 (NORTH) TO ROAD 13 WYE ALTERNATIVE	PLAN AND PROFILE	SR 152 REALIGNMENT AT SR 59	1
CV-R1104-A	CENTRAL VALLEY WYE	SR 152 (NORTH) TO ROAD 13 WYE ALTERNATIVE	PLAN AND PROFILE	SR 59/SR 152 EB OFF RAMP GRADE SEPARATION	1
CV-R1105-A	CENTRAL VALLEY WYE	SR 152 (NORTH) TO ROAD 13 WYE ALTERNATIVE	PLAN AND PROFILE	SR 59/SR 152 EB OFF RAMP GRADE SEPARATION	1
CV-R1106-A	CENTRAL VALLEY WYE	SR 152 (NORTH) TO ROAD 13 WYE ALTERNATIVE	PLAN AND PROFILE	SR 59/SR 152 WB ON RAMP GRADE SEPARATION	1
CV-R1107-A	CENTRAL VALLEY WYE	SR 152 (NORTH) TO ROAD 13 WYE ALTERNATIVE	PLAN AND PROFILE	SR 59/SR 152 WB ON RAMP GRADE SEPARATION	1
CV-R1108-A	CENTRAL VALLEY WYE	SR 152 (NORTH) TO ROAD 13 WYE ALTERNATIVE	PLAN AND PROFILE	SR 59/SR 152 WB OFF RAMP GRADE SEPARATION	1
CV-R1109-A	CENTRAL VALLEY WYE	SR 152 (NORTH) TO ROAD 13 WYE ALTERNATIVE	PLAN AND PROFILE	SR 59/SR 152 WB OFF RAMP GRADE SEPARATION	1
CV-R1110-A	CENTRAL VALLEY WYE	SR 152 (NORTH) TO ROAD 13 WYE ALTERNATIVE	PLAN AND PROFILE	SR 59/SR 152 EB LOOP ON RAMP	1
CV-R1111-A	CENTRAL VALLEY WYE	SR 152 (NORTH) TO ROAD 13 WYE ALTERNATIVE	PLAN AND PROFILE	ROAD 4/LINCOLN ROAD GRADE SEPARATION	ł
CV-R1112-A	CENTRAL VALLEY WYE	SR 152 (NORTH) TO ROAD 13 WYE ALTERNATIVE	PLAN AND PROFILE	ROAD 4/LINCOLN ROAD GRADE SEPARATION	1
CV-R1160-A	CENTRAL VALLEY WYE	SR 152 (NORTH) TO ROAD 13 WYE ALTERNATIVE	PLAN AND PROFILE	ROAD 9/HEMLOCK ROAD GRADE SEPARATION	1
CV-R1161-A	CENTRAL VALLEY WYE	SR 152 (NORTH) TO ROAD 13 WYE ALTERNATIVE	PLAN AND PROFILE	ROAD 9/HEMLOCK ROAD GRADE SEPARATION	1
CV-R1162-A	CENTRAL VALLEY WYE	SR 152 (NORTH) TO ROAD 13 WYE ALTERNATIVE	PLAN AND PROFILE	SR 152 REALIGNMENT AT ROAD 9	1
CV-R1163-A	CENTRAL VALLEY WYE	SR 152 (NORTH) TO ROAD 13 WYE ALTERNATIVE	PLAN AND PROFILE	SR 152 REALIGNMENT AT ROAD 9	·
		DESIGNED BY SWELLS RECORD SET		CALIFORNIA HIGH-SPEED TRA	
+		URANN BY W. JOHNSEN CHECKED BY SUBMITTAL		MERCED TO FRESNO SEC Central valley wye	TION
<u> </u>			ARSONS		PLANS
				IFORNIA INDEX OF DRAWINGS	L

p0021811 06-

· · ·			INDEX OF DRAWINGS		
DRAWING NO.	SECTION	ALIGNMENT / PLAN SET	TITLE	DESCRIPTION	
CV-R1164-A	CENTRAL VALLEY WYE	SR 152 (NORTH) TO ROAD 13 WYE ALTERNATIVE	PLAN AND PROFILE	SR 152 REALIGNMENT AT ROAD 9	
CV-R1165-A	CENTRAL VALLEY WYE	SR 152 (NORTH) TO ROAD 13 WYE ALTERNATIVE	PLAN AND PROFILE	ROAD 9/SR 152 EB OFF RAMP	
CV-R1166-A	CENTRAL VALLEY WYE	SR 152 (NORTH) TO ROAD 13 WYE ALTERNATIVE	PLAN AND PROFILE	ROAD 9/SR 152 EB ON RAMP	
CV-R1167-A	CENTRAL VALLEY WYE	SR 152 (NORTH) TO ROAD 13 WYE ALTERNATIVE	PLAN AND PROFILE	ROAD 9/SR 152 LOOP RAMP	
CV-R1168-A	CENTRAL VALLEY WYE	SR 152 (NORTH) TO ROAD 13 WYE ALTERNATIVE	PLAN AND PROFILE	ROAD 9/SR 152 WB ON RAMP	
CV-R1169-A	CENTRAL VALLEY WYE	SR 152 (NORTH) TO ROAD 13 WYE ALTERNATIVE	PLAN AND PROFILE	ROAD 9/SR 152 WB OFF RAMP	
CV-R1190-A	CENTRAL VALLEY WYE	SR 152 (NORTH) TO ROAD 13 WYE ALTERNATIVE	PLAN AND PROFILE	ROAD 12 GRADE SEPARATION	
CV-R1191-A	CENTRAL VALLEY WYE	SR 152 (NORTH) TO ROAD 13 WYE ALTERNATIVE	PLAN AND PROFILE	ROAD 12 GRADE SEPARATION	
CV-R1192-A	CENTRAL VALLEY WYE	SR 152 (NORTH) TO ROAD 13 WYE ALTERNATIVE	PLAN AND PROFILE	SR 152 REALIGNMENT AT ROAD 12	
CV-R1193-A	CENTRAL VALLEY WYE	SR 152 (NORTH) TO ROAD 13 WYE ALTERNATIVE	PLAN AND PROFILE	SR 152 REALIGNMENT AT ROAD 12	
CV-R1194-A	CENTRAL VALLEY WYE	SR 152 (NORTH) TO ROAD 13 WYE ALTERNATIVE	PLAN AND PROFILE	SR 152 REALIGNMENT AT ROAD 12	
CV-R1200-A	CENTRAL VALLEY WYE	SR 152 (NORTH) TO ROAD 13 WYE ALTERNATIVE	PLAN AND PROFILE	SR 152 REALIGNMENT AT SR 233	
CV-R1201-A	CENTRAL VALLEY WYE	SR 152 (NORTH) TO ROAD 13 WYE ALTERNATIVE	PLAN AND PROFILE	SR 152 REALIGNMENT AT SR 233	
CV-R1202-A	CENTRAL VALLEY WYE	SR 152 (NORTH) TO ROAD 13 WYE ALTERNATIVE	PLAN AND PROFILE	SR 152 REALIGNMENT AT SR 233	
CV-R1203-A	CENTRAL VALLEY WYE	SR 152 (NORTH) TO ROAD 13 WYE ALTERNATIVE	PLAN AND PROFILE	SR 233/SR 152 EB OFF RAMP	
CV-R1204-A	CENTRAL VALLEY WYE	SR 152 (NORTH) TO ROAD 13 WYE ALTERNATIVE	PLAN AND PROFILE	SR 233/SR 152 EB LOOP RAMP	
CV-R1205-A	CENTRAL VALLEY WYE	SR 152 (NORTH) TO ROAD 13 WYE ALTERNATIVE	PLAN AND PROFILE	SR 233/SR 152 WB ON RAMP	
CV-R1210-A	CENTRAL VALLEY WYE	SR 152 (NORTH) TO ROAD 13 WYE ALTERNATIVE	PLAN AND PROFILE	SR 233/ROBERTSON BLVD GRADE SEPARATION	—
CV-R1211-A	CENTRAL VALLEY WYE	SR 152 (NORTH) TO ROAD 13 WYE ALTERNATIVE	PLAN AND PROFILE	SR 233/ROBERTSON BLVD GRADE SEPARATION	
CV-R1212-A	CENTRAL VALLEY WYE	SR 152 (NORTH) TO ROAD 13 WYE ALTERNATIVE	PLAN AND PROFILE	SR 233/SR 152 EB ON RAMP	—
CV-R1213-A	CENTRAL VALLEY WYE	SR 152 (NORTH) TO ROAD 13 WYE ALTERNATIVE	PLAN AND PROFILE	SR 233/SR 152 EB ON RAMP	
CV-R1214-A	CENTRAL VALLEY WYE	SR 152 (NORTH) TO ROAD 13 WYE ALTERNATIVE	PLAN AND PROFILE	SR 233/SR 152 WB OFF RAMP	—
CV-R1215-A	CENTRAL VALLEY WYE	SR 152 (NORTH) TO ROAD 13 WYE ALTERNATIVE	PLAN AND PROFILE	CATES COURT REALIGNMENT	—
CV-R1224-A	CENTRAL VALLEY WYE	SR 152 (NORTH) TO ROAD 13 WYE ALTERNATIVE	PLAN AND PROFILE	SR 152 REALIGNMENT AT ROAD 16	
CV-R1225-A	CENTRAL VALLEY WYE	SR 152 (NORTH) TO ROAD 13 WYE ALTERNATIVE	PLAN AND PROFILE	SR 152 REALIGNMENT AT ROAD 16	
CV-R1226-A	CENTRAL VALLEY WYE	SR 152 (NORTH) TO ROAD 13 WYE ALTERNATIVE	PLAN AND PROFILE	SR 152 REALIGNMENT AT ROAD 16	—
CV-R1227-A	CENTRAL VALLEY WYE	SR 152 (NORTH) TO ROAD 13 WYE ALTERNATIVE	PLAN AND PROFILE	ROAD 16/SR 152 EB OFF RAMP	
CV-R1228-A	CENTRAL VALLEY WYE	SR 152 (NORTH) TO ROAD 13 WYE ALTERNATIVE	PLAN AND PROFILE	ROAD 16/SR 152 EB OFF RAMP	
CV-R1229-A	CENTRAL VALLEY WYE	SR 152 (NORTH) TO ROAD 13 WYE ALTERNATIVE	PLAN AND PROFILE	ROAD 16/SR 152 WB ON RAMP	
CV-R1230-A	CENTRAL VALLEY WYE	SR 152 (NORTH) TO ROAD 13 WYE ALTERNATIVE	PLAN AND PROFILE	ROAD 16 GRADE SEPARATION	
CV-R1231-A	CENTRAL VALLEY WYE	SR 152 (NORTH) TO ROAD 13 WYE ALTERNATIVE	PLAN AND PROFILE	ROAD 16 GRADE SEPARATION	
CV-R1232-A	CENTRAL VALLEY WYE	SR 152 (NORTH) TO ROAD 13 WYE ALTERNATIVE	PLAN AND PROFILE	ROAD 16 GRADE SEPARATION ROAD 16/SR 152 EB ON RAMP	
CV-R1232-A	CENTRAL VALLEY WYE	SR 152 (NORTH) TO ROAD 13 WYE ALTERNATIVE	PLAN AND PROFILE		
			PLAN AND PROFILE	ROAD 16/SR 152 EB LOOP RAMP	
CV-R1234-A	CENTRAL VALLEY WYE	SR 152 (NORTH) TO ROAD 13 WYE ALTERNATIVE		ROAD 16/SR 152 WB OFF RAMP	
CV-R1235-A	CENTRAL VALLEY WYE	SR 152 (NORTH) TO ROAD 13 WYE ALTERNATIVE	PLAN AND PROFILE	ROAD 16 CONNECTOR REALIGNMENT	
CV-R1240-A	CENTRAL VALLEY WYE	SR 152 (NORTH) TO ROAD 13 WYE ALTERNATIVE	PLAN AND PROFILE	ROAD 17 1/2 GRADE SEPARATION	
CV-R1241-A	CENTRAL VALLEY WYE	SR 152 (NORTH) TO ROAD 13 WYE ALTERNATIVE	PLAN AND PROFILE	ROAD 17 1/2 GRADE SEPARATION	
CV-R1242-A	CENTRAL VALLEY WYE	SR 152 (NORTH) TO ROAD 13 WYE ALTERNATIVE	PLAN AND PROFILE	ROAD 17 1/2 GRADE SEPARATION	
CV-R1250-A	CENTRAL VALLEY WYE	SR 152 (NORTH) TO ROAD 13 WYE ALTERNATIVE	PLAN AND PROFILE	FAIRMEAD BOULEVARD REALIGNMENT	
CV-R1260-A	CENTRAL VALLEY WYE	SR 152 (NORTH) TO ROAD 13 WYE ALTERNATIVE	PLAN AND PROFILE	ROAD 20 GRADE SEPARATION	
CV-R1261-A	CENTRAL VALLEY WYE	SR 152 (NORTH) TO ROAD 13 WYE ALTERNATIVE	PLAN AND PROFILE	ROAD 20 GRADE SEPARATION	
		DESIGNED BY S. WELLS RECORD SET		CALIFORNIA HIGH-SPEED T	
		W. JOHNSEN		MERCED TO FRESNO S Central valley wy	
			ARSONS	CIVIL AND GRADE SEPARATIO	ON PLANS
		C. LEMLEY CONSTRUCTION		INDEX OF DRAWINGS	້ວ

p0021811 06-5

DRAWING NO.SECTIONCV-R1280-ACENTRAL VALLEY WYECV-R1281-ACENTRAL VALLEY WYECV-R1290-ACENTRAL VALLEY WYECV-R1310-ACENTRAL VALLEY WYECV-R1311-ACENTRAL VALLEY WYECV-R1311-ACENTRAL VALLEY WYECV-R1313-ACENTRAL VALLEY WYECV-R1314-ACENTRAL VALLEY WYECV-R1320-ACENTRAL VALLEY WYECV-R1321-ACENTRAL VALLEY WYECV-R1450-ACENTRAL VALLEY WYECV-R1471-ACENTRAL VALLEY WYECV-R1470-ACENTRAL VALLEY WYECV-R1470-ACENTRAL VALLEY WYECV-R1480-ACENTRAL VALLEY WYECV-R1481-ACENTRAL VALLEY WYECV-R1481-ACENTRAL VALLEY WYECV-R1480-ACENTRAL VALLEY WYECV-R1481-ACENTRAL VALLEY WYECV-R1490-ACENTRAL VALLEY WYECV-R1490-ACENTRAL VALLEY WYECV-R1491-ACENTRAL VALLEY WYE	ALIGNMENT / PLAN SET SR 152 (NORTH) TO ROAD 13 WYE ALTERNATIVE	INDEX OF DRAWINGS TITLE PLAN AND PROFILE	DESCRIPTION ROAD 22 GRADE SEPARATION ROAD 22 GRADE SEPARATION AVENUE 22 REALIGNMENT ROAD 24 REALIGNMENT ROAD 24 REALIGNMENT ROAD 24 REALIGNMENT AVENUE 20 1/2 GRADE SEPARATION AVENUE 20 1/2 GRADE SEPARATION AVENUE 20 REALIGNMENT
CV-R1280-ACENTRAL VALLEY WYECV-R1281-ACENTRAL VALLEY WYECV-R1290-ACENTRAL VALLEY WYECV-R1310-ACENTRAL VALLEY WYECV-R1311-ACENTRAL VALLEY WYECV-R1312-ACENTRAL VALLEY WYECV-R1313-ACENTRAL VALLEY WYECV-R1314-ACENTRAL VALLEY WYECV-R1320-ACENTRAL VALLEY WYECV-R1321-ACENTRAL VALLEY WYECV-R1321-ACENTRAL VALLEY WYECV-R1450-ACENTRAL VALLEY WYECV-R1470-ACENTRAL VALLEY WYECV-R1471-ACENTRAL VALLEY WYECV-R1480-ACENTRAL VALLEY WYECV-R1481-ACENTRAL VALLEY WYECV-R1482-ACENTRAL VALLEY WYECV-R1490-ACENTRAL VALLEY WYE	SR152(NORTH) TOROAD13WYEALTERNATIVESR152(NORTH) TOROAD13WYEALTERNATIVE <th>PLAN AND PROFILE PLAN AND PROFILE</th> <th>ROAD 22 GRADE SEPARATIONROAD 22 GRADE SEPARATIONAVENUE 22 GRADE SEPARATIONAVENUE 22 REALIGNMENTROAD 24 REALIGNMENTROAD 24 REALIGNMENTROAD 24 REALIGNMENTAVENUE 20 1/2 GRADE SEPARATIONAVENUE 20 1/2 GRADE SEPARATIONAVENUE 20 1/2 GRADE SEPARATIONAVENUE 20 REALIGNMENT</th>	PLAN AND PROFILE PLAN AND PROFILE	ROAD 22 GRADE SEPARATIONROAD 22 GRADE SEPARATIONAVENUE 22 GRADE SEPARATIONAVENUE 22 REALIGNMENTROAD 24 REALIGNMENTROAD 24 REALIGNMENTROAD 24 REALIGNMENTAVENUE 20 1/2 GRADE SEPARATIONAVENUE 20 1/2 GRADE SEPARATIONAVENUE 20 1/2 GRADE SEPARATIONAVENUE 20 REALIGNMENT
CV-R1281-ACENTRAL VALLEY WYECV-R1290-ACENTRAL VALLEY WYECV-R1310-ACENTRAL VALLEY WYECV-R1311-ACENTRAL VALLEY WYECV-R1312-ACENTRAL VALLEY WYECV-R1313-ACENTRAL VALLEY WYECV-R1314-ACENTRAL VALLEY WYECV-R1320-ACENTRAL VALLEY WYECV-R1321-ACENTRAL VALLEY WYECV-R1321-ACENTRAL VALLEY WYECV-R1450-ACENTRAL VALLEY WYECV-R1470-ACENTRAL VALLEY WYECV-R1471-ACENTRAL VALLEY WYECV-R1480-ACENTRAL VALLEY WYECV-R1481-ACENTRAL VALLEY WYECV-R1482-ACENTRAL VALLEY WYECV-R1490-ACENTRAL VALLEY WYE	SR152(NORTH) TOROAD13WYEALTERNATIVESR152(NORTH) TOROAD13WYEALTERNATIVE	PLAN AND PROFILE	ROAD 22 GRADE SEPARATIONAVENUE 22 REALIGNMENTROAD 24 REALIGNMENTROAD 24 REALIGNMENTROAD 24 REALIGNMENTAVENUE 20 1/2 GRADE SEPARATIONAVENUE 20 1/2 GRADE SEPARATIONAVENUE 20 REALIGNMENT
CV-R1290-ACENTRAL VALLEY WYECV-R1310-ACENTRAL VALLEY WYECV-R1311-ACENTRAL VALLEY WYECV-R1312-ACENTRAL VALLEY WYECV-R1313-ACENTRAL VALLEY WYECV-R1314-ACENTRAL VALLEY WYECV-R1320-ACENTRAL VALLEY WYECV-R1321-ACENTRAL VALLEY WYECV-R1321-ACENTRAL VALLEY WYECV-R1450-ACENTRAL VALLEY WYECV-R1470-ACENTRAL VALLEY WYECV-R1471-ACENTRAL VALLEY WYECV-R1480-ACENTRAL VALLEY WYECV-R1481-ACENTRAL VALLEY WYECV-R1482-ACENTRAL VALLEY WYECV-R1490-ACENTRAL VALLEY WYE	SR152(NORTH)TOROAD13WYEALTERNATIVESR152(NORTH)TOROAD13WYEALTERNATIVESR152(NORTH)TOROAD13WYEALTERNATIVESR152(NORTH)TOROAD13WYEALTERNATIVESR152(NORTH)TOROAD13WYEALTERNATIVESR152(NORTH)TOROAD13WYEALTERNATIVESR152(NORTH)TOROAD13WYEALTERNATIVESR152(NORTH)TOROAD13WYEALTERNATIVESR152(NORTH)TOROAD13WYEALTERNATIVESR152(NORTH)TOROAD13WYEALTERNATIVESR152(NORTH)TOROAD13WYEALTERNATIVESR152(NORTH)TOROAD13WYEALTERNATIVE	PLAN AND PROFILE	AVENUE 22 REALIGNMENT ROAD 24 REALIGNMENT ROAD 24 REALIGNMENT ROAD 24 REALIGNMENT AVENUE 20 1/2 GRADE SEPARATION AVENUE 20 1/2 GRADE SEPARATION AVENUE 20 REALIGNMENT
CV-R1310-ACENTRAL VALLEY WYECV-R1311-ACENTRAL VALLEY WYECV-R1312-ACENTRAL VALLEY WYECV-R1313-ACENTRAL VALLEY WYECV-R1314-ACENTRAL VALLEY WYECV-R1320-ACENTRAL VALLEY WYECV-R1321-ACENTRAL VALLEY WYECV-R1450-ACENTRAL VALLEY WYECV-R1470-ACENTRAL VALLEY WYECV-R1471-ACENTRAL VALLEY WYECV-R1480-ACENTRAL VALLEY WYECV-R1481-ACENTRAL VALLEY WYECV-R1482-ACENTRAL VALLEY WYECV-R1480-ACENTRAL VALLEY WYECV-R1490-ACENTRAL VALLEY WYE	SR152(NORTH) TOROAD13WYEALTERNATIVESR152(NORTH) TOROAD13WYEALTERNATIVESR152(NORTH) TOROAD13WYEALTERNATIVESR152(NORTH) TOROAD13WYEALTERNATIVESR152(NORTH) TOROAD13WYEALTERNATIVESR152(NORTH) TOROAD13WYEALTERNATIVESR152(NORTH) TOROAD13WYEALTERNATIVESR152(NORTH) TOROAD13WYEALTERNATIVESR152(NORTH) TOROAD13WYEALTERNATIVESR152(NORTH) TOROAD13WYEALTERNATIVE	PLAN AND PROFILE	ROAD 24 REALIGNMENT ROAD 24 REALIGNMENT ROAD 24 REALIGNMENT AVENUE 20 1/2 GRADE SEPARATION AVENUE 20 1/2 GRADE SEPARATION AVENUE 20 REALIGNMENT
CV-R1311-ACENTRAL VALLEY WYECV-R1311-ACENTRAL VALLEY WYECV-R1312-ACENTRAL VALLEY WYECV-R1313-ACENTRAL VALLEY WYECV-R1320-ACENTRAL VALLEY WYECV-R1321-ACENTRAL VALLEY WYECV-R1450-ACENTRAL VALLEY WYECV-R1470-ACENTRAL VALLEY WYECV-R1471-ACENTRAL VALLEY WYECV-R1480-ACENTRAL VALLEY WYECV-R1481-ACENTRAL VALLEY WYECV-R1482-ACENTRAL VALLEY WYECV-R1490-ACENTRAL VALLEY WYE	SR152(NORTH)TOROAD13WYEALTERNATIVESR152(NORTH)TOROAD13WYEALTERNATIVESR152(NORTH)TOROAD13WYEALTERNATIVESR152(NORTH)TOROAD13WYEALTERNATIVESR152(NORTH)TOROAD13WYEALTERNATIVESR152(NORTH)TOROAD13WYEALTERNATIVESR152(NORTH)TOROAD13WYEALTERNATIVESR152(NORTH)TOROAD13WYEALTERNATIVESR152(NORTH)TOROAD13WYEALTERNATIVE	PLAN AND PROFILE	ROAD 24 REALIGNMENTROAD 24 REALIGNMENTAVENUE 20 1/2 GRADE SEPARATIONAVENUE 20 1/2 GRADE SEPARATIONAVENUE 20 REALIGNMENT
CV-R1312-ACENTRALVALLEYWYECV-R1313-ACENTRALVALLEYWYECV-R1314-ACENTRALVALLEYWYECV-R1320-ACENTRALVALLEYWYECV-R1321-ACENTRALVALLEYWYECV-R1450-ACENTRALVALLEYWYECV-R1470-ACENTRALVALLEYWYECV-R1471-ACENTRALVALLEYWYECV-R1480-ACENTRALVALLEYWYECV-R1481-ACENTRALVALLEYWYECV-R1482-ACENTRALVALLEYWYECV-R1490-ACENTRALVALLEYWYE	SR152(NORTH)TOROAD13WYEALTERNATIVESR152(NORTH)TOROAD13WYEALTERNATIVESR152(NORTH)TOROAD13WYEALTERNATIVESR152(NORTH)TOROAD13WYEALTERNATIVESR152(NORTH)TOROAD13WYEALTERNATIVESR152(NORTH)TOROAD13WYEALTERNATIVESR152(NORTH)TOROAD13WYEALTERNATIVESR152(NORTH)TOROAD13WYEALTERNATIVE	PLAN AND PROFILE	ROAD 24 REALIGNMENT AVENUE 20 1/2 GRADE SEPARATION AVENUE 20 1/2 GRADE SEPARATION AVENUE 20 REALIGNMENT
CV-R1313-ACENTRAL VALLEY WYECV-R1314-ACENTRAL VALLEY WYECV-R1320-ACENTRAL VALLEY WYECV-R1321-ACENTRAL VALLEY WYECV-R1450-ACENTRAL VALLEY WYECV-R1470-ACENTRAL VALLEY WYECV-R1471-ACENTRAL VALLEY WYECV-R1480-ACENTRAL VALLEY WYECV-R1481-ACENTRAL VALLEY WYECV-R1482-ACENTRAL VALLEY WYECV-R1490-ACENTRAL VALLEY WYE	SR152(NORTH)TOROAD13WYEALTERNATIVESR152(NORTH)TOROAD13WYEALTERNATIVESR152(NORTH)TOROAD13WYEALTERNATIVESR152(NORTH)TOROAD13WYEALTERNATIVESR152(NORTH)TOROAD13WYEALTERNATIVESR152(NORTH)TOROAD13WYEALTERNATIVESR152(NORTH)TOROAD13WYEALTERNATIVE	PLAN AND PROFILE PLAN AND PROFILE PLAN AND PROFILE PLAN AND PROFILE	AVENUE 20 1/2 GRADE SEPARATION AVENUE 20 1/2 GRADE SEPARATION AVENUE 20 REALIGNMENT
CV-R1314-ACENTRAL VALLEY WYECV-R1320-ACENTRAL VALLEY WYECV-R1321-ACENTRAL VALLEY WYECV-R1450-ACENTRAL VALLEY WYECV-R1470-ACENTRAL VALLEY WYECV-R1471-ACENTRAL VALLEY WYECV-R1480-ACENTRAL VALLEY WYECV-R1481-ACENTRAL VALLEY WYECV-R1482-ACENTRAL VALLEY WYECV-R1490-ACENTRAL VALLEY WYE	SR152(NORTH) TOROAD13WYEALTERNATIVESR152(NORTH) TOROAD13WYEALTERNATIVESR152(NORTH) TOROAD13WYEALTERNATIVESR152(NORTH) TOROAD13WYEALTERNATIVESR152(NORTH) TOROAD13WYEALTERNATIVESR152(NORTH) TOROAD13WYEALTERNATIVE	PLAN AND PROFILE PLAN AND PROFILE PLAN AND PROFILE	AVENUE 20 1/2 GRADE SEPARATION AVENUE 20 REALIGNMENT
CV-R1320-ACENTRALVALLEYWYECV-R1321-ACENTRALVALLEYWYECV-R1450-ACENTRALVALLEYWYECV-R1470-ACENTRALVALLEYWYECV-R1471-ACENTRALVALLEYWYECV-R1480-ACENTRALVALLEYWYECV-R1480-ACENTRALVALLEYWYECV-R1481-ACENTRALVALLEYWYECV-R1482-ACENTRALVALLEYWYECV-R1480-ACENTRALVALLEYWYE	SR 152 (NORTH) TO ROAD 13 WYE ALTERNATIVE	PLAN AND PROFILE PLAN AND PROFILE	AVENUE 20 REALIGNMENT
CV-R1321-ACENTRALVALLEYWYECV-R1450-ACENTRALVALLEYWYECV-R1470-ACENTRALVALLEYWYECV-R1471-ACENTRALVALLEYWYECV-R1480-ACENTRALVALLEYWYECV-R1481-ACENTRALVALLEYWYECV-R1482-ACENTRALVALLEYWYECV-R1490-ACENTRALVALLEYWYE	SR 152 (NORTH) TO ROAD 13 WYE ALTERNATIVE SR 152 (NORTH) TO ROAD 13 WYE ALTERNATIVE SR 152 (NORTH) TO ROAD 13 WYE ALTERNATIVE	PLAN AND PROFILE	
CV-R1450-ACENTRAL VALLEY WYECV-R1470-ACENTRAL VALLEY WYECV-R1471-ACENTRAL VALLEY WYECV-R1480-ACENTRAL VALLEY WYECV-R1481-ACENTRAL VALLEY WYECV-R1482-ACENTRAL VALLEY WYECV-R1480-ACENTRAL VALLEY WYE	SR 152 (NORTH) TO ROAD 13 WYE ALTERNATIVE SR 152 (NORTH) TO ROAD 13 WYE ALTERNATIVE		
CV-R1470-ACENTRALVALLEYWYECV-R1471-ACENTRALVALLEYWYECV-R1480-ACENTRALVALLEYWYECV-R1481-ACENTRALVALLEYWYECV-R1482-ACENTRALVALLEYWYECV-R1480-ACENTRALVALLEYWYE	SR 152 (NORTH) TO ROAD 13 WYE ALTERNATIVE	PLAN AND PROFILE	AVENUE 20 REALIGNMENT
CV-R1471-ACENTRALVALLEYWYECV-R1480-ACENTRALVALLEYWYECV-R1481-ACENTRALVALLEYWYECV-R1482-ACENTRALVALLEYWYECV-R1490-ACENTRALVALLEYWYE			AVENUE 25 GRADE SEPARATION
CV-R1480-ACENTRAL VALLEY WYECV-R1481-ACENTRAL VALLEY WYECV-R1482-ACENTRAL VALLEY WYECV-R1490-ACENTRAL VALLEY WYE	SR 152 (NORTH) TO ROAD 13 WYE ALTERNATIVE	PLAN AND PROFILE	VISTA AVENUE/ROAD 13 REALIGNMENT
CV-R1481-ACENTRAL VALLEY WYECV-R1482-ACENTRAL VALLEY WYECV-R1490-ACENTRAL VALLEY WYE		PLAN AND PROFILE	VISTA AVENUE/ROAD 13 REALIGNMENT
CV-R1482-ACENTRAL VALLEY WYECV-R1490-ACENTRAL VALLEY WYE	SR 152 (NORTH) TO ROAD 13 WYE ALTERNATIVE	PLAN AND PROFILE	CROSS ROAD REALIGNMENT
CV-R1490-A CENTRAL VALLEY WYE	SR 152 (NORTH) TO ROAD 13 WYE ALTERNATIVE	PLAN AND PROFILE	CROSS ROAD REALIGNMENT
	SR 152 (NORTH) TO ROAD 13 WYE ALTERNATIVE	PLAN AND PROFILE	CROSS ROAD REALIGNMENT
	SR 152 (NORTH) TO ROAD 13 WYE ALTERNATIVE	PLAN AND PROFILE	ROAD 11 REALIGNMENT
CV-R1491-A CENTRAL VALLEY WYE	SR 152 (NORTH) TO ROAD 13 WYE ALTERNATIVE	PLAN AND PROFILE	ROAD 11 REALIGNMENT
CV-R1492-A CENTRAL VALLEY WYE	SR 152 (NORTH) TO ROAD 13 WYE ALTERNATIVE	PLAN AND PROFILE	ROAD 11 REALIGNMENT
CV-R1630-A CENTRAL VALLEY WYE	SR 152 (NORTH) TO ROAD 13 WYE ALTERNATIVE	PLAN AND PROFILE	AVENUE 23 1/2 GRADE SEPARATION
CV-R1631-A CENTRAL VALLEY WYE	SR 152 (NORTH) TO ROAD 13 WYE ALTERNATIVE	PLAN AND PROFILE	AVENUE 23 1/2 GRADE SEPARATION
CV-R1640-A CENTRAL VALLEY WYE	SR 152 (NORTH) TO ROAD 13 WYE ALTERNATIVE	PLAN AND PROFILE	ROAD 13 REALIGNMENT
CV-R1641-A CENTRAL VALLEY WYE	SR 152 (NORTH) TO ROAD 13 WYE ALTERNATIVE	PLAN AND PROFILE	ROAD 13 REALIGNMENT
CV-I0001-A CENTRAL VALLEY WYE	SR 152 (NORTH) TO ROAD 13 WYE ALTERNATIVE	STAGE CONSTRUCTION PLAN	GENERAL NOTES
CV-I4100-A CENTRAL VALLEY WYE	SR 152 (NORTH) TO ROAD 13 WYE ALTERNATIVE	STAGE CONSTRUCTION PLAN	SR 59/SR 152 STAGE 1 OF 4
CV-I4101-A CENTRAL VALLEY WYE	SR 152 (NORTH) TO ROAD 13 WYE ALTERNATIVE	STAGE CONSTRUCTION PLAN	SR 59/SR 152 STAGE 2 OF 4
CV-I4102-A CENTRAL VALLEY WYE	SR 152 (NORTH) TO ROAD 13 WYE ALTERNATIVE	STAGE CONSTRUCTION PLAN	SR 59/SR 152 STAGE 3 OF 4
CV-I4103-A CENTRAL VALLEY WYE	SR 152 (NORTH) TO ROAD 13 WYE ALTERNATIVE	STAGE CONSTRUCTION PLAN	SR 59/SR 152 STAGE 4 OF 4
CV-I4160-A CENTRAL VALLEY WYE	SR 152 (NORTH) TO ROAD 13 WYE ALTERNATIVE	STAGE CONSTRUCTION PLAN	ROAD 9/SR 152 STAGE 1 OF 4
CV-I4161-A CENTRAL VALLEY WYE	SR 152 (NORTH) TO ROAD 13 WYE ALTERNATIVE	STAGE CONSTRUCTION PLAN	ROAD 9/SR 152 STAGE 2 OF 4
CV-I4162-A CENTRAL VALLEY WYE	SR 152 (NORTH) TO ROAD 13 WYE ALTERNATIVE	STAGE CONSTRUCTION PLAN	ROAD 9/SR 152 STAGE 3 OF 4
CV-I4163-A CENTRAL VALLEY WYE	SR 152 (NORTH) TO ROAD 13 WYE ALTERNATIVE	STAGE CONSTRUCTION PLAN	ROAD 9/SR 152 STAGE 4 OF 4
CV-I4210-A CENTRAL VALLEY WYE	SR 152 (NORTH) TO ROAD 13 WYE ALTERNATIVE	STAGE CONSTRUCTION PLAN	SR 233/SR 152 STAGE 1 OF 5
CV-I4211-A CENTRAL VALLEY WYE	SR 152 (NORTH) TO ROAD 13 WYE ALTERNATIVE	STAGE CONSTRUCTION PLAN	SR 233/SR 152 STAGE 2 OF 5
CV-I4212-A CENTRAL VALLEY WYE	SR 152 (NORTH) TO ROAD 13 WYE ALTERNATIVE	STAGE CONSTRUCTION PLAN	SR 233/SR 152 STAGE 3 OF 5
CV-I4213-A CENTRAL VALLEY WYE	SR 152 (NORTH) TO ROAD 13 WYE ALTERNATIVE	STAGE CONSTRUCTION PLAN	SR 233/SR 152 STAGE 4 OF 5
CV-I4214-A CENTRAL VALLEY WYE	SR 152 (NORTH) TO ROAD 13 WYE ALTERNATIVE	STAGE CONSTRUCTION PLAN	SR 233/SR 152 STAGE 5 OF 5
CV-I4230-A CENTRAL VALLEY WYE	SR 152 (NORTH) TO ROAD 13 WYE ALTERNATIVE	STAGE CONSTRUCTION PLAN	ROAD 16/SR 152 STAGE 1 OF 4
CV-I4231-A CENTRAL VALLEY WYE	SR 152 (NORTH) TO ROAD 13 WYE ALTERNATIVE	STAGE CONSTRUCTION PLAN	ROAD 16/SR 152 STAGE 2 OF 4
CV-I4232-A CENTRAL VALLEY WYE	SR 152 (NORTH) TO ROAD 13 WYE ALTERNATIVE	STAGE CONSTRUCTION PLAN	ROAD 16/SR 152 STAGE 3 OF 4
CV-I4233-A CENTRAL VALLEY WYE	SR 152 (NORTH) TO ROAD 13 WYE ALTERNATIVE	STAGE CONSTRUCTION PLAN	ROAD 16/SR 152 STAGE 4 OF 4
APP DESCRIPTION	DESIGNED BY S. WELLS DRAWN BY W. JOHNSEN CHECKED BY J. RAY IN CHARGE NOT FOR	ARSONS	FORNIA FORNIA

SEP-201613:58 MF-CV-BC

p0021811 06-SEI

			INDEX OF DRAWINGS		
DRAWING NO.	SECTION	ALIGNMENT / PLAN SET	TITLE	DESCRIPTION	
I		SR 152 (NORTH) TO ROAD 19 WYE ALTERNATIVE		
CV-B4050-B	CENTRAL VALLEY WYE	SR 152 (NORTH) TO ROAD 19 WYE ALTERNATIV	E KEY MAP	SHEET 1 OF 4	
CV-B4051-B	CENTRAL VALLEY WYE	SR 152 (NORTH) TO ROAD 19 WYE ALTERNATIV	E KEY MAP	SHEET 2 OF 4	
CV-B4052-B	CENTRAL VALLEY WYE	SR 152 (NORTH) TO ROAD 19 WYE ALTERNATIV	E KEY MAP	SHEET 3 OF 4	
CV-B4053-B	CENTRAL VALLEY WYE	SR 152 (NORTH) TO ROAD 19 WYE ALTERNATIV	E KEY MAP	SHEET 4 OF 4	
СV-В0060-В	CENTRAL VALLEY WYE	SR 152 (NORTH) TO ROAD 19 WYE ALTERNATIV	E GEOMETRY DATA TABLE	SHEET 1 OF 6	
CV-B0061-B	CENTRAL VALLEY WYE	SR 152 (NORTH) TO ROAD 19 WYE ALTERNATIV	E GEOMETRY DATA TABLE	SHEET 2 OF 6	
СV-В0062-В	CENTRAL VALLEY WYE	SR 152 (NORTH) TO ROAD 19 WYE ALTERNATIV	E GEOMETRY DATA TABLE	SHEET 3 OF 6	
CV-B0063-B	CENTRAL VALLEY WYE	SR 152 (NORTH) TO ROAD 19 WYE ALTERNATIV	E GEOMETRY DATA TABLE	SHEET 4 OF 6	
CV-B0064-B	CENTRAL VALLEY WYE	SR 152 (NORTH) TO ROAD 19 WYE ALTERNATIV	E GEOMETRY DATA TABLE	SHEET 5 OF 6	
CV-B0065-B	CENTRAL VALLEY WYE	SR 152 (NORTH) TO ROAD 19 WYE ALTERNATIV	E GEOMETRY DATA TABLE	SHEET 6 OF 6	
СV-В0070-В	CENTRAL VALLEY WYE	SR 152 (NORTH) TO ROAD 19 WYE ALTERNATIV	E UTILITY CONFLICT TABLE	SHEET 1 OF 4	
CV-B0071-B	CENTRAL VALLEY WYE	SR 152 (NORTH) TO ROAD 19 WYE ALTERNATIV	E UTILITY CONFLICT TABLE	SHEET 2 OF 4	
CV-B0072-B	CENTRAL VALLEY WYE	SR 152 (NORTH) TO ROAD 19 WYE ALTERNATIV	E UTILITY CONFLICT TABLE	SHEET 3 OF 4	
СV-ВОО73-В	CENTRAL VALLEY WYE	SR 152 (NORTH) TO ROAD 19 WYE ALTERNATIV	E UTILITY CONFLICT TABLE	SHEET 4 OF 4	
СV-ВОО80-В	CENTRAL VALLEY WYE	SR 152 (NORTH) TO ROAD 19 WYE ALTERNATIV	E TYPICAL SECTION	SHEET 1 OF 5	
CV-B0081-B	CENTRAL VALLEY WYE	SR 152 (NORTH) TO ROAD 19 WYE ALTERNATIV	E TYPICAL SECTION	SHEET 2 OF 5	
CV-B0082-B	CENTRAL VALLEY WYE	SR 152 (NORTH) TO ROAD 19 WYE ALTERNATIV	E TYPICAL SECTION	SHEET 3 OF 5	
CV-B0083-B	CENTRAL VALLEY WYE	SR 152 (NORTH) TO ROAD 19 WYE ALTERNATIV	E TYPICAL SECTION	SHEET 4 OF 5	
CV-B0084-B	CENTRAL VALLEY WYE	SR 152 (NORTH) TO ROAD 19 WYE ALTERNATIV	E TYPICAL SECTION	SHEET 5 OF 5	
CV-S1010-B	CENTRAL VALLEY WYE	SR 152 (NORTH) TO ROAD 19 WYE ALTERNATIV	E CIVIL PLAN	SJD-FRE STA 5338+00 TO 5394+00	
CV-S1020-B	CENTRAL VALLEY WYE	SR 152 (NORTH) TO ROAD 19 WYE ALTERNATIV	E CIVIL PLAN	SJD-FRE STA 5394+00 TO 5450+00	
CV-S1030-B	CENTRAL VALLEY WYE	SR 152 (NORTH) TO ROAD 19 WYE ALTERNATIV	E CIVIL PLAN	SJD-FRE STA 5450+00 TO 5506+00	
CV-S1040-B	CENTRAL VALLEY WYE	SR 152 (NORTH) TO ROAD 19 WYE ALTERNATIV	E CIVIL PLAN	SJD-FRE STA 5506+00 TO 5562+00	
CV-S1050-B	CENTRAL VALLEY WYE	SR 152 (NORTH) TO ROAD 19 WYE ALTERNATIV	E CIVIL PLAN	SJD-FRE STA 5562+00 TO 5618+00	
CV-S1060-B	CENTRAL VALLEY WYE	SR 152 (NORTH) TO ROAD 19 WYE ALTERNATIV	E CIVIL PLAN	SJD-FRE STA 5618+00 TO 5674+00	
CV-S1070-B	CENTRAL VALLEY WYE	SR 152 (NORTH) TO ROAD 19 WYE ALTERNATIV	E CIVIL PLAN	SJD-FRE STA 5674+00 TO 5730+00	
CV-S1080-B	CENTRAL VALLEY WYE	SR 152 (NORTH) TO ROAD 19 WYE ALTERNATIV	E CIVIL PLAN	SJD-FRE STA 5730+00 TO 5786+00	
CV-S1090-B	CENTRAL VALLEY WYE	SR 152 (NORTH) TO ROAD 19 WYE ALTERNATIV	E CIVIL PLAN	SJD-FRE STA 5786+00 TO 5842+00	
CV-S1100-B	CENTRAL VALLEY WYE	SR 152 (NORTH) TO ROAD 19 WYE ALTERNATIV	E CIVIL PLAN	SJD-FRE STA 5842+00 TO 5898+00	
CV-S1110-B	CENTRAL VALLEY WYE	SR 152 (NORTH) TO ROAD 19 WYE ALTERNATIV	E CIVIL PLAN	SJD-FRE STA 5898+00 TO 5954+00	
CV-S1111-B	CENTRAL VALLEY WYE	SR 152 (NORTH) TO ROAD 19 WYE ALTERNATIV	E CIVIL PLAN	SJD-FRE ACCESS ROAD	
CV-S1120-B	CENTRAL VALLEY WYE	SR 152 (NORTH) TO ROAD 19 WYE ALTERNATIV	E CIVIL PLAN	SJD-FRE STA 5954+00 TO 6010+00	
CV-S1130-B	CENTRAL VALLEY WYE	SR 152 (NORTH) TO ROAD 19 WYE ALTERNATIV	E CIVIL PLAN	SJD-FRE STA 6010+00 TO 6066+00	
CV-S1140-B	CENTRAL VALLEY WYE	SR 152 (NORTH) TO ROAD 19 WYE ALTERNATIV	E CIVIL PLAN	SJD-FRE STA 6066+00 TO 6122+00	
CV-S1150-B	CENTRAL VALLEY WYE	SR 152 (NORTH) TO ROAD 19 WYE ALTERNATIV	E CIVIL PLAN	SJD-FRE STA 6122+00 TO 6178+00	
CV-S1160-B	CENTRAL VALLEY WYE	SR 152 (NORTH) TO ROAD 19 WYE ALTERNATIV	E CIVIL PLAN	SJD-FRE STA 6178+00 TO 6234+00	
CV-S1161-B	CENTRAL VALLEY WYE	SR 152 (NORTH) TO ROAD 19 WYE ALTERNATIV	E CIVIL PLAN	SJD-FRE ACCESS ROAD	
CV-S1170-B	CENTRAL VALLEY WYE	SR 152 (NORTH) TO ROAD 19 WYE ALTERNATIV	E CIVIL PLAN	SJD-FRE STA 6234+00 TO 6290+00	
CV-S1180-B	CENTRAL VALLEY WYE	SR 152 (NORTH) TO ROAD 19 WYE ALTERNATIV	E CIVIL PLAN	SJD-FRE STA 6290+00 TO 6346+00	
CV-S1190-B	CENTRAL VALLEY WYE	SR 152 (NORTH) TO ROAD 19 WYE ALTERNATIV	E CIVIL PLAN	SJD-FRE STA 6346+00 TO 6402+00	
		DESIGNED BY S. WELLS DRAWN BY W. JOHNSEN CHECKED BY CHECKED BY L D DAY	PARSONS	CALIFORNIA HIGH-SPEED TRAIN PROJECT MERCED TO FRESNO SECTION CENTRAL VALLEY WYE	DRAWING NO.
			FARSONS CALIFOR	CIVIL AND GRADE SEPARATION PLANS INDEX OF DRAWINGS	NO SC
	DESCRIPTION	C. LEMLEY CONSTRUCTION	HIGH-SPEED RAIL AUT		SHEET NO.

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		INDEX	OF DRAWINGS	
DRAWING NO.	SECTION	ALIGNMENT / PLAN SET	TITLE	DESCRIPTION
CV-S1191-B	CENTRAL VALLEY WYE	SR 152 (NORTH) TO ROAD 19 WYE ALTERNATIVE	CIVIL PLAN	SJD-FRE ACCESS ROAD
CV-S1200-B	CENTRAL VALLEY WYE	SR 152 (NORTH) TO ROAD 19 WYE ALTERNATIVE	CIVIL PLAN	SJD-FRE STA 6402+00 TO 6458+00
CV-S1210-B	CENTRAL VALLEY WYE	SR 152 (NORTH) TO ROAD 19 WYE ALTERNATIVE	CIVIL PLAN	SJD-FRE STA 6458+00 TO 6514+00
CV-S1220-B	CENTRAL VALLEY WYE	SR 152 (NORTH) TO ROAD 19 WYE ALTERNATIVE	CIVIL PLAN	SJD-FRE STA 6514+00 TO 6570+00
CV-S1230-B	CENTRAL VALLEY WYE	SR 152 (NORTH) TO ROAD 19 WYE ALTERNATIVE	CIVIL PLAN	SJD-FRE STA 6570+00 TO 6626+00
CV-S1240-B	CENTRAL VALLEY WYE	SR 152 (NORTH) TO ROAD 19 WYE ALTERNATIVE	CIVIL PLAN	SJD-FRE STA 6626+00 TO 6682+00
CV-S1250-B	CENTRAL VALLEY WYE	SR 152 (NORTH) TO ROAD 19 WYE ALTERNATIVE	CIVIL PLAN	SJD-FRE STA 6682+00 TO 6738+00
CV-S1260-B	CENTRAL VALLEY WYE	SR 152 (NORTH) TO ROAD 19 WYE ALTERNATIVE	CIVIL PLAN	SJD-FRE STA 6738+00 TO 6794+00
CV-S1270-B	CENTRAL VALLEY WYE	SR 152 (NORTH) TO ROAD 19 WYE ALTERNATIVE	CIVIL PLAN	SJD-FRE STA 6794+00 TO 6850+00
CV-S1280-B	CENTRAL VALLEY WYE	SR 152 (NORTH) TO ROAD 19 WYE ALTERNATIVE	CIVIL PLAN	SJD-FRE STA 6850+00 TO 6906+00
CV-S1290-B	CENTRAL VALLEY WYE	SR 152 (NORTH) TO ROAD 19 WYE ALTERNATIVE	CIVIL PLAN	SJD-FRE STA 6906+00 TO 6962+00
CV-S1300-B	CENTRAL VALLEY WYE	SR 152 (NORTH) TO ROAD 19 WYE ALTERNATIVE	CIVIL PLAN	SJD-FRE STA 6962+00 TO 7018+00
CV-S1301-B	CENTRAL VALLEY WYE	SR 152 (NORTH) TO ROAD 19 WYE ALTERNATIVE	CIVIL PLAN	SJD-FRE ACCESS ROAD
CV-S1310-B	CENTRAL VALLEY WYE	SR 152 (NORTH) TO ROAD 19 WYE ALTERNATIVE	CIVIL PLAN	SJD-FRE STA 7018+00 TO 7074+00
CV-S1320-B	CENTRAL VALLEY WYE	SR 152 (NORTH) TO ROAD 19 WYE ALTERNATIVE	CIVIL PLAN	SJD-FRE STA 7074+00 TO 7130+00
CV-S1330-B	CENTRAL VALLEY WYE	SR 152 (NORTH) TO ROAD 19 WYE ALTERNATIVE	CIVIL PLAN	SJD-FRE STA 7130+00 TO 7169+59.17
CV-S1410-B	CENTRAL VALLEY WYE	SR 152 (NORTH) TO ROAD 19 WYE ALTERNATIVE	CIVIL PLAN	MER-FRE STA 14715+51.00 TO 14771+00
CV-S1420-B	CENTRAL VALLEY WYE	SR 152 (NORTH) TO ROAD 19 WYE ALTERNATIVE	CIVIL PLAN	MER-FRE STA 14771+00 TO 14827+00
CV-S1430-B	CENTRAL VALLEY WYE	SR 152 (NORTH) TO ROAD 19 WYE ALTERNATIVE	CIVIL PLAN	MER-FRE STA 14827+00 TO 14883+00
CV-S1440-B	CENTRAL VALLEY WYE	SR 152 (NORTH) TO ROAD 19 WYE ALTERNATIVE	CIVIL PLAN	MER-FRE STA 14883+00 TO 14939+00
CV-S1450-B	CENTRAL VALLEY WYE	SR 152 (NORTH) TO ROAD 19 WYE ALTERNATIVE	CIVIL PLAN	MER-FRE STA 14939+00 TO 14995+00
CV-S1460-B	CENTRAL VALLEY WYE	SR 152 (NORTH) TO ROAD 19 WYE ALTERNATIVE	CIVIL PLAN	MER-FRE STA 14995+00 TO 15051+00
CV-S1470-B	CENTRAL VALLEY WYE	SR 152 (NORTH) TO ROAD 19 WYE ALTERNATIVE	CIVIL PLAN	MER-FRE STA 15051+00 TO 15107+00
CV-S1471-B	CENTRAL VALLEY WYE	SR 152 (NORTH) TO ROAD 19 WYE ALTERNATIVE	CIVIL PLAN	SJD-FRE ACCESS ROAD
CV-S1480-B	CENTRAL VALLEY WYE	SR 152 (NORTH) TO ROAD 19 WYE ALTERNATIVE	CIVIL PLAN	MER-FRE STA 15107+00 TO 15163+00
CV-S1490-B	CENTRAL VALLEY WYE	SR 152 (NORTH) TO ROAD 19 WYE ALTERNATIVE	CIVIL PLAN	MER-FRE STA 15163+00 TO 15219+00
CV-S1500-B	CENTRAL VALLEY WYE	SR 152 (NORTH) TO ROAD 19 WYE ALTERNATIVE	CIVIL PLAN	MER-FRE STA 15219+00 TO 15275+00
CV-S1510-B	CENTRAL VALLEY WYE	SR 152 (NORTH) TO ROAD 19 WYE ALTERNATIVE	CIVIL PLAN	MER-FRE STA 15275+00 TO 15331+00
CV-S1520-B	CENTRAL VALLEY WYE	SR 152 (NORTH) TO ROAD 19 WYE ALTERNATIVE	CIVIL PLAN	MER-FRE STA 15331+00 TO 15387+00
CV-S1530-B	CENTRAL VALLEY WYE	SR 152 (NORTH) TO ROAD 19 WYE ALTERNATIVE	CIVIL PLAN	MER-FRE STA 15387+00 TO 15443+00
CV-S1540-B	CENTRAL VALLEY WYE	SR 152 (NORTH) TO ROAD 19 WYE ALTERNATIVE	CIVIL PLAN	MER-FRE STA 15443+00 TO 15499+00
CV-S1550-B	CENTRAL VALLEY WYE	SR 152 (NORTH) TO ROAD 19 WYE ALTERNATIVE	CIVIL PLAN	MER-FRE STA 15499+00 TO 15555+00
CV-S1560-B	CENTRAL VALLEY WYE	SR 152 (NORTH) TO ROAD 19 WYE ALTERNATIVE	CIVIL PLAN	MER-FRE STA 15555+00 TO 15611+00
CV-S1570-B	CENTRAL VALLEY WYE	SR 152 (NORTH) TO ROAD 19 WYE ALTERNATIVE	CIVIL PLAN	MER-FRE STA 15611+00 TO 15655+00
CV-S1610-B	CENTRAL VALLEY WYE	SR 152 (NORTH) TO ROAD 19 WYE ALTERNATIVE	CIVIL PLAN	SJD-MER STA 36570+00 TO 36626+00
CV-S1620-B	CENTRAL VALLEY WYE	SR 152 (NORTH) TO ROAD 19 WYE ALTERNATIVE	CIVIL PLAN	SJD-MER STA 36626+00 TO 36682+00
CV-S1630-B	CENTRAL VALLEY WYE	SR 152 (NORTH) TO ROAD 19 WYE ALTERNATIVE	CIVIL PLAN	SJD-MER STA 36682+00 TO 36738+00
CV-S1640-B	CENTRAL VALLEY WYE	SR 152 (NORTH) TO ROAD 19 WYE ALTERNATIVE	CIVIL PLAN	SJD-MER STA 36738+00 TO 36794+00
CV-S1650-B	CENTRAL VALLEY WYE	SR 152 (NORTH) TO ROAD 19 WYE ALTERNATIVE	CIVIL PLAN	SJD-MER STA 36794+00 TO 36850+00
CV-S1660-B	CENTRAL VALLEY WYE	SR 152 (NORTH) TO ROAD 19 WYE ALTERNATIVE	CIVIL PLAN	SJD-MER STA 36850+00 TO 36857+29

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2000 RE	V DATE	вү снк	APP	DESCRIPTION	DATE 09/09/2016			HIGH-SPEED RAIL AUTHORITY	
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NIA HIGH-SPEED TRAIN PROJECT MERCED TO FRESNO SECTION CENTRAL VALLEY WYE CIVIL AND GRADE SEPARATION PLANS INDEX OF DRAWINGS

SHEET 7 OF 17

CONTRACT NO. HSR08-05

DRAWING NO. CV-B0008

SCALE NO SCALE

			INDEX OF DRAWINGS			
DRAWING NO.	SECTION	ALIGNMENT / PLAN SET	TITLE		DESCRIPTION	
CV-R1030-B	CENTRAL VALLEY WYE	SR 152 (NORTH) TO ROAD 19 WYE ALTERNATIVE	PLAN AND PROFILE	HENR	Y MILLER ROAD REALIGNMENT	
CV-R1031-B	CENTRAL VALLEY WYE	SR 152 (NORTH) TO ROAD 19 WYE ALTERNATIVE	PLAN AND PROFILE	HENR	Y MILLER ROAD REALIGNMENT	
CV-R1032-B	CENTRAL VALLEY WYE	SR 152 (NORTH) TO ROAD 19 WYE ALTERNATIVE	PLAN AND PROFILE	HENR	Y MILLER ROAD REALIGNMENT	
CV-R1033-B	CENTRAL VALLEY WYE	SR 152 (NORTH) TO ROAD 19 WYE ALTERNATIVE	PLAN AND PROFILE	HENR	Y MILLER ROAD REALIGNMENT	
CV-R1050-B	CENTRAL VALLEY WYE	SR 152 (NORTH) TO ROAD 19 WYE ALTERNATIVE	PLAN AND PROFILE	INDIA	ANA ROAD GRADE SEPARATION	
CV-R1051-B	CENTRAL VALLEY WYE	SR 152 (NORTH) TO ROAD 19 WYE ALTERNATIVE	PLAN AND PROFILE	INDIA	ANA ROAD GRADE SEPARATION	
CV-R1090-B	CENTRAL VALLEY WYE	SR 152 (NORTH) TO ROAD 19 WYE ALTERNATIVE	PLAN AND PROFILE	CC	OYOTE ROAD REALIGNMENT	
CV-R1091-B	CENTRAL VALLEY WYE	SR 152 (NORTH) TO ROAD 19 WYE ALTERNATIVE	PLAN AND PROFILE	CC	OYOTE ROAD REALIGNMENT	
CV-R1100-B	CENTRAL VALLEY WYE	SR 152 (NORTH) TO ROAD 19 WYE ALTERNATIVE	PLAN AND PROFILE	SR	152 REALIGNMENT AT SR 59	
CV-R1101-B	CENTRAL VALLEY WYE	SR 152 (NORTH) TO ROAD 19 WYE ALTERNATIVE	PLAN AND PROFILE	SR	152 REALIGNMENT AT SR 59	
CV-R1102-B	CENTRAL VALLEY WYE	SR 152 (NORTH) TO ROAD 19 WYE ALTERNATIVE	PLAN AND PROFILE	SR	152 REALIGNMENT AT SR 59	
CV-R1103-B	CENTRAL VALLEY WYE	SR 152 (NORTH) TO ROAD 19 WYE ALTERNATIVE	PLAN AND PROFILE	SR	152 REALIGNMENT AT SR 59	
CV-R1104-B	CENTRAL VALLEY WYE	SR 152 (NORTH) TO ROAD 19 WYE ALTERNATIVE	PLAN AND PROFILE	SR 59/SR 1	52 EB OFF RAMP GRADE SEPARATION	
CV-R1105-B	CENTRAL VALLEY WYE	SR 152 (NORTH) TO ROAD 19 WYE ALTERNATIVE	PLAN AND PROFILE	SR 59/SR 1	52 EB OFF RAMP GRADE SEPARATION	
CV-R1106-B	CENTRAL VALLEY WYE	SR 152 (NORTH) TO ROAD 19 WYE ALTERNATIVE	PLAN AND PROFILE	SR 59/SR -	152 WB ON RAMP GRADE SEPARATION	
CV-R1107-B	CENTRAL VALLEY WYE	SR 152 (NORTH) TO ROAD 19 WYE ALTERNATIVE	PLAN AND PROFILE	SR 59/SR -	152 WB ON RAMP GRADE SEPARATION	
CV-R1108-B	CENTRAL VALLEY WYE	SR 152 (NORTH) TO ROAD 19 WYE ALTERNATIVE	PLAN AND PROFILE	SR 59/SR 1	52 WB OFF RAMP GRADE SEPARATION	
CV-R1109-B	CENTRAL VALLEY WYE	SR 152 (NORTH) TO ROAD 19 WYE ALTERNATIVE	PLAN AND PROFILE	SR 59/SR 1	52 WB OFF RAMP GRADE SEPARATION	
CV-R1110-B	CENTRAL VALLEY WYE	SR 152 (NORTH) TO ROAD 19 WYE ALTERNATIVE	PLAN AND PROFILE	SR 5	59/SR 152 EB LOOP ON RAMP	
CV-R1111-B	CENTRAL VALLEY WYE	SR 152 (NORTH) TO ROAD 19 WYE ALTERNATIVE	PLAN AND PROFILE	ROAD 4/L	INCOLN ROAD GRADE SEPARATION	
CV-R1112-B	CENTRAL VALLEY WYE	SR 152 (NORTH) TO ROAD 19 WYE ALTERNATIVE	PLAN AND PROFILE	ROAD 4/L	INCOLN ROAD GRADE SEPARATION	
CV-R1160-B	CENTRAL VALLEY WYE	SR 152 (NORTH) TO ROAD 19 WYE ALTERNATIVE	PLAN AND PROFILE	ROAD 9/H	HEMLOCK ROAD GRADE SEPARATION	
CV-R1161-B	CENTRAL VALLEY WYE	SR 152 (NORTH) TO ROAD 19 WYE ALTERNATIVE	PLAN AND PROFILE	ROAD 9/H	HEMLOCK ROAD GRADE SEPARATION	
CV-R1162-B	CENTRAL VALLEY WYE	SR 152 (NORTH) TO ROAD 19 WYE ALTERNATIVE	PLAN AND PROFILE	SR 1	152 REALIGNMENT AT ROAD 9	
CV-R1163-B	CENTRAL VALLEY WYE	SR 152 (NORTH) TO ROAD 19 WYE ALTERNATIVE	PLAN AND PROFILE	SR 1	152 REALIGNMENT AT ROAD 9	
CV-R1164-B	CENTRAL VALLEY WYE	SR 152 (NORTH) TO ROAD 19 WYE ALTERNATIVE	PLAN AND PROFILE	SR 1	152 REALIGNMENT AT ROAD 9	
CV-R1165-B	CENTRAL VALLEY WYE	SR 152 (NORTH) TO ROAD 19 WYE ALTERNATIVE	PLAN AND PROFILE	RO	AD 9/SR 152 EB OFF RAMP	
CV-R1166-B	CENTRAL VALLEY WYE	SR 152 (NORTH) TO ROAD 19 WYE ALTERNATIVE	PLAN AND PROFILE	RC	DAD 9/SR 152 EB ON RAMP	
CV-R1167-B	CENTRAL VALLEY WYE	SR 152 (NORTH) TO ROAD 19 WYE ALTERNATIVE	PLAN AND PROFILE	R	OAD 9/SR 152 LOOP RAMP	
CV-R1168-B	CENTRAL VALLEY WYE	SR 152 (NORTH) TO ROAD 19 WYE ALTERNATIVE	PLAN AND PROFILE	RC	DAD 9/SR 152 WB ON RAMP	
CV-R1169-B	CENTRAL VALLEY WYE	SR 152 (NORTH) TO ROAD 19 WYE ALTERNATIVE	PLAN AND PROFILE	RO	AD 9/SR 152 WB OFF RAMP	
CV-R1190-B	CENTRAL VALLEY WYE	SR 152 (NORTH) TO ROAD 19 WYE ALTERNATIVE	PLAN AND PROFILE	ROAD 1	2/ELM ROAD GRADE SEPARATION	
CV-R1191-B	CENTRAL VALLEY WYE	SR 152 (NORTH) TO ROAD 19 WYE ALTERNATIVE	PLAN AND PROFILE	ROAD 1	2/ELM ROAD GRADE SEPARATION	
CV-R1200-B	CENTRAL VALLEY WYE	SR 152 (NORTH) TO ROAD 19 WYE ALTERNATIVE	PLAN AND PROFILE	SR 1	152 REALIGNMENT AT SR 233	
CV-R1201-B	CENTRAL VALLEY WYE	SR 152 (NORTH) TO ROAD 19 WYE ALTERNATIVE	PLAN AND PROFILE	SR 1	152 REALIGNMENT AT SR 233	
CV-R1202-B	CENTRAL VALLEY WYE	SR 152 (NORTH) TO ROAD 19 WYE ALTERNATIVE	PLAN AND PROFILE	SR 1	152 REALIGNMENT AT SR 233	
CV-R1203-B	CENTRAL VALLEY WYE	SR 152 (NORTH) TO ROAD 19 WYE ALTERNATIVE	PLAN AND PROFILE	SR	233/SR 152 EB OFF RAMP	
CV-R1204-B	CENTRAL VALLEY WYE	SR 152 (NORTH) TO ROAD 19 WYE ALTERNATIVE	PLAN AND PROFILE	SR	233/SR 152 EB LOOP RAMP	
CV-R1205-B	CENTRAL VALLEY WYE	SR 152 (NORTH) TO ROAD 19 WYE ALTERNATIVE	PLAN AND PROFILE	SF	R 233/SR 152 WB ON RAMP	
CV-R1210-B	CENTRAL VALLEY WYE	SR 152 (NORTH) TO ROAD 19 WYE ALTERNATIVE	PLAN AND PROFILE	SR 233/RC	DBERTSON BLVD GRADE SEPARATION	
CV-R1211-B	CENTRAL VALLEY WYE	SR 152 (NORTH) TO ROAD 19 WYE ALTERNATIVE	PLAN AND PROFILE	SR 233/RC	DBERTSON BLVD GRADE SEPARATION	
		DESIGNED BY S. WELLS DRAWN BY W. JOHNSEN CHECKED BY J. RAY IN CHARGE C. LEMLEY CONSTRUCTION		IFORNIA EED RAIL AUTHORITY	CALIFORNIA HIGH-SPEED TRAIN PROJECT MERCED TO FRESNO SECTION CENTRAL VALLEY WYE CIVIL AND GRADE SEPARATION PLANS INDEX OF DRAWINGS SHEET 8 OF 17	CONTR HS DRAWII C\ SCALE NC SHEET

p0021811 06-SEI

	INDEX OF DRAWINGS			
DESCRIPTIC	TITLE	ALIGNMENT / PLAN SET	SECTION	DRAWING NO.
SR 233/SR 152 EI	PLAN AND PROFILE	SR 152 (NORTH) TO ROAD 19 WYE ALTERNATIVE	CENTRAL VALLEY WYE	CV-R1212-B
SR 233/SR 152 EI	PLAN AND PROFILE	SR 152 (NORTH) TO ROAD 19 WYE ALTERNATIVE	CENTRAL VALLEY WYE	CV-R1213-B
SR 233/SR 152 WB	PLAN AND PROFILE	SR 152 (NORTH) TO ROAD 19 WYE ALTERNATIVE	CENTRAL VALLEY WYE	CV-R1214-B
CATES COURT REA	PLAN AND PROFILE	SR 152 (NORTH) TO ROAD 19 WYE ALTERNATIVE	CENTRAL VALLEY WYE	CV-R1215-B
SR 152 REALIGNMENT	PLAN AND PROFILE	SR 152 (NORTH) TO ROAD 19 WYE ALTERNATIVE	CENTRAL VALLEY WYE	CV-R1224-B
SR 152 REALIGNMENT	PLAN AND PROFILE	SR 152 (NORTH) TO ROAD 19 WYE ALTERNATIVE	CENTRAL VALLEY WYE	CV-R1225-B
SR 152 REALIGNMENT	PLAN AND PROFILE	SR 152 (NORTH) TO ROAD 19 WYE ALTERNATIVE	CENTRAL VALLEY WYE	CV-R1226-B
ROAD 16/SR 152 EI	PLAN AND PROFILE	SR 152 (NORTH) TO ROAD 19 WYE ALTERNATIVE	CENTRAL VALLEY WYE	CV-R1227-B
ROAD 16/SR 152 EI	PLAN AND PROFILE	SR 152 (NORTH) TO ROAD 19 WYE ALTERNATIVE	CENTRAL VALLEY WYE	CV-R1228-B
ROAD 16/SR 152 W	PLAN AND PROFILE	SR 152 (NORTH) TO ROAD 19 WYE ALTERNATIVE	CENTRAL VALLEY WYE	CV-R1229-B
ROAD 16/BERENDA WAY G	PLAN AND PROFILE	SR 152 (NORTH) TO ROAD 19 WYE ALTERNATIVE	CENTRAL VALLEY WYE	CV-R1230-B
ROAD 16/BERENDA WAY G	PLAN AND PROFILE	SR 152 (NORTH) TO ROAD 19 WYE ALTERNATIVE	CENTRAL VALLEY WYE	CV-R1231-B
ROAD 16/SR 152 E	PLAN AND PROFILE	SR 152 (NORTH) TO ROAD 19 WYE ALTERNATIVE	CENTRAL VALLEY WYE	CV-R1232-B
ROAD 16/SR 152 EB	PLAN AND PROFILE	SR 152 (NORTH) TO ROAD 19 WYE ALTERNATIVE	CENTRAL VALLEY WYE	CV-R1233-B
ROAD 16/SR 152 W	PLAN AND PROFILE	SR 152 (NORTH) TO ROAD 19 WYE ALTERNATIVE	CENTRAL VALLEY WYE	CV-R1234-B
ROAD 16 CONNECTOR	PLAN AND PROFILE	SR 152 (NORTH) TO ROAD 19 WYE ALTERNATIVE	CENTRAL VALLEY WYE	CV-R1235-B
ROAD 17 1/2 GRADE	PLAN AND PROFILE	SR 152 (NORTH) TO ROAD 19 WYE ALTERNATIVE	CENTRAL VALLEY WYE	CV-R1240-B
ROAD 17 1/2 GRADE	PLAN AND PROFILE	SR 152 (NORTH) TO ROAD 19 WYE ALTERNATIVE	CENTRAL VALLEY WYE	CV-R1241-B
SR 152 AT ROAD	PLAN AND PROFILE	SR 152 (NORTH) TO ROAD 19 WYE ALTERNATIVE	CENTRAL VALLEY WYE	CV-R1243-B
FAIRMEAD BOULEVARD	PLAN AND PROFILE	SR 152 (NORTH) TO ROAD 19 WYE ALTERNATIVE	CENTRAL VALLEY WYE	CV-R1250-B
ROAD 20 GRADE SE	PLAN AND PROFILE	SR 152 (NORTH) TO ROAD 19 WYE ALTERNATIVE	CENTRAL VALLEY WYE	CV-R1260-B
ROAD 20 GRADE SE	PLAN AND PROFILE	SR 152 (NORTH) TO ROAD 19 WYE ALTERNATIVE	CENTRAL VALLEY WYE	CV-R1261-B
ROAD 22 GRADE SE	PLAN AND PROFILE	SR 152 (NORTH) TO ROAD 19 WYE ALTERNATIVE	CENTRAL VALLEY WYE	CV-R1280-B
ROAD 22 GRADE SE	PLAN AND PROFILE	SR 152 (NORTH) TO ROAD 19 WYE ALTERNATIVE	CENTRAL VALLEY WYE	CV-R1281-B
ROAD 24 REALI	PLAN AND PROFILE	SR 152 (NORTH) TO ROAD 19 WYE ALTERNATIVE	CENTRAL VALLEY WYE	CV-R1310-B
ROAD 24 REALI	PLAN AND PROFILE	SR 152 (NORTH) TO ROAD 19 WYE ALTERNATIVE	CENTRAL VALLEY WYE	CV-R1311-B
ROAD 24 REALI	PLAN AND PROFILE	SR 152 (NORTH) TO ROAD 19 WYE ALTERNATIVE	CENTRAL VALLEY WYE	CV-R1312-B
AVENUE 20 1/2 GRADI	PLAN AND PROFILE	SR 152 (NORTH) TO ROAD 19 WYE ALTERNATIVE	CENTRAL VALLEY WYE	CV-R1313-B
AVENUE 20 1/2 GRADI	PLAN AND PROFILE	SR 152 (NORTH) TO ROAD 19 WYE ALTERNATIVE	CENTRAL VALLEY WYE	CV-R1314-B
AVENUE 20 REAL	PLAN AND PROFILE	SR 152 (NORTH) TO ROAD 19 WYE ALTERNATIVE	CENTRAL VALLEY WYE	CV-R1320-B
AVENUE 20 REAL	PLAN AND PROFILE	SR 152 (NORTH) TO ROAD 19 WYE ALTERNATIVE	CENTRAL VALLEY WYE	CV-R1321-B
ROAD 19 1/2 AND FAIRLANE	PLAN AND PROFILE	SR 152 (NORTH) TO ROAD 19 WYE ALTERNATIVE	CENTRAL VALLEY WYE	CV-R1420-B
ROAD 19 REALI	PLAN AND PROFILE	SR 152 (NORTH) TO ROAD 19 WYE ALTERNATIVE	CENTRAL VALLEY WYE	CV-R1460-B
ROAD 19 REALI	PLAN AND PROFILE	SR 152 (NORTH) TO ROAD 19 WYE ALTERNATIVE	CENTRAL VALLEY WYE	CV-R1461-B
MINTURN ROAD/ROAD 15 G	PLAN AND PROFILE	SR 152 (NORTH) TO ROAD 19 WYE ALTERNATIVE	CENTRAL VALLEY WYE	CV-R1510-B
MINTURN ROAD/ROAD 15 G	PLAN AND PROFILE	SR 152 (NORTH) TO ROAD 19 WYE ALTERNATIVE	CENTRAL VALLEY WYE	CV-R1511-B
MINTURN ROAD/ROAD 15 G	PLAN AND PROFILE	SR 152 (NORTH) TO ROAD 19 WYE ALTERNATIVE	CENTRAL VALLEY WYE	CV-R1512-B
FRONTAGE ROAD AT M	PLAN AND PROFILE	SR 152 (NORTH) TO ROAD 19 WYE ALTERNATIVE	CENTRAL VALLEY WYE	CV-R1513-B
GENERAL NO	STAGE CONSTRUCTION PLAN	SR 152 (NORTH) TO ROAD 19 WYE ALTERNATIVE	CENTRAL VALLEY WYE	CV-I0001-B
SR 59/SR 152 ST/	STAGE CONSTRUCTION PLAN	SR 152 (NORTH) TO ROAD 19 WYE ALTERNATIVE	CENTRAL VALLEY WYE	СV-I4100-В
SR 59/SR 152 STA	STAGE CONSTRUCTION PLAN	SR 152 (NORTH) TO ROAD 19 WYE ALTERNATIVE	CENTRAL VALLEY WYE	CV-I4101-B
		DESIGNED BY		
CALIFOR		DRAWN BY LLS RECORD SET		
	ARSONS	W. JUHNSEN BURMITTAL		
	CALI	UN CHARGE NOT FOR C. LEMLEY CONSTRUCTION		
D RAIL AUTHORITY	I V HIGH-SPEEL			1

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MERCED TO FRESNO SECTION	
CENTRAL VALLEY WYE CIVIL AND GRADE SEPARATION PLANS	
INDEX OF DRAWINGS	
SHEET 9 OF 17	

	INDEX OF DRAWINGS			
DESCRIPTIO	TITLE	ALIGNMENT / PLAN SET	SECTION	DRAWING NO.
SR 59/SR 152 STA	STAGE CONSTRUCTION PLAN	SR 152 (NORTH) TO ROAD 19 WYE ALTERNATIVE	CENTRAL VALLEY WYE	CV-I4102-B
SR 59/SR 152 STA	STAGE CONSTRUCTION PLAN	SR 152 (NORTH) TO ROAD 19 WYE ALTERNATIVE	CENTRAL VALLEY WYE	CV-I4103-B
ROAD 9/SR 152 ST	STAGE CONSTRUCTION PLAN	SR 152 (NORTH) TO ROAD 19 WYE ALTERNATIVE	CENTRAL VALLEY WYE	CV-I4160-B
ROAD 9/SR 152 STA	STAGE CONSTRUCTION PLAN	SR 152 (NORTH) TO ROAD 19 WYE ALTERNATIVE	CENTRAL VALLEY WYE	CV-I4161-B
ROAD 9/SR 152 STA	STAGE CONSTRUCTION PLAN	SR 152 (NORTH) TO ROAD 19 WYE ALTERNATIVE	CENTRAL VALLEY WYE	CV-I4162-B
ROAD 9/SR 152 STA	STAGE CONSTRUCTION PLAN	SR 152 (NORTH) TO ROAD 19 WYE ALTERNATIVE	CENTRAL VALLEY WYE	CV-I4163-B
SR 233/SR 152 ST	STAGE CONSTRUCTION PLAN	SR 152 (NORTH) TO ROAD 19 WYE ALTERNATIVE	CENTRAL VALLEY WYE	CV-I4210-B
SR 233/SR 152 STA	STAGE CONSTRUCTION PLAN	SR 152 (NORTH) TO ROAD 19 WYE ALTERNATIVE	CENTRAL VALLEY WYE	CV-I4211-B
SR 233/SR 152 STA	STAGE CONSTRUCTION PLAN	SR 152 (NORTH) TO ROAD 19 WYE ALTERNATIVE	CENTRAL VALLEY WYE	CV-I4212-B
SR 233/SR 152 STA	STAGE CONSTRUCTION PLAN	SR 152 (NORTH) TO ROAD 19 WYE ALTERNATIVE	CENTRAL VALLEY WYE	CV-I4213-B
SR 233/SR 152 STA	STAGE CONSTRUCTION PLAN	SR 152 (NORTH) TO ROAD 19 WYE ALTERNATIVE	CENTRAL VALLEY WYE	CV-I4214-B
ROAD 16/SR 152 ST	STAGE CONSTRUCTION PLAN	SR 152 (NORTH) TO ROAD 19 WYE ALTERNATIVE	CENTRAL VALLEY WYE	CV-I4230-B
ROAD 16/SR 152 ST	STAGE CONSTRUCTION PLAN	SR 152 (NORTH) TO ROAD 19 WYE ALTERNATIVE	CENTRAL VALLEY WYE	CV-I4231-B
ROAD 16/SR 152 ST	STAGE CONSTRUCTION PLAN	SR 152 (NORTH) TO ROAD 19 WYE ALTERNATIVE	CENTRAL VALLEY WYE	CV-I4232-B
ROAD 16/SR 152 ST	STAGE CONSTRUCTION PLAN	SR 152 (NORTH) TO ROAD 19 WYE ALTERNATIVE	CENTRAL VALLEY WYE	CV-I4233-B
SR 99 TUNNEL STA	STAGE CONSTRUCTION PLAN	SR 152 (NORTH) TO ROAD 19 WYE ALTERNATIVE	CENTRAL VALLEY WYE	CV-I4520-B
SR 99 TUNNEL STA	STAGE CONSTRUCTION PLAN	SR 152 (NORTH) TO ROAD 19 WYE ALTERNATIVE	CENTRAL VALLEY WYE	CV-I4521-B
SR 99 TUNNEL STA	STAGE CONSTRUCTION PLAN	SR 152 (NORTH) TO ROAD 19 WYE ALTERNATIVE	CENTRAL VALLEY WYE	CV-I4522-B
SR 99 TUNNEL STA	STAGE CONSTRUCTION PLAN	SR 152 (NORTH) TO ROAD 19 WYE ALTERNATIVE	CENTRAL VALLEY WYE	CV-I4523-B
	TO ROAD 13 WYE ALTERNATIVE	AVENUE 21		
SHEET 1 OF	KEY MAP	AVENUE 21 TO ROAD 13 WYE ALTERNATIVE	CENTRAL VALLEY WYE	CV-B4050-C
SHEET 2 OF	KEY MAP	AVENUE 21 TO ROAD 13 WYE ALTERNATIVE	CENTRAL VALLEY WYE	CV-B4051-C
SHEET 3 OF	KEY MAP	AVENUE 21 TO ROAD 13 WYE ALTERNATIVE	CENTRAL VALLEY WYE	CV-B4052-C
SHEET 4 OF	KEY MAP	AVENUE 21 TO ROAD 13 WYE ALTERNATIVE	CENTRAL VALLEY WYE	CV-B4053-C
SHEET 1 OF	GEOMETRY DATA TABLE	AVENUE 21 TO ROAD 13 WYE ALTERNATIVE	CENTRAL VALLEY WYE	CV-B0060-C
SHEET 2 OF	GEOMETRY DATA TABLE	AVENUE 21 TO ROAD 13 WYE ALTERNATIVE	CENTRAL VALLEY WYE	CV-B0061-C
SHEET 1 OF	UTILITY CONFLICT TABLE	AVENUE 21 TO ROAD 13 WYE ALTERNATIVE	CENTRAL VALLEY WYE	CV-B0070-C
SHEET 2 OF	UTILITY CONFLICT TABLE	AVENUE 21 TO ROAD 13 WYE ALTERNATIVE	CENTRAL VALLEY WYE	CV-B0071-C
SHEET 3 OF	UTILITY CONFLICT TABLE	AVENUE 21 TO ROAD 13 WYE ALTERNATIVE	CENTRAL VALLEY WYE	CV-B0072-C
SHEET 4 OF	UTILITY CONFLICT TABLE	AVENUE 21 TO ROAD 13 WYE ALTERNATIVE	CENTRAL VALLEY WYE	CV-B0073-C
SHEET 1 OF	TYPICAL SECTION	AVENUE 21 TO ROAD 13 WYE ALTERNATIVE	CENTRAL VALLEY WYE	CV-B0080-C
SHEET 2 OF	TYPICAL SECTION	AVENUE 21 TO ROAD 13 WYE ALTERNATIVE	CENTRAL VALLEY WYE	CV-B0081-C
SJD-FRE STA 5338+00	CIVIL PLAN	AVENUE 21 TO ROAD 13 WYE ALTERNATIVE	CENTRAL VALLEY WYE	CV-S1010-C
SJD-FRE STA 5394+00	CIVIL PLAN	AVENUE 21 TO ROAD 13 WYE ALTERNATIVE	CENTRAL VALLEY WYE	CV-S1020-C
SJD-FRE STA 5450+00	CIVIL PLAN	AVENUE 21 TO ROAD 13 WYE ALTERNATIVE	CENTRAL VALLEY WYE	CV-S1030-C
SJD-FRE ACCESS	CIVIL PLAN	AVENUE 21 TO ROAD 13 WYE ALTERNATIVE	CENTRAL VALLEY WYE	CV-S1031-C
SJD-FRE STA 5506+00	CIVIL PLAN	AVENUE 21 TO ROAD 13 WYE ALTERNATIVE	CENTRAL VALLEY WYE	CV-S1040-C
SJD-FRE STA 5562+00	CIVIL PLAN	AVENUE 21 TO ROAD 13 WYE ALTERNATIVE	CENTRAL VALLEY WYE	CV-S1050-C
SJD-FRE STA 5618+00	CIVIL PLAN	AVENUE 21 TO ROAD 13 WYE ALTERNATIVE	CENTRAL VALLEY WYE	CV-S1060-C
SJD-FRE STA 5674+00	CIVIL PLAN	AVENUE 21 TO ROAD 13 WYE ALTERNATIVE	CENTRAL VALLEY WYE	CV-S1070-C
SJD-FRE STA 5730+00	CIVIL PLAN	AVENUE 21 TO ROAD 13 WYE ALTERNATIVE	CENTRAL VALLEY WYE	CV-S1080-C
CALIFOR		S. WELLS RECORD SET		
M		DRAWN BY W. JOHNSEN SUBMITTAL		
	ARSONS			
URIVIA	CALIFO.	IN CHARGE NOT FOR C. LEMLEY CONSTRUCTION		
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	CONTRACT NO.
NIA HIGH-SPEED TRAIN PROJ Merced to Fresno Section	ECI HSR08-05
CENTRAL VALLEY WYE	DRAWING NO. CV-B0011
CIVIL AND GRADE SEPARATION PLANS	SCALE NO SCALE
INDEX OF DRAWINGS SHEET 10 OF 17	SHEET NO.

		INDE	X OF DRAWINGS		
DRAWING NO.	SECTION	ALIGNMENT / PLAN SET	TITLE	DESCRIPTION	
CV-S1090-C	CENTRAL VALLEY WYE	AVENUE 21 TO ROAD 13 WYE ALTERNATIVE	CIVIL PLAN	SJD-FRE STA 5786+00 TO 5842+00	
CV-S1100-C	CENTRAL VALLEY WYE	AVENUE 21 TO ROAD 13 WYE ALTERNATIVE	CIVIL PLAN	SJD-FRE STA 5842+00 TO 5898+00	
CV-S1110-C	CENTRAL VALLEY WYE	AVENUE 21 TO ROAD 13 WYE ALTERNATIVE	CIVIL PLAN	SJD-FRE STA 5898+00 TO 5954+00	
CV-S1120-C	CENTRAL VALLEY WYE	AVENUE 21 TO ROAD 13 WYE ALTERNATIVE	CIVIL PLAN	SJD-FRE STA 5954+00 TO 6010+00	
CV-S1121-C	CENTRAL VALLEY WYE	AVENUE 21 TO ROAD 13 WYE ALTERNATIVE	CIVIL PLAN	SJD-FRE ACCESS ROAD	
CV-S1130-C	CENTRAL VALLEY WYE	AVENUE 21 TO ROAD 13 WYE ALTERNATIVE	CIVIL PLAN	SJD-FRE STA 6010+00 TO 6066+00	
CV-S1140-C	CENTRAL VALLEY WYE	AVENUE 21 TO ROAD 13 WYE ALTERNATIVE	CIVIL PLAN	SJD-FRE STA 6066+00 TO 6122+00	
CV-S1150-C	CENTRAL VALLEY WYE	AVENUE 21 TO ROAD 13 WYE ALTERNATIVE	CIVIL PLAN	SJD-FRE STA 6122+00 TO 6178+00	
CV-S1160-C	CENTRAL VALLEY WYE	AVENUE 21 TO ROAD 13 WYE ALTERNATIVE	CIVIL PLAN	SJD-FRE STA 6178+00 TO 6234+00	
CV-S1161-C	CENTRAL VALLEY WYE	AVENUE 21 TO ROAD 13 WYE ALTERNATIVE	CIVIL PLAN	SJD-FRE ACCESS ROAD	
CV-S1170-C	CENTRAL VALLEY WYE	AVENUE 21 TO ROAD 13 WYE ALTERNATIVE	CIVIL PLAN	SJD-FRE STA 6234+00 TO 6290+00	
CV-S1180-C	CENTRAL VALLEY WYE	AVENUE 21 TO ROAD 13 WYE ALTERNATIVE	CIVIL PLAN	SJD-FRE STA 6290+00 TO 6346+00	
CV-S1190-C	CENTRAL VALLEY WYE	AVENUE 21 TO ROAD 13 WYE ALTERNATIVE	CIVIL PLAN	SJD-FRE STA 6346+00 TO 6402+00	
CV-S1200-C	CENTRAL VALLEY WYE	AVENUE 21 TO ROAD 13 WYE ALTERNATIVE	CIVIL PLAN	SJD-FRE STA 6402+00 TO 6458+00	
CV-S1210-C	CENTRAL VALLEY WYE	AVENUE 21 TO ROAD 13 WYE ALTERNATIVE	CIVIL PLAN	SJD-FRE STA 6458+00 TO 6514+00	
CV-S1220-C	CENTRAL VALLEY WYE	AVENUE 21 TO ROAD 13 WYE ALTERNATIVE	CIVIL PLAN	SJD-FRE STA 6514+00 TO 6570+00	
CV-S1230-C	CENTRAL VALLEY WYE	AVENUE 21 TO ROAD 13 WYE ALTERNATIVE	CIVIL PLAN	SJD-FRE STA 6570+00 TO 6626+00	
CV-S1231-C	CENTRAL VALLEY WYE	AVENUE 21 TO ROAD 13 WYE ALTERNATIVE	CIVIL PLAN	SJD-FRE ACCESS ROAD	
CV-S1240-C	CENTRAL VALLEY WYE	AVENUE 21 TO ROAD 13 WYE ALTERNATIVE	CIVIL PLAN	SJD-FRE STA 6626+00 TO 6682+00	
CV-S1250-C	CENTRAL VALLEY WYE	AVENUE 21 TO ROAD 13 WYE ALTERNATIVE	CIVIL PLAN	SJD-FRE STA 6682+00 TO 6738+00	
CV-S1260-C	CENTRAL VALLEY WYE	AVENUE 21 TO ROAD 13 WYE ALTERNATIVE	CIVIL PLAN	SJD-FRE STA 6738+00 TO 6794+00	
CV-S1261-C	CENTRAL VALLEY WYE	AVENUE 21 TO ROAD 13 WYE ALTERNATIVE	CIVIL PLAN	SJD-FRE ACCESS ROAD	
CV-S1270-C	CENTRAL VALLEY WYE	AVENUE 21 TO ROAD 13 WYE ALTERNATIVE	CIVIL PLAN	SJD-FRE STA 6794+00 TO 6850+00	
CV-S1280-C	CENTRAL VALLEY WYE	AVENUE 21 TO ROAD 13 WYE ALTERNATIVE	CIVIL PLAN	SJD-FRE STA 6850+00 TO 6906+00	
CV-S1290-C	CENTRAL VALLEY WYE	AVENUE 21 TO ROAD 13 WYE ALTERNATIVE	CIVIL PLAN	SJD-FRE STA 6906+00 TO 6962+00	
CV-S1291-C	CENTRAL VALLEY WYE	AVENUE 21 TO ROAD 13 WYE ALTERNATIVE	CIVIL PLAN	SJD-FRE ACCESS ROAD	
CV-S1300-C	CENTRAL VALLEY WYE	AVENUE 21 TO ROAD 13 WYE ALTERNATIVE	CIVIL PLAN	SJD-FRE STA 6962+00 TO 7018+00	
CV-S1310-C	CENTRAL VALLEY WYE	AVENUE 21 TO ROAD 13 WYE ALTERNATIVE	CIVIL PLAN	SJD-FRE STA 7018+00 TO 7074+00	
CV-S1320-C	CENTRAL VALLEY WYE	AVENUE 21 TO ROAD 13 WYE ALTERNATIVE	CIVIL PLAN	SJD-FRE STA 7074+00 TO 7130+00	
CV-S1330-C	CENTRAL VALLEY WYE	AVENUE 21 TO ROAD 13 WYE ALTERNATIVE	CIVIL PLAN	SJD-FRE STA 7130+00 TO 7147+86.07	
CV-S1410-C	CENTRAL VALLEY WYE	AVENUE 21 TO ROAD 13 WYE ALTERNATIVE	CIVIL PLAN	MER-FRE STA 14840+00 TO 14896+00	
CV-S1420-C	CENTRAL VALLEY WYE	AVENUE 21 TO ROAD 13 WYE ALTERNATIVE	CIVIL PLAN	MER-FRE STA 14896+00 TO 14952+00	
CV-S1430-C	CENTRAL VALLEY WYE	AVENUE 21 TO ROAD 13 WYE ALTERNATIVE	CIVIL PLAN	MER-FRE STA 14952+00 TO 15008+00	
CV-S1440-C	CENTRAL VALLEY WYE	AVENUE 21 TO ROAD 13 WYE ALTERNATIVE	CIVIL PLAN	MER-FRE STA 15008+00 TO 15064+00	
CV-S1450-C	CENTRAL VALLEY WYE	AVENUE 21 TO ROAD 13 WYE ALTERNATIVE	CIVIL PLAN	MER-FRE STA 15064+00 TO 15120+00	
CV-S1460-C	CENTRAL VALLEY WYE	AVENUE 21 TO ROAD 13 WYE ALTERNATIVE	CIVIL PLAN	MER-FRE STA 15120+00 TO 15176+00	
CV-S1470-C	CENTRAL VALLEY WYE	AVENUE 21 TO ROAD 13 WYE ALTERNATIVE	CIVIL PLAN	MER-FRE STA 15176+00 TO 15232+00	
CV-S1480-C	CENTRAL VALLEY WYE	AVENUE 21 TO ROAD 13 WYE ALTERNATIVE	CIVIL PLAN	MER-FRE STA 15232+00 TO 15288+00	
CV-S1490-C	CENTRAL VALLEY WYE	AVENUE 21 TO ROAD 13 WYE ALTERNATIVE	CIVIL PLAN	MER-FRE STA 15288+00 TO 15344+00	
CV-S1500-C	CENTRAL VALLEY WYE	AVENUE 21 TO ROAD 13 WYE ALTERNATIVE	CIVIL PLAN	MER-FRE STA 15344+00 TO 15400+00	
CV-S1510-C	CENTRAL VALLEY WYE	AVENUE 21 TO ROAD 13 WYE ALTERNATIVE	CIVIL PLAN	MER-FRE STA 15400+00 TO 15456+00	
		DESIGNED BY S. WELLS RECORD SET		CALIFORNIA HIGH-SPEED TRAIN PROJECT	CONTRACT N
		W. JOHNSEN 15% DESIGN		MERCED TO FRESNO SECTION	DRAWING NO. CV-BO
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DRAWING NO.	SECTION	ALIGNMENT / PLAN SET	TITLE	DESCRIPTION	
CV-S1520-C	CENTRAL VALLEY WYE	AVENUE 21 TO ROAD 13 WYE ALTERNATIVE	CIVIL PLAN	MER-FRE STA 15456+00 TO 15512+00	
CV-S1530-C	CENTRAL VALLEY WYE	AVENUE 21 TO ROAD 13 WYE ALTERNATIVE	CIVIL PLAN	MER-FRE STA 15512+00 TO 15568+00	
CV-S1540-C	CENTRAL VALLEY WYE	AVENUE 21 TO ROAD 13 WYE ALTERNATIVE	CIVIL PLAN	MER-FRE STA 15568+00 TO 15624+00	
CV-S1550-C	CENTRAL VALLEY WYE	AVENUE 21 TO ROAD 13 WYE ALTERNATIVE	CIVIL PLAN	MER-FRE STA 15624+00 TO 15655+00	
CV-S1610-C	CENTRAL VALLEY WYE	AVENUE 21 TO ROAD 13 WYE ALTERNATIVE	CIVIL PLAN	SJD-MER STA 36268+00 TO 36324+00	
CV-S1620-C	CENTRAL VALLEY WYE	AVENUE 21 TO ROAD 13 WYE ALTERNATIVE	CIVIL PLAN	SJD-MER STA 36324+00 TO 36380+00	
CV-S1630-C	CENTRAL VALLEY WYE	AVENUE 21 TO ROAD 13 WYE ALTERNATIVE	CIVIL PLAN	SJD-MER STA 36380+00 TO 36436+00	
CV-S1640-C	CENTRAL VALLEY WYE	AVENUE 21 TO ROAD 13 WYE ALTERNATIVE	CIVIL PLAN	SJD-MER STA 36436+00 TO 36492+00	
CV-S1650-C	CENTRAL VALLEY WYE	AVENUE 21 TO ROAD 13 WYE ALTERNATIVE	CIVIL PLAN	SJD-MER STA 36492+00 TO 36548+00	
CV-S1660-C	CENTRAL VALLEY WYE	AVENUE 21 TO ROAD 13 WYE ALTERNATIVE	CIVIL PLAN	SJD-MER STA 36548+00 TO 36567+19	
CV-R1030-C	CENTRAL VALLEY WYE	AVENUE 21 TO ROAD 13 WYE ALTERNATIVE	PLAN AND PROFILE	HENRY MILLER ROAD REALIGNMENT	
CV-R1031-C	CENTRAL VALLEY WYE	AVENUE 21 TO ROAD 13 WYE ALTERNATIVE	PLAN AND PROFILE	HENRY MILLER ROAD REALIGNMENT	
CV-R1032-C	CENTRAL VALLEY WYE	AVENUE 21 TO ROAD 13 WYE ALTERNATIVE	PLAN AND PROFILE	HENRY MILLER ROAD REALIGNMENT	
CV-R1033-C	CENTRAL VALLEY WYE	AVENUE 21 TO ROAD 13 WYE ALTERNATIVE	PLAN AND PROFILE	HENRY MILLER ROAD REALIGNMENT	
CV-R1050-C	CENTRAL VALLEY WYE	AVENUE 21 TO ROAD 13 WYE ALTERNATIVE	PLAN AND PROFILE	INDIANA ROAD GRADE SEPARATION	
CV-R1051-C	CENTRAL VALLEY WYE	AVENUE 21 TO ROAD 13 WYE ALTERNATIVE	PLAN AND PROFILE	INDIANA ROAD GRADE SEPARATION	
CV-R1052-C	CENTRAL VALLEY WYE	AVENUE 21 TO ROAD 13 WYE ALTERNATIVE	PLAN AND PROFILE	HUTCHINS ROAD CONNECTOR	
CV-R1053-C	CENTRAL VALLEY WYE	AVENUE 21 TO ROAD 13 WYE ALTERNATIVE	PLAN AND PROFILE	HUTCHINS ROAD REALIGNMENT	
CV-R1054-C	CENTRAL VALLEY WYE	AVENUE 21 TO ROAD 13 WYE ALTERNATIVE	PLAN AND PROFILE	HUTCHINS ROAD REALIGNMENT	
CV-R1120-C	CENTRAL VALLEY WYE	AVENUE 21 TO ROAD 13 WYE ALTERNATIVE	PLAN AND PROFILE	ROAD 4/LINCOLN ROAD GRADE SEPARATION	
CV-R1121-C	CENTRAL VALLEY WYE	AVENUE 21 TO ROAD 13 WYE ALTERNATIVE	PLAN AND PROFILE	ROAD 4/LINCOLN ROAD GRADE SEPARATION	
CV-R1122-C	CENTRAL VALLEY WYE	AVENUE 21 TO ROAD 13 WYE ALTERNATIVE	PLAN AND PROFILE	ROAD 4/ LINCOLN ROAD CONNECTOR	
CV-R1123-C	CENTRAL VALLEY WYE	AVENUE 21 TO ROAD 13 WYE ALTERNATIVE	PLAN AND PROFILE	AVENUE 21 REALIGNMENT AT ROAD 4	
CV-R1160-C	CENTRAL VALLEY WYE	AVENUE 21 TO ROAD 13 WYE ALTERNATIVE	PLAN AND PROFILE	ROAD 9/HEMLOCK ROAD GRADE SEPARATION	
CV-R1161-C	CENTRAL VALLEY WYE	AVENUE 21 TO ROAD 13 WYE ALTERNATIVE	PLAN AND PROFILE	ROAD 9/HEMLOCK ROAD GRADE SEPARATION	
CV-R1162-C	CENTRAL VALLEY WYE	AVENUE 21 TO ROAD 13 WYE ALTERNATIVE	PLAN AND PROFILE	ROAD 9/AVENUE 21 CONNECTOR	
CV-R1180-C	CENTRAL VALLEY WYE	AVENUE 21 TO ROAD 13 WYE ALTERNATIVE	PLAN AND PROFILE	AVENUE 21 REALIGNMENT AT ROAD 11	
CV-R1200-C	CENTRAL VALLEY WYE	AVENUE 21 TO ROAD 13 WYE ALTERNATIVE	PLAN AND PROFILE	ROBERTSON BLVD GRADE SEPARATION	
CV-R1201-C	CENTRAL VALLEY WYE	AVENUE 21 TO ROAD 13 WYE ALTERNATIVE	PLAN AND PROFILE	ROBERTSON BLVD GRADE SEPARATION	
CV-R1202-C	CENTRAL VALLEY WYE	AVENUE 21 TO ROAD 13 WYE ALTERNATIVE	PLAN AND PROFILE	AVENUE 21/ROBERTSON BLVD CONNECTOR	
CV-R1203-C	CENTRAL VALLEY WYE	AVENUE 21 TO ROAD 13 WYE ALTERNATIVE	PLAN AND PROFILE	AVENUE 21 REALIGNMENT AT ROBERTSON BLVD	
CV-R1220-C	CENTRAL VALLEY WYE	AVENUE 21 TO ROAD 13 WYE ALTERNATIVE	PLAN AND PROFILE	AVENUE 21 REALIGNMENT AT ROAD 15	
CV-R1230-C	CENTRAL VALLEY WYE	AVENUE 21 TO ROAD 13 WYE ALTERNATIVE	PLAN AND PROFILE	ROAD 16 GRADE SEPARATION	
CV-R1231-C	CENTRAL VALLEY WYE	AVENUE 21 TO ROAD 13 WYE ALTERNATIVE	PLAN AND PROFILE	ROAD 16 GRADE SEPARATION	
CV-R1260-C	CENTRAL VALLEY WYE	AVENUE 21 TO ROAD 13 WYE ALTERNATIVE	PLAN AND PROFILE	ROAD 19 GRADE SEPARATION	
CV-R1261-C	CENTRAL VALLEY WYE	AVENUE 21 TO ROAD 13 WYE ALTERNATIVE	PLAN AND PROFILE	ROAD 19 GRADE SEPARATION	
CV-R1262-C	CENTRAL VALLEY WYE	AVENUE 21 TO ROAD 13 WYE ALTERNATIVE	PLAN AND PROFILE	AVENUE 21/ROAD 19 CONNECTOR	
CV-R1270-C	CENTRAL VALLEY WYE	AVENUE 21 TO ROAD 13 WYE ALTERNATIVE	PLAN AND PROFILE	FAIRMEAD BOULEVARD REALIGNMENT	
CV-R1290-C	CENTRAL VALLEY WYE	AVENUE 21 TO ROAD 13 WYE ALTERNATIVE	PLAN AND PROFILE	ROAD 22 GRADE SEPARATION	
CV-R1291-C	CENTRAL VALLEY WYE	AVENUE 21 TO ROAD 13 WYE ALTERNATIVE	PLAN AND PROFILE	ROAD 22 GRADE SEPARATION	
CV-R1292-C	CENTRAL VALLEY WYE	AVENUE 21 TO ROAD 13 WYE ALTERNATIVE	PLAN AND PROFILE	ROAD 22 GRADE SEPARATION	
			RSONS	IFORNIA INDEX OF DEAMINGS	ECT
1		C. LEMLEY CONSTRUCTION		INDEX OF DRAWINGS	SHEET NO

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p0021811 06-SEP-

			INDEX OF DRAWINGS	
DRAWING NO.	SECTION	ALIGNMENT / PLAN SET	TITLE	DESCRIPTION
CV-R1300-C	CENTRAL VALLEY WYE	AVENUE 21 TO ROAD 13 WYE ALTERNATIVE	PLAN AND PROFILE	AVENUE 20 1/2 GRADE SEPARATION
CV-R1301-C	CENTRAL VALLEY WYE	AVENUE 21 TO ROAD 13 WYE ALTERNATIVE	PLAN AND PROFILE	AVENUE 20 1/2 GRADE SEPARATION
CV-R1310-C	CENTRAL VALLEY WYE	AVENUE 21 TO ROAD 13 WYE ALTERNATIVE	PLAN AND PROFILE	ROAD 24 REALIGNMENT
CV-R1311-C	CENTRAL VALLEY WYE	AVENUE 21 TO ROAD 13 WYE ALTERNATIVE	PLAN AND PROFILE	ROAD 24 REALIGNMENT
CV-R1430-C	CENTRAL VALLEY WYE	AVENUE 21 TO ROAD 13 WYE ALTERNATIVE	PLAN AND PROFILE	ROAD 14 GRADE SEPARATION
CV-R1431-C	CENTRAL VALLEY WYE	AVENUE 21 TO ROAD 13 WYE ALTERNATIVE	PLAN AND PROFILE	ROAD 14 GRADE SEPARATION
CV-R1432-C	CENTRAL VALLEY WYE	AVENUE 21 TO ROAD 13 WYE ALTERNATIVE	PLAN AND PROFILE	AVENUE 21 1/2 GRADE SEPARATION
CV-R1433-C	CENTRAL VALLEY WYE	AVENUE 21 TO ROAD 13 WYE ALTERNATIVE	PLAN AND PROFILE	AVENUE 21 1/2 GRADE SEPARATION
CV-R1470-C	CENTRAL VALLEY WYE	AVENUE 21 TO ROAD 13 WYE ALTERNATIVE	PLAN AND PROFILE	AVENUE 25/WASHINGTON ROAD UNDERPASS
CV-R1471-C	CENTRAL VALLEY WYE	AVENUE 21 TO ROAD 13 WYE ALTERNATIVE	PLAN AND PROFILE	ROAD 13 REALIGNMENT
CV-R1490-C	CENTRAL VALLEY WYE	AVENUE 21 TO ROAD 13 WYE ALTERNATIVE	PLAN AND PROFILE	VISTA AVENUE/ROAD 13 REALIGNMENT
CV-R1491-C	CENTRAL VALLEY WYE	AVENUE 21 TO ROAD 13 WYE ALTERNATIVE	PLAN AND PROFILE	VISTA AVENUE/ROAD 13 REALIGNMENT
CV-R1500-C	CENTRAL VALLEY WYE	AVENUE 21 TO ROAD 13 WYE ALTERNATIVE	PLAN AND PROFILE	CROSS ROAD REALIGNMENT
CV-R1501-C	CENTRAL VALLEY WYE	AVENUE 21 TO ROAD 13 WYE ALTERNATIVE	PLAN AND PROFILE	CROSS ROAD REALIGNMENT
CV-R1502-C	CENTRAL VALLEY WYE	AVENUE 21 TO ROAD 13 WYE ALTERNATIVE	PLAN AND PROFILE	CROSS ROAD REALIGNMENT
CV-R1510-C	CENTRAL VALLEY WYE	AVENUE 21 TO ROAD 13 WYE ALTERNATIVE	PLAN AND PROFILE	ROAD 11 REALIGNMENT
CV-R1511-C	CENTRAL VALLEY WYE	AVENUE 21 TO ROAD 13 WYE ALTERNATIVE	PLAN AND PROFILE	ROAD 11 REALIGNMENT
CV-R1512-C	CENTRAL VALLEY WYE	AVENUE 21 TO ROAD 13 WYE ALTERNATIVE	PLAN AND PROFILE	ROAD 11 REALIGNMENT
CV-R1630-C	CENTRAL VALLEY WYE	AVENUE 21 TO ROAD 13 WYE ALTERNATIVE	PLAN AND PROFILE	AVENUE 21 1/2 SJD-MER GRADE SEPARATION
CV-R1631-C	CENTRAL VALLEY WYE	AVENUE 21 TO ROAD 13 WYE ALTERNATIVE	PLAN AND PROFILE	AVENUE 21 1/2 SJD-MER GRADE SEPARATION
CV-R1632-C	CENTRAL VALLEY WYE	AVENUE 21 TO ROAD 13 WYE ALTERNATIVE	PLAN AND PROFILE	ROAD 12 CONNECTOR ROAD
CV-I0001-C	CENTRAL VALLEY WYE	AVENUE 21 TO ROAD 13 WYE ALTERNATIVE	STAGE CONSTRUCTION PLAN	GENERAL NOTES
		SR 152 (NORT	H) TO ROAD 11 WYE ALTERNATIVE	
CV-B4050-D	CENTRAL VALLEY WYE	SR 152 (NORTH) TO ROAD 11 WYE ALTERNATIVE	KEY MAP	SHEET 1 OF 4
CV-B4051-D	CENTRAL VALLEY WYE	SR 152 (NORTH) TO ROAD 11 WYE ALTERNATIVE	KEY MAP	SHEET 2 OF 4
CV-B4052-D	CENTRAL VALLEY WYE	SR 152 (NORTH) TO ROAD 11 WYE ALTERNATIVE	KEY MAP	SHEET 3 OF 4
CV-B4053-D	CENTRAL VALLEY WYE	SR 152 (NORTH) TO ROAD 11 WYE ALTERNATIVE	KEY MAP	SHEET 4 OF 4
CV-B0060-D	CENTRAL VALLEY WYE	SR 152 (NORTH) TO ROAD 11 WYE ALTERNATIVE	GEOMETRY DATA TABLE	SHEET 1 OF 6
CV-B0061-D	CENTRAL VALLEY WYE	SR 152 (NORTH) TO ROAD 11 WYE ALTERNATIVE	GEOMETRY DATA TABLE	SHEET 2 OF 6
CV-B0062-D	CENTRAL VALLEY WYE	SR 152 (NORTH) TO ROAD 11 WYE ALTERNATIVE	GEOMETRY DATA TABLE	SHEET 3 OF 6
CV-B0063-D	CENTRAL VALLEY WYE	SR 152 (NORTH) TO ROAD 11 WYE ALTERNATIVE	GEOMETRY DATA TABLE	SHEET 4 OF 6
CV-B0064-D	CENTRAL VALLEY WYE	SR 152 (NORTH) TO ROAD 11 WYE ALTERNATIVE	GEOMETRY DATA TABLE	SHEET 5 OF 6
CV-B0065-D	CENTRAL VALLEY WYE	SR 152 (NORTH) TO ROAD 11 WYE ALTERNATIVE	GEOMETRY DATA TABLE	SHEET 6 OF 6
CV-B0070-D	CENTRAL VALLEY WYE	SR 152 (NORTH) TO ROAD 11 WYE ALTERNATIVE	UTILITY CONFLICT TABLE	SHEET 1 OF 4
CV-B0071-D	CENTRAL VALLEY WYE	SR 152 (NORTH) TO ROAD 11 WYE ALTERNATIVE	UTILITY CONFLICT TABLE	SHEET 2 OF 4
CV-B0072-D	CENTRAL VALLEY WYE	SR 152 (NORTH) TO ROAD 11 WYE ALTERNATIVE	UTILITY CONFLICT TABLE	SHEET 3 OF 4
CV-B0073-D	CENTRAL VALLEY WYE	SR 152 (NORTH) TO ROAD 11 WYE ALTERNATIVE	UTILITY CONFLICT TABLE	SHEET 4 OF 4
CV-B0080-D	CENTRAL VALLEY WYE	SR 152 (NORTH) TO ROAD 11 WYE ALTERNATIVE	TYPICAL SECTION	SHEET 1 OF 3
CV-B0081-D	CENTRAL VALLEY WYE	SR 152 (NORTH) TO ROAD 11 WYE ALTERNATIVE	TYPICAL SECTION	SHEET 2 OF 3
CV-B0082-D	CENTRAL VALLEY WYE	SR 152 (NORTH) TO ROAD 11 WYE ALTERNATIVE	TYPICAL SECTION	SHEET 3 OF 3

J. RAY UN CHARGE C. LEWLEY C.	p0021811 06-	Image: Second	IN CHARGE C. LEMLEY DATE		PARSONS		INDEX OF DRAWINGS	CONTRACT NO. HSR08-(DRAWING NO. CV-BOO SCALE NO SCAI SHEET NO.
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		INDE	K OF DRAWINGS	
DRAWING NO.	SECTION	ALIGNMENT / PLAN SET	TITLE	DESCRIPTION
CV-S1010-D	CENTRAL VALLEY WYE	SR 152 (NORTH) TO ROAD 11 WYE ALTERNATIVE	CIVIL PLAN	SJD-FRE STA 5338+00 TO 5394+00
CV-S1020-D	CENTRAL VALLEY WYE	SR 152 (NORTH) TO ROAD 11 WYE ALTERNATIVE	CIVIL PLAN	SJD-FRE STA 5394+00 TO 5450+00
CV-S1030-D	CENTRAL VALLEY WYE	SR 152 (NORTH) TO ROAD 11 WYE ALTERNATIVE	CIVIL PLAN	SJD-FRE STA 5450+00 TO 5506+00
CV-S1040-D	CENTRAL VALLEY WYE	SR 152 (NORTH) TO ROAD 11 WYE ALTERNATIVE	CIVIL PLAN	SJD-FRE STA 5506+00 TO 5562+00
CV-S1050-D	CENTRAL VALLEY WYE	SR 152 (NORTH) TO ROAD 11 WYE ALTERNATIVE	CIVIL PLAN	SJD-FRE STA 5562+00 TO 5618+00
CV-S1060-D	CENTRAL VALLEY WYE	SR 152 (NORTH) TO ROAD 11 WYE ALTERNATIVE	CIVIL PLAN	SJD-FRE STA 5618+00 TO 5674+00
CV-S1070-D	CENTRAL VALLEY WYE	SR 152 (NORTH) TO ROAD 11 WYE ALTERNATIVE	CIVIL PLAN	SJD-FRE STA 5674+00 TO 5730+00
CV-S1080-D	CENTRAL VALLEY WYE	SR 152 (NORTH) TO ROAD 11 WYE ALTERNATIVE	CIVIL PLAN	SJD-FRE STA 5730+00 TO 5786+00
CV-S1090-D	CENTRAL VALLEY WYE	SR 152 (NORTH) TO ROAD 11 WYE ALTERNATIVE	CIVIL PLAN	SJD-FRE STA 5786+00 TO 5842+00
CV-S1100-D	CENTRAL VALLEY WYE	SR 152 (NORTH) TO ROAD 11 WYE ALTERNATIVE	CIVIL PLAN	SJD-FRE STA 5842+00 TO 5898+00
CV-S1110-D	CENTRAL VALLEY WYE	SR 152 (NORTH) TO ROAD 11 WYE ALTERNATIVE	CIVIL PLAN	SJD-FRE STA 5898+00 TO 5954+00
CV-S1120-D	CENTRAL VALLEY WYE	SR 152 (NORTH) TO ROAD 11 WYE ALTERNATIVE	CIVIL PLAN	SJD-FRE STA 5954+00 TO 6010+00
CV-S1130-D	CENTRAL VALLEY WYE	SR 152 (NORTH) TO ROAD 11 WYE ALTERNATIVE	CIVIL PLAN	SJD-FRE STA 6010+00 TO 6066+00
CV-S1140-D	CENTRAL VALLEY WYE	SR 152 (NORTH) TO ROAD 11 WYE ALTERNATIVE	CIVIL PLAN	SJD-FRE STA 6066+00 TO 6122+00
CV-S1150-D	CENTRAL VALLEY WYE	SR 152 (NORTH) TO ROAD 11 WYE ALTERNATIVE	CIVIL PLAN	SJD-FRE STA 6122+00 TO 6178+00
CV-S1160-D	CENTRAL VALLEY WYE	SR 152 (NORTH) TO ROAD 11 WYE ALTERNATIVE	CIVIL PLAN	SJD-FRE STA 6178+00 TO 6234+00
CV-S1170-D	CENTRAL VALLEY WYE	SR 152 (NORTH) TO ROAD 11 WYE ALTERNATIVE	CIVIL PLAN	SJD-FRE STA 6234+00 TO 6290+00
CV-S1180-D	CENTRAL VALLEY WYE	SR 152 (NORTH) TO ROAD 11 WYE ALTERNATIVE	CIVIL PLAN	SJD-FRE STA 6290+00 TO 6346+00
CV-S1190-D	CENTRAL VALLEY WYE	SR 152 (NORTH) TO ROAD 11 WYE ALTERNATIVE	CIVIL PLAN	SJD-FRE STA 6346+00 TO 6402+00
CV-S1200-D	CENTRAL VALLEY WYE	SR 152 (NORTH) TO ROAD 11 WYE ALTERNATIVE	CIVIL PLAN	SJD-FRE STA 6402+00 TO 6458+00
CV-S1210-D	CENTRAL VALLEY WYE	SR 152 (NORTH) TO ROAD 11 WYE ALTERNATIVE	CIVIL PLAN	SJD-FRE STA 6458+00 TO 6514+00
CV-S1220-D	CENTRAL VALLEY WYE	SR 152 (NORTH) TO ROAD 11 WYE ALTERNATIVE	CIVIL PLAN	SJD-FRE STA 6514+00 TO 6570+00
CV-S1230-D	CENTRAL VALLEY WYE	SR 152 (NORTH) TO ROAD 11 WYE ALTERNATIVE	CIVIL PLAN	SJD-FRE STA 6570+00 TO 6626+00
CV-S1240-D	CENTRAL VALLEY WYE	SR 152 (NORTH) TO ROAD 11 WYE ALTERNATIVE	CIVIL PLAN	SJD-FRE STA 6626+00 TO 6682+00
CV-S1241-D	CENTRAL VALLEY WYE	SR 152 (NORTH) TO ROAD 11 WYE ALTERNATIVE	CIVIL PLAN	SJD-FRE ACCESS ROAD
CV-S1250-D	CENTRAL VALLEY WYE	SR 152 (NORTH) TO ROAD 11 WYE ALTERNATIVE	CIVIL PLAN	SJD-FRE STA 6682+00 TO 6738+00
CV-S1260-D	CENTRAL VALLEY WYE	SR 152 (NORTH) TO ROAD 11 WYE ALTERNATIVE	CIVIL PLAN	SJD-FRE STA 6738+00 TO 6794+00
CV-S1270-D	CENTRAL VALLEY WYE	SR 152 (NORTH) TO ROAD 11 WYE ALTERNATIVE	CIVIL PLAN	SJD-FRE STA 6794+00 TO 6850+00
CV-S1280-D	CENTRAL VALLEY WYE	SR 152 (NORTH) TO ROAD 11 WYE ALTERNATIVE	CIVIL PLAN	SJD-FRE STA 6850+00 TO 6906+00
CV-S1290-D	CENTRAL VALLEY WYE	SR 152 (NORTH) TO ROAD 11 WYE ALTERNATIVE	CIVIL PLAN	SJD-FRE STA 6906+00 TO 6962+00
CV-S1291-D	CENTRAL VALLEY WYE	SR 152 (NORTH) TO ROAD 11 WYE ALTERNATIVE	CIVIL PLAN	SJD-FRE ACCESS ROAD
CV-S1300-D	CENTRAL VALLEY WYE	SR 152 (NORTH) TO ROAD 11 WYE ALTERNATIVE	CIVIL PLAN	SJD-FRE STA 6962+00 TO 7018+00
CV-S1310-D	CENTRAL VALLEY WYE	SR 152 (NORTH) TO ROAD 11 WYE ALTERNATIVE	CIVIL PLAN	SJD-FRE STA 7018+00 TO 7074+00
CV-S1320-D	CENTRAL VALLEY WYE	SR 152 (NORTH) TO ROAD 11 WYE ALTERNATIVE	CIVIL PLAN	SJD-FRE STA 7074+00 TO 7130+00
CV-S1330-D	CENTRAL VALLEY WYE	SR 152 (NORTH) TO ROAD 11 WYE ALTERNATIVE	CIVIL PLAN	SJD-FRE STA 7130+00 TO 7170+94.51
CV-S1410-D	CENTRAL VALLEY WYE	SR 152 (NORTH) TO ROAD 11 WYE ALTERNATIVE	CIVIL PLAN	MER-FRE STA 15009+29.27 TO 15052+00
CV-S1420-D	CENTRAL VALLEY WYE	SR 152 (NORTH) TO ROAD 11 WYE ALTERNATIVE	CIVIL PLAN	MER-FRE STA 15052+00 TO 15108+00
CV-S1430-D	CENTRAL VALLEY WYE	SR 152 (NORTH) TO ROAD 11 WYE ALTERNATIVE	CIVIL PLAN	MER-FRE STA 15108+00 TO 15164+00
CV-S1440-D	CENTRAL VALLEY WYE	SR 152 (NORTH) TO ROAD 11 WYE ALTERNATIVE	CIVIL PLAN	MER-FRE STA 15164+00 TO 15220+00
CV-S1441-D	CENTRAL VALLEY WYE	SR 152 (NORTH) TO ROAD 11 WYE ALTERNATIVE	CIVIL PLAN	MER-FRE ACCESS ROAD

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-90						DESIGNED BY	RECORD SET		CALIFOR
						DRAWN BY W. JOHNSEN	15% DESIGN		N
						CHECKED BY	SUBMITTAL		
811						IN CHARGE	NOT FOR		(
021			_			C. LEMLEY	CONSTRUCTION	HIGH-SPEED RAIL AUTHORITY	
d	EV DATE	BY	СНК	APP	DESCRIPTION	09/09/2016			

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RNIA HIGH-SPEED TRAIN PROJECT MERCED TO FRESNO SECTION CENTRAL VALLEY WYE CIVIL AND GRADE SEPARATION PLANS INDEX OF DRAWINGS SHEET 14 OF 17

CONTRACT NO. HSR08-05

DRAWING NO. CV-B0015

SCALE NO SCALE

		INDE	X OF DRAWINGS	
DRAWING NO.	SECTION	ALIGNMENT / PLAN SET	TITLE	DESCRIPTION
CV-S1450-D	CENTRAL VALLEY WYE	SR 152 (NORTH) TO ROAD 11 WYE ALTERNATIVE	CIVIL PLAN	MER-FRE STA 15220+00 TO 15276+00
CV-S1460-D	CENTRAL VALLEY WYE	SR 152 (NORTH) TO ROAD 11 WYE ALTERNATIVE	CIVIL PLAN	MER-FRE STA 15276+00 TO 15332+00
V-S1470-D	CENTRAL VALLEY WYE	SR 152 (NORTH) TO ROAD 11 WYE ALTERNATIVE	CIVIL PLAN	MER-FRE STA 15332+00 TO 15388+00
CV-S1480-D	CENTRAL VALLEY WYE	SR 152 (NORTH) TO ROAD 11 WYE ALTERNATIVE	CIVIL PLAN	MER-FRE STA 15388+00 TO 15444+00
CV-S1490-D	CENTRAL VALLEY WYE	SR 152 (NORTH) TO ROAD 11 WYE ALTERNATIVE	CIVIL PLAN	MER-FRE STA 15444+00 TO 15500+00
CV-S1500-D	CENTRAL VALLEY WYE	SR 152 (NORTH) TO ROAD 11 WYE ALTERNATIVE	CIVIL PLAN	MER-FRE STA 15500+00 TO 15556+00
CV-S1510-D	CENTRAL VALLEY WYE	SR 152 (NORTH) TO ROAD 11 WYE ALTERNATIVE	CIVIL PLAN	MER-FRE STA 15556+00 TO 15612+00
CV-S1520-D	CENTRAL VALLEY WYE	SR 152 (NORTH) TO ROAD 11 WYE ALTERNATIVE	CIVIL PLAN	MER-FRE STA 15612+00 TO 15655+00
CV-S1610-D	CENTRAL VALLEY WYE	SR 152 (NORTH) TO ROAD 11 WYE ALTERNATIVE	CIVIL PLAN	SJD-MER STA 36134+00.59 TO 36184+00
CV-S1620-D	CENTRAL VALLEY WYE	SR 152 (NORTH) TO ROAD 11 WYE ALTERNATIVE	CIVIL PLAN	SJD-MER STA 36184+00 TO 36240+00
CV-S1630-D	CENTRAL VALLEY WYE	SR 152 (NORTH) TO ROAD 11 WYE ALTERNATIVE	CIVIL PLAN	SJD-MER STA 36240+00 TO 36296+00
CV-S1640-D	CENTRAL VALLEY WYE	SR 152 (NORTH) TO ROAD 11 WYE ALTERNATIVE	CIVIL PLAN	SJD-MER STA 36296+00 TO 36352+00
CV-S1650-D	CENTRAL VALLEY WYE	SR 152 (NORTH) TO ROAD 11 WYE ALTERNATIVE	CIVIL PLAN	SJD-MER STA 36352+00 TO 36408+00
CV-S1660-D	CENTRAL VALLEY WYE	SR 152 (NORTH) TO ROAD 11 WYE ALTERNATIVE	CIVIL PLAN	SJD-MER STA 36408+00 TO 36457+64.63
CV-R1030-D	CENTRAL VALLEY WYE	SR 152 (NORTH) TO ROAD 11 WYE ALTERNATIVE	PLAN AND PROFILE	HENRY MILLER ROAD REALIGNMENT
CV-R1031-D	CENTRAL VALLEY WYE	SR 152 (NORTH) TO ROAD 11 WYE ALTERNATIVE	PLAN AND PROFILE	HENRY MILLER ROAD REALIGNMENT
CV-R1032-D	CENTRAL VALLEY WYE	SR 152 (NORTH) TO ROAD 11 WYE ALTERNATIVE	PLAN AND PROFILE	HENRY MILLER ROAD REALIGNMENT
CV-R1033-D	CENTRAL VALLEY WYE	SR 152 (NORTH) TO ROAD 11 WYE ALTERNATIVE	PLAN AND PROFILE	HENRY MILLER ROAD REALIGNMENT
CV-R1050-D	CENTRAL VALLEY WYE	SR 152 (NORTH) TO ROAD 11 WYE ALTERNATIVE	PLAN AND PROFILE	INDIANA ROAD GRADE SEPARATION
CV-R1051-D	CENTRAL VALLEY WYE	SR 152 (NORTH) TO ROAD 11 WYE ALTERNATIVE	PLAN AND PROFILE	INDIANA ROAD GRADE SEPARATION
CV-R1090-D	CENTRAL VALLEY WYE	SR 152 (NORTH) TO ROAD 11 WYE ALTERNATIVE	PLAN AND PROFILE	COYOTE ROAD REALIGNMENT
CV-R1091-D	CENTRAL VALLEY WYE	SR 152 (NORTH) TO ROAD 11 WYE ALTERNATIVE	PLAN AND PROFILE	COYOTE ROAD REALIGNMENT
CV-R1100-D	CENTRAL VALLEY WYE	SR 152 (NORTH) TO ROAD 11 WYE ALTERNATIVE	PLAN AND PROFILE	SR 152 REALIGNMENT AT SR 59
CV-R1101-D	CENTRAL VALLEY WYE	SR 152 (NORTH) TO ROAD 11 WYE ALTERNATIVE	PLAN AND PROFILE	SR 152 REALIGNMENT AT SR 59
CV-R1102-D	CENTRAL VALLEY WYE	SR 152 (NORTH) TO ROAD 11 WYE ALTERNATIVE	PLAN AND PROFILE	SR 152 REALIGNMENT AT SR 59
CV-R1103-D	CENTRAL VALLEY WYE	SR 152 (NORTH) TO ROAD 11 WYE ALTERNATIVE	PLAN AND PROFILE	SR 152 REALIGNMENT AT SR 59
CV-R1104-D	CENTRAL VALLEY WYE	SR 152 (NORTH) TO ROAD 11 WYE ALTERNATIVE	PLAN AND PROFILE	SR 59/SR 152 EB OFF RAMP GRADE SEPARATION
CV-R1105-D	CENTRAL VALLEY WYE	SR 152 (NORTH) TO ROAD 11 WYE ALTERNATIVE	PLAN AND PROFILE	SR 59/SR 152 EB OFF RAMP GRADE SEPARATION
CV-R1106-D	CENTRAL VALLEY WYE	SR 152 (NORTH) TO ROAD 11 WYE ALTERNATIVE	PLAN AND PROFILE	SR 59/SR 152 WB ON RAMP GRADE SEPARATION
CV-R1107-D	CENTRAL VALLEY WYE	SR 152 (NORTH) TO ROAD 11 WYE ALTERNATIVE	PLAN AND PROFILE	SR 59/SR 152 WB ON RAMP GRADE SEPARATION
CV-R1108-D	CENTRAL VALLEY WYE	SR 152 (NORTH) TO ROAD 11 WYE ALTERNATIVE	PLAN AND PROFILE	SR 59/SR 152 WB OFF RAMP GRADE SEPARATION
CV-R1109-D	CENTRAL VALLEY WYE	SR 152 (NORTH) TO ROAD 11 WYE ALTERNATIVE	PLAN AND PROFILE	SR 59/SR 152 WB OFF RAMP GRADE SEPARATION
CV-R1110-D	CENTRAL VALLEY WYE	SR 152 (NORTH) TO ROAD 11 WYE ALTERNATIVE	PLAN AND PROFILE	SR 59/SR 152 EB LOOP ON RAMP
CV-R1111-D	CENTRAL VALLEY WYE	SR 152 (NORTH) TO ROAD 11 WYE ALTERNATIVE	PLAN AND PROFILE	ROAD 4/LINCOLN ROAD GRADE SEPARATION
CV-R1112-D	CENTRAL VALLEY WYE	SR 152 (NORTH) TO ROAD 11 WYE ALTERNATIVE	PLAN AND PROFILE	ROAD 4/LINCOLN ROAD GRADE SEPARATION
CV-R1160-D	CENTRAL VALLEY WYE	SR 152 (NORTH) TO ROAD 11 WYE ALTERNATIVE	PLAN AND PROFILE	ROAD 9/HEMLOCK ROAD GRADE SEPARATION
CV-R1161-D	CENTRAL VALLEY WYE	SR 152 (NORTH) TO ROAD 11 WYE ALTERNATIVE	PLAN AND PROFILE	ROAD 9/HEMLOCK ROAD GRADE SEPARATION
CV-R1162-D	CENTRAL VALLEY WYE	SR 152 (NORTH) TO ROAD 11 WYE ALTERNATIVE	PLAN AND PROFILE	SR 152 REALIGNMENT AT ROAD 9
CV-R1163-D	CENTRAL VALLEY WYE	SR 152 (NORTH) TO ROAD 11 WYE ALTERNATIVE	PLAN AND PROFILE	SR 152 REALIGNMENT AT ROAD 9
CV-R1164-D	CENTRAL VALLEY WYE	SR 152 (NORTH) TO ROAD 11 WYE ALTERNATIVE	PLAN AND PROFILE	SR 152 REALIGNMENT AT ROAD 9

p0021811 06-S	REV	DATE	BY	СНК	APP	DESCRIPTION	DESIGNED BY S. WELLS DRAWN BY W. JOHNSEN CHECKED BY J. RAY IN CHARGE C. LEMLEY DATE 09/09/2016	RECORD SET 15% DESIGN Submittal Not for Construction	PARSONS	CALIFORNIA HIGH-SPEED RAIL AUTHORITY	CALIFO
ă	REV	DATE	Вт	CHK	APP	DESCRIPTION	09/09/2016				

RNIA HIGH-SPEED TRAIN PROJECT MERCED TO FRESNO SECTION CENTRAL VALLEY WYE CIVIL AND GRADE SEPARATION PLANS INDEX OF DRAWINGS SHEET 15 OF 17

CONTRACT NO. HSR08-05

SHEET NO.

DRAWING NO. CV-B0016

SCALE NO SCALE

		INDE	X OF DRAWINGS	
DRAWING NO.	SECTION	ALIGNMENT / PLAN SET	TITLE	DESCRIPTION
CV-R1165-D	CENTRAL VALLEY WYE	SR 152 (NORTH) TO ROAD 11 WYE ALTERNATIVE	PLAN AND PROFILE	ROAD 9/SR 152 EB OFF RAMP
CV-R1166-D	CENTRAL VALLEY WYE	SR 152 (NORTH) TO ROAD 11 WYE ALTERNATIVE	PLAN AND PROFILE	ROAD 9/SR 152 EB ON RAMP
CV-R1167-D	CENTRAL VALLEY WYE	SR 152 (NORTH) TO ROAD 11 WYE ALTERNATIVE	PLAN AND PROFILE	ROAD 9/SR 152 LOOP RAMP
CV-R1168-D	CENTRAL VALLEY WYE	SR 152 (NORTH) TO ROAD 11 WYE ALTERNATIVE	PLAN AND PROFILE	ROAD 9/SR 152 WB ON RAMP
CV-R1169-D	CENTRAL VALLEY WYE	SR 152 (NORTH) TO ROAD 11 WYE ALTERNATIVE	PLAN AND PROFILE	ROAD 9/SR 152 WB OFF RAMP
CV-R1190-D	CENTRAL VALLEY WYE	SR 152 (NORTH) TO ROAD 11 WYE ALTERNATIVE	PLAN AND PROFILE	ROAD 12 GRADE SEPARATION
CV-R1191-D	CENTRAL VALLEY WYE	SR 152 (NORTH) TO ROAD 11 WYE ALTERNATIVE	PLAN AND PROFILE	ROAD 12 GRADE SEPARATION
CV-R1192-D	CENTRAL VALLEY WYE	SR 152 (NORTH) TO ROAD 11 WYE ALTERNATIVE	PLAN AND PROFILE	SR 152 REALIGNMENT AT ROAD 12
CV-R1193-D	CENTRAL VALLEY WYE	SR 152 (NORTH) TO ROAD 11 WYE ALTERNATIVE	PLAN AND PROFILE	SR 152 REALIGNMENT AT ROAD 12
CV-R1194-D	CENTRAL VALLEY WYE	SR 152 (NORTH) TO ROAD 11 WYE ALTERNATIVE	PLAN AND PROFILE	SR 152 REALIGNMENT AT ROAD 12
CV-R1200-D	CENTRAL VALLEY WYE	SR 152 (NORTH) TO ROAD 11 WYE ALTERNATIVE	PLAN AND PROFILE	SR 152 REALIGNMENT AT SR 233
CV-R1201-D	CENTRAL VALLEY WYE	SR 152 (NORTH) TO ROAD 11 WYE ALTERNATIVE	PLAN AND PROFILE	SR 152 REALIGNMENT AT SR 233
CV-R1202-D	CENTRAL VALLEY WYE	SR 152 (NORTH) TO ROAD 11 WYE ALTERNATIVE	PLAN AND PROFILE	SR 152 REALIGNMENT AT SR 233
V-R1203-D	CENTRAL VALLEY WYE	SR 152 (NORTH) TO ROAD 11 WYE ALTERNATIVE	PLAN AND PROFILE	SR 233/SR 152 EB OFF RAMP
CV-R1204-D	CENTRAL VALLEY WYE	SR 152 (NORTH) TO ROAD 11 WYE ALTERNATIVE	PLAN AND PROFILE	SR 233/SR 152 EB LOOP RAMP
CV-R1205-D	CENTRAL VALLEY WYE	SR 152 (NORTH) TO ROAD 11 WYE ALTERNATIVE	PLAN AND PROFILE	SR 233/SR 152 WB ON RAMP
CV-R1210-D	CENTRAL VALLEY WYE	SR 152 (NORTH) TO ROAD 11 WYE ALTERNATIVE	PLAN AND PROFILE	SR 233/ROBERTSON BLVD GRADE SEPARATION
CV-R1211-D	CENTRAL VALLEY WYE	SR 152 (NORTH) TO ROAD 11 WYE ALTERNATIVE	PLAN AND PROFILE	SR 233/ROBERTSON BLVD GRADE SEPARATION
CV-R1212-D	CENTRAL VALLEY WYE	SR 152 (NORTH) TO ROAD 11 WYE ALTERNATIVE	PLAN AND PROFILE	SR 233/SR 152 EB ON RAMP
CV-R1213-D	CENTRAL VALLEY WYE	SR 152 (NORTH) TO ROAD 11 WYE ALTERNATIVE	PLAN AND PROFILE	SR 233/SR 152 EB ON RAMP
CV-R1214-D	CENTRAL VALLEY WYE	SR 152 (NORTH) TO ROAD 11 WYE ALTERNATIVE	PLAN AND PROFILE	SR 233/SR 152 WB OFF RAMP
CV-R1224-D	CENTRAL VALLEY WYE	SR 152 (NORTH) TO ROAD 11 WYE ALTERNATIVE	PLAN AND PROFILE	SR 152 REALIGNMENT AT ROAD 16
CV-R1225-D	CENTRAL VALLEY WYE	SR 152 (NORTH) TO ROAD 11 WYE ALTERNATIVE	PLAN AND PROFILE	SR 152 REALIGNMENT AT ROAD 16
CV-R1226-D	CENTRAL VALLEY WYE	SR 152 (NORTH) TO ROAD 11 WYE ALTERNATIVE	PLAN AND PROFILE	SR 152 REALIGNMENT AT ROAD 16
CV-R1227-D	CENTRAL VALLEY WYE	SR 152 (NORTH) TO ROAD 11 WYE ALTERNATIVE	PLAN AND PROFILE	ROAD 16/SR 152 EB OFF RAMP
CV-R1228-D	CENTRAL VALLEY WYE	SR 152 (NORTH) TO ROAD 11 WYE ALTERNATIVE	PLAN AND PROFILE	ROAD 16/SR 152 EB OFF RAMP
CV-R1229-D	CENTRAL VALLEY WYE	SR 152 (NORTH) TO ROAD 11 WYE ALTERNATIVE	PLAN AND PROFILE	ROAD 16/SR 152 WB ON RAMP
CV-R1230-D	CENTRAL VALLEY WYE	SR 152 (NORTH) TO ROAD 11 WYE ALTERNATIVE	PLAN AND PROFILE	ROAD 16 GRADE SEPARATION
CV-R1231-D	CENTRAL VALLEY WYE	SR 152 (NORTH) TO ROAD 11 WYE ALTERNATIVE	PLAN AND PROFILE	ROAD 16 GRADE SEPARATION
CV-R1232-D	CENTRAL VALLEY WYE	SR 152 (NORTH) TO ROAD 11 WYE ALTERNATIVE	PLAN AND PROFILE	ROAD 16/SR 152 EB ON RAMP
CV-R1233-D	CENTRAL VALLEY WYE	SR 152 (NORTH) TO ROAD 11 WYE ALTERNATIVE	PLAN AND PROFILE	ROAD 16/SR 152 EB LOOP RAMP
CV-R1234-D	CENTRAL VALLEY WYE	SR 152 (NORTH) TO ROAD 11 WYE ALTERNATIVE	PLAN AND PROFILE	ROAD 16/SR 152 WB OFF RAMP
CV-R1235-D	CENTRAL VALLEY WYE	SR 152 (NORTH) TO ROAD 11 WYE ALTERNATIVE	PLAN AND PROFILE	ROAD 16 CONNECTOR REALIGNMENT
CV-R1240-D	CENTRAL VALLEY WYE	SR 152 (NORTH) TO ROAD 11 WYE ALTERNATIVE	PLAN AND PROFILE	ROAD 17 1/2 GRADE SEPARATION
CV-R1241-D	CENTRAL VALLEY WYE	SR 152 (NORTH) TO ROAD 11 WYE ALTERNATIVE	PLAN AND PROFILE	ROAD 17 1/2 GRADE SEPARATION
CV-R1242-D	CENTRAL VALLEY WYE	SR 152 (NORTH) TO ROAD 11 WYE ALTERNATIVE	PLAN AND PROFILE	ROAD 17 1/2 GRADE SEPARATION
CV-R1250-D	CENTRAL VALLEY WYE	SR 152 (NORTH) TO ROAD 11 WYE ALTERNATIVE	PLAN AND PROFILE	FAIRMEAD BOULEVARD REALIGNMENT
CV-R1260-D	CENTRAL VALLEY WYE	SR 152 (NORTH) TO ROAD 11 WYE ALTERNATIVE	PLAN AND PROFILE	ROAD 20 GRADE SEPARATION
CV-R1261-D	CENTRAL VALLEY WYE	SR 152 (NORTH) TO ROAD 11 WYE ALTERNATIVE	PLAN AND PROFILE	ROAD 20 GRADE SEPARATION
CV-R1280-D	CENTRAL VALLEY WYE	SR 152 (NORTH) TO ROAD 11 WYE ALTERNATIVE	PLAN AND PROFILE	ROAD 22 GRADE SEPARATION

S											
-90							DESIGNE S.	WELLS	RECORD SET		CALIFOR
							DRAWN W.	JOHNSEN	15% DESIGN		N
- -							CHECKE		SUBMITTAL		
1811							IN CHAF		NOT FOR Construction		
p0021	REV	DATE	BY	снк	APP	DESCF	DATE	/09/2016	CONSTRUCTION	HIGH-SPEED RAIL AUTHORITY	
L							00/	/03/2010			

RNIA HIGH-SPEED TRAIN PROJECT MERCED TO FRESNO SECTION CENTRAL VALLEY WYE CIVIL AND GRADE SEPARATION PLANS INDEX OF DRAWINGS SHEET 16 OF 17

CONTRACT NO. HSR08-05 DRAWING NO. CV-B0017

SCALE NO SCALE

	INDEX OF DRAWINGS					
DRAWING NO.	SECTION	ALIGNMENT / PLAN SET	TITLE	DESCRIPTION		
CV-R1281-D	CENTRAL VALLEY WYE	SR 152 (NORTH) TO ROAD 11 WYE ALTERNATIVE	PLAN AND PROFILE	ROAD 22 GRADE SEPARATION		
CV-R1290-D	CENTRAL VALLEY WYE	SR 152 (NORTH) TO ROAD 11 WYE ALTERNATIVE	PLAN AND PROFILE	AVENUE 22 REALIGNMENT		
CV-R1310-D	CENTRAL VALLEY WYE	SR 152 (NORTH) TO ROAD 11 WYE ALTERNATIVE	PLAN AND PROFILE	ROAD 24 REALIGNMENT		
CV-R1311-D	CENTRAL VALLEY WYE	SR 152 (NORTH) TO ROAD 11 WYE ALTERNATIVE	PLAN AND PROFILE	ROAD 24 REALIGNMENT		
CV-R1312-D	CENTRAL VALLEY WYE	SR 152 (NORTH) TO ROAD 11 WYE ALTERNATIVE	PLAN AND PROFILE	ROAD 24 REALIGNMENT		
CV-R1313-D	CENTRAL VALLEY WYE	SR 152 (NORTH) TO ROAD 11 WYE ALTERNATIVE	PLAN AND PROFILE	AVENUE 20 1/2 GRADE SEPARATION		
CV-R1314-D	CENTRAL VALLEY WYE	SR 152 (NORTH) TO ROAD 11 WYE ALTERNATIVE	PLAN AND PROFILE	AVENUE 20 1/2 GRADE SEPARATION		
CV-R1320-D	CENTRAL VALLEY WYE	SR 152 (NORTH) TO ROAD 11 WYE ALTERNATIVE	PLAN AND PROFILE	AVENUE 20 REALIGNMENT		
CV-R1321-D	CENTRAL VALLEY WYE	SR 152 (NORTH) TO ROAD 11 WYE ALTERNATIVE	PLAN AND PROFILE	AVENUE 20 REALIGNMENT		
CV-R1450-D	CENTRAL VALLEY WYE	SR 152 (NORTH) TO ROAD 11 WYE ALTERNATIVE	PLAN AND PROFILE	AVENUE 25 GRADE SEPARATION		
CV-R1451-D	CENTRAL VALLEY WYE	SR 152 (NORTH) TO ROAD 11 WYE ALTERNATIVE	PLAN AND PROFILE	AVENUE 25 GRADE SEPARATION		
CV-R1490-D	CENTRAL VALLEY WYE	SR 152 (NORTH) TO ROAD 11 WYE ALTERNATIVE	PLAN AND PROFILE	ATHLONE ROAD REALIGNMENT		
CV-R1491-D	CENTRAL VALLEY WYE	SR 152 (NORTH) TO ROAD 11 WYE ALTERNATIVE	PLAN AND PROFILE	ATHLONE ROAD REALIGNMENT		
CV-R1630-D	CENTRAL VALLEY WYE	SR 152 (NORTH) TO ROAD 11 WYE ALTERNATIVE	PLAN AND PROFILE	ROAD 10 REALIGNMENT		
CV-R1631-D	CENTRAL VALLEY WYE	SR 152 (NORTH) TO ROAD 11 WYE ALTERNATIVE	PLAN AND PROFILE	ROAD 10 REALIGNMENT		
CV-R1632-D	CENTRAL VALLEY WYE	SR 152 (NORTH) TO ROAD 11 WYE ALTERNATIVE	PLAN AND PROFILE	AVENUE 23 1/2 GRADE SEPARATION		
CV-R1633-D	CENTRAL VALLEY WYE	SR 152 (NORTH) TO ROAD 11 WYE ALTERNATIVE	PLAN AND PROFILE	AVENUE 23 1/2 GRADE SEPARATION		
CV-R1650-D	CENTRAL VALLEY WYE	SR 152 (NORTH) TO ROAD 11 WYE ALTERNATIVE	PLAN AND PROFILE	ROAD 11 REALIGNMENT		
CV-R1651-D	CENTRAL VALLEY WYE	SR 152 (NORTH) TO ROAD 11 WYE ALTERNATIVE	PLAN AND PROFILE	ROAD 11 REALIGNMENT		
CV-I0001-D	CENTRAL VALLEY WYE	SR 152 (NORTH) TO ROAD 11 WYE ALTERNATIVE	STAGE CONSTRUCTION PLAN	GENERAL NOTES		
CV-I4100-D	CENTRAL VALLEY WYE	SR 152 (NORTH) TO ROAD 11 WYE ALTERNATIVE	STAGE CONSTRUCTION PLAN	SR 59/SR 152 STAGE 1 OF 4		
CV-I4101-D	CENTRAL VALLEY WYE	SR 152 (NORTH) TO ROAD 11 WYE ALTERNATIVE	STAGE CONSTRUCTION PLAN	SR 59/SR 152 STAGE 2 OF 4		
CV-I4102-D	CENTRAL VALLEY WYE	SR 152 (NORTH) TO ROAD 11 WYE ALTERNATIVE	STAGE CONSTRUCTION PLAN	SR 59/SR 152 STAGE 3 OF 4		
CV-I4103-D	CENTRAL VALLEY WYE	SR 152 (NORTH) TO ROAD 11 WYE ALTERNATIVE	STAGE CONSTRUCTION PLAN	SR 59/SR 152 STAGE 4 OF 4		
CV-I4160-D	CENTRAL VALLEY WYE	SR 152 (NORTH) TO ROAD 11 WYE ALTERNATIVE	STAGE CONSTRUCTION PLAN	ROAD 9/SR 152 STAGE 1 OF 4		
CV-I4161-D	CENTRAL VALLEY WYE	SR 152 (NORTH) TO ROAD 11 WYE ALTERNATIVE	STAGE CONSTRUCTION PLAN	ROAD 9/SR 152 STAGE 2 OF 4		
CV-I4162-D	CENTRAL VALLEY WYE	SR 152 (NORTH) TO ROAD 11 WYE ALTERNATIVE	STAGE CONSTRUCTION PLAN	ROAD 9/SR 152 STAGE 3 OF 4		
CV-I4163-D	CENTRAL VALLEY WYE	SR 152 (NORTH) TO ROAD 11 WYE ALTERNATIVE	STAGE CONSTRUCTION PLAN	ROAD 9/SR 152 STAGE 4 OF 4		
CV-I4210-D	CENTRAL VALLEY WYE	SR 152 (NORTH) TO ROAD 11 WYE ALTERNATIVE	STAGE CONSTRUCTION PLAN	SR 233/SR 152 STAGE 1 OF 5		
CV-I4211-D	CENTRAL VALLEY WYE	SR 152 (NORTH) TO ROAD 11 WYE ALTERNATIVE	STAGE CONSTRUCTION PLAN	SR 233/SR 152 STAGE 2 OF 5		
CV-I4212-D	CENTRAL VALLEY WYE	SR 152 (NORTH) TO ROAD 11 WYE ALTERNATIVE	STAGE CONSTRUCTION PLAN	SR 233/SR 152 STAGE 3 OF 5		
CV-I4213-D	CENTRAL VALLEY WYE	SR 152 (NORTH) TO ROAD 11 WYE ALTERNATIVE	STAGE CONSTRUCTION PLAN	SR 233/SR 152 STAGE 4 OF 5		
CV-I4214-D	CENTRAL VALLEY WYE	SR 152 (NORTH) TO ROAD 11 WYE ALTERNATIVE	STAGE CONSTRUCTION PLAN	SR 233/SR 152 STAGE 5 OF 5		
CV-14230-D	CENTRAL VALLEY WYE	SR 152 (NORTH) TO ROAD 11 WYE ALTERNATIVE	STAGE CONSTRUCTION PLAN	ROAD 16/SR 152 STAGE 1 OF 4		
CV-I4231-D	CENTRAL VALLEY WYE	SR 152 (NORTH) TO ROAD 11 WYE ALTERNATIVE	STAGE CONSTRUCTION PLAN	ROAD 16/SR 152 STAGE 2 OF 4		
CV-I4232-D	CENTRAL VALLEY WYE	SR 152 (NORTH) TO ROAD 11 WYE ALTERNATIVE	STAGE CONSTRUCTION PLAN	ROAD 16/SR 152 STAGE 3 OF 4		
CV-I4233-D	CENTRAL VALLEY WYE	SR 152 (NORTH) TO ROAD 11 WYE ALTERNATIVE	STAGE CONSTRUCTION PLAN	ROAD 16/SR 152 STAGE 4 OF 4		

				DESIGNED BY	RECORD SET			CALIFOR
	_			DRAWN BY W. JOHNSEN	15% DESIGN			M
	_			CHECKED BY	SUBMITTAL	PARSONS		
	_	_		J. RAY	NOT FOR			С
				C. LEMLEY	CONSTRUCTION		HIGH-SPEED RAIL AUTHORITY	
DATE B	r снк	APP	DESCRIPTION	09/09/2016				

-70

RNIA HIGH-SPEED TRAIN PROJECT MERCED TO FRESNO SECTION CENTRAL VALLEY WYE CIVIL AND GRADE SEPARATION PLANS INDEX OF DRAWINGS SHEET 17 OF 17

CONTRACT NO. HSR08-05

DRAWING NO. CV-B0018

SCALE NO SCALE

	(<u> </u>		(<u> </u>	
AB	AGGREGATE BASE	САА	CABLE ANCHOR ASSEMBLY	
ABBC	ASBESTOS BONDED BITUMINOUS COATED	CAP	CORRUGATED ALUMINUM PIPE	
ABM	AIR-BLOWN MORTAR	CAPA	CORRUGATED ALUMINUM PIPE ARCH	
ABN	ABANDON	CAS	CONSTRUCTION AREA SIGN	
ABUT	ABUTMENT	СВ	CONCRETE BARRIER	
AC	ASPHALT CONCRETE	CBW	CONCRETE BLOCK WALL	
ACB	ASPHALT CONCRETE BASE	C-C	CENTER TO CENTER	
ACP	ASBESTOS CEMENT PIPE	CHSRA	CALIFORNIA HIGH-SPEED RAIL	
ADL	ADDED DEAD LOAD		AUTHORITY (SEE AUTHORITY)	
ADJ	ADJUST	CHSR	CALIFORNIA HIGH-SPEED RAIL	
AFES	ALTERNATIVE FLARED END SECTION	CHST	CALIFORNIA HIGH-SPEED TRAIN	
AHD	AHEAD	CG	CENTER OF GRAVITY	
ALT	ALTERNATE	CHNL	CHANNEL	
AM	TIME FROM MIDNIGHT TO NOON	CI	CAST IRON	
AP	ALTERNATIVE PIPE	CIDH	CAST-IN-DRILLED-HOLE	
APC	ALTERNATIVE PIPE CULVERT	CIP	CAST-IN-PLACE, CAST IRON PIPE	
APPROX	APPROXIMATE	CIPCP	CAST-IN-PLACE CONCRETE PIPE	
APU	ALTERNATIVE PIPE UNDERDRAIN	CISS	CAST-IN-STEEL SHELL	
AR	ACCESS RESTRICTION	CJP	COMPLETE JOINT PENETRATION	
ARS	ACCELERATION RESPONSE SPECTRUM	CL	CHAIN LINK, CLASS	
AS	AGGREGATE SUBBASE	CL-6	CHAIN LINK FENCE (6 FT)	
ASRP	ALUMINUM SPIRAL RIB PIPE	CLR	CLEAR, CLEARANCE	
ASSY	ASSEMBLY	CM	CORRUGATED METAL	
ATC	AUTOMATIC TRAIN CONTROL	CMP	CORRUGATED METAL PIPE	
ATPB	ASPHALT TREATED PERMEABLE BASE	CO	COUNTY	
ATPM	ASPHALT TREATED PERMEABLE MATERIAL	COL	COLUMN	
AUTHORITY			CONCRETE	
AVE	AVENUE	COND	CONDUIT	
AVG	AVERAGE	CONN	CONNECTOR	
@	AT	CONST	CONSTRUCT, CONSTRUCTION	
	(<u> </u>	CONT	CONTINUOUS	
BAGR		COORD	COORDINATE	
	BRIDGE APPROACH GUARD RAILING	CP	CANDLEPOWER	
BB B-B	BEGINNING OF BRIDGE	CP1	CONSTRUCTION PACKAGE 1	
B-B BC	BACK-TO-BACK BEGIN HORIZONTAL CURVE	CR CRCP	CREEK CONTINUOUS REINFORCED CONCRETE PAV	
BCR	BEGIN CURB RETURN	CRSP	CONCRETED ROCK SLOPE PROTECTION	
BEG	BEGIN CORD RETORN BEGIN	CRZ		
BIT CTD	BITUMINOUS COATED	CS	CLEAR RECOVERY ZONE	
BITCTD	BACK	CSP	CURVE SPIRAL POINT CORRUGATED STEEL PIPE	
BKF	BACKFILL	CSPA	CORRUGATED STEEL PIPE ARCH	
BLDG	BUILDING	СТВ	CORROGATED STEEL FIFE ARCH CEMENT TREATED BASE	
BLDG		СТРВ		
BLWD	BRIDGE-LOG MILE BOULEVARD	СТРВ	CEMENT TREATED PERMEABLE BASE CEMENT TREATED PERMEABLE MATERIAL	
BLVD				
	BENCH MARK	CTRS CULV		
BOT	BOTTOM		CULVERT	
BNSF BR	BNSF RAILWAY	¢_	CENTERLINE	
BRG	BRIDGE			
BRG	BEARING REGIN TUNNEL	D	DEPTH	
BTU	BEGIN TUNNEL BRITISH THERMAL UNIT		DEPTH DOWNDRAIN	
BVC	BRITISH THERMAL UNIT BEGIN VERTICAL CURVE	DD DBL		
BW	BARBED WIRE	DEC	DOUBLE DEGREE	
DW	DARDED WIRE	DEG	DELINEATOR	
			DESIGNED BY S. WELLS RECORD SET	
			DRAWN BY Wa JOHNSEN 15% DESIGN	
1 1			J. RAY	
			IN CHARGE NOT FOR C. LEMLEY CONSTRUCTION	

		(<u>d</u> continued)	
	DET	DETAIL, DETOUR	FNTB
	DF	DOUGLAS FIR, DIRECT FIXATION	FOB
	DI	DRAINAGE INLET, DROP INLET	FOC
	DIA	DIAMETER	FR RD
	DIAPH	DIAPHRAGM	FRE
	DIST	DISTANCE, DISTRICT	FS
	DMBB	DOUBLE METAL BEAM BARRIER	FSBT
	DR	DRIVE	FTG
	DTBB	DOUBLE THRIE BEAM BARRIER	FWBT
	DWY	DRIVEWAY	FWY
		(E)	
	_		
	E	EAST	G
	EA	ACTUAL SUPERELEVATION	
	EASE	EASEMENT	GA
	EB	END OF BRIDGE, EASTBOUND	GALV
	EC	END HORIZONTAL CURVE	GP
	ECR	END CURB RETURN	GR
	ED	EDGE DRAIN	GRDR
	EDC	EDGE DRAIN CLEANOUT	GSP
	EDO	EDGE DRAIN OUTLET	GTR
	EDV	EDGE DRAIN VENT	
	ELEC	ELECTROLIER	
	ELECT	ELECTRIC	Н
	ELEV	ELEVATION	H, HR
	ЕМВ	EMBANKMENT	HD
	ENGR	ENGINEER	HDWL
	EOD	EDGE OF DECK	HEX HD
	EP	EDGE OF PAVEMENT	НИА
	EQ	EQUATION	HORIZ
	ES	EDGE OF SHOULDER	HP
	ET	END TUNNEL	HPS
	ETW	EDGE OF TRAVELED WAY	HS
	EU	UNBALANCED SUPERELEVATION	HSR
	EVC		
т		END VERTICAL CURVE	HST
IT	EW	ENDWALL	HW
	EXC	EXCAVATION	
	EXIST, (E)		
	EXP	EXPANSION, EXPRESSWAY	HWM
	EXP JT	EXPANSION JOINT	HWY
	EXT	EXTERIOR	
		F	IB
	F & C	FRAME AND COVER	ID
	F & G	FRAME AND GRATE	IF
	FB	FLOOR BEAM	INT
	FDN	FOUNDATION	INV
	FEBT	FACING EASTBOUND TRAFFIC	
			IRR
	FES	FLARED END SECTION	IS
	FF	FILTER FABRIC	
	FG	FINISHED GRADE	107
	FH	FIRE HYDRANT	JCT
	FIG	FIGURE	JP
	FL	FLOW LINE	JPCP

PARSONS



HOUR
HORIZONTAL DRAIN
HEADWALL
HEXAGONAL HEAD
HOT MIXED ASPHA
HORIZONTAL
HINGE POINT, HOR
HIGH PERFORMANCE
HIGH STRENGTH
HIGH-SPEED RAIL
HIGH-SPEED TRAIN
HEADWALL,
100-YR HIGH WATE
OTHERWISE)
HIGH WATER MARK
HIGHWAY
T
IMPORTED BORROW
INSIDE DIAMETER
INSIDE FACE
INTERIOR
INVERT
IRRIGATION
INTERLOCKING SIT

\square		J
JUNCT	ION	
JOINT	POLE	

CALIFORNIA HIGH-SPEED RAIL AUTHORITY

(<u>f continued</u>)		(J CONTIN	UED)
FACING NORTHBOUND TRAFFIC	JS	JUNCTION STRUCTU	JRE
FREE ON BOARD	JT	JOINT	
FACE OF CONCRETE			
FRONTAGE ROAD)
FRESNO	L	LENGTH	
FAR SIDE, FINISHED SURFACE	LAT	LATITUDE	
FACING SOUTHBOUND TRAFFIC	LCB	LEAN CONCRETE B	ASE
FOOTING	LLT	LAST LONG TIE	
FACING WESTBOUND TRAFFIC	LN	LANE	
FREEWAY	LOC	LOCATION	
G	LOL	LAYOUT LINE	
	LONG	LONGITUDE	
GRADE, ACCELERATION DUE TO	LONGIT	LONGITUDINAL	
GRAVITY	LS	LUMP SUM, LENGTH	I OF SPIRAL
GAGE	LT	LEFT	
GALVANIZED	LVC	LENGTH OF VERTIC	JAL CURVE
GRADING PLANE		M	
GUARD RAILING			
GIRDER	MAINT	MAINTENANCE	
GALVANIZED STEEL PIPE GUTTER	MAX MB	MAXIMUM	
GOTTER	MBB	METAL BEAM METAL BEAM BARR	IED
(H)	MBGR	METAL BEAM GUAR	
HEIGHT	MED	METAL BEAM GOAR	D RAILING
HOUR	MER	MERCED	
HORIZONTAL DRAIN	MEN	MERCED TO FRESH	0
HEADWALL	MH	MANHOLE	0
HEXAGONAL HEAD	MIN	MINIMUM	
HOT MIXED ASPHALT	MISC	MISCELLANEOUS	
HORIZONTAL		MISCELLANEOUS IF	ON AND STEEL
HINGE POINT, HORSEPOWER	MKR	MARKER	
HIGH PERFORMANCE STEEL	MOD	MODIFIED, MODIFY	
HIGH STRENGTH	MON	MONUMENT	
HIGH-SPEED RAIL	MOW	MAINTENANCE-OF-W	WAY FACILITY
HIGH-SPEED TRAIN	MP	METAL PLATE	
HEADWALL,	MPGR	METAL PLATE GUA	RD RAILING
100-YR HIGH WATER (UNLESS NOTED	MPH	MILES PER HOUR	
OTHERWISE)	MR	MOVEMENT RATING	
HIGH WATER MARK	MSE	MECHANICALLY STA	ABILIZED EARTH
HIGHWAY	MTL	MATERIAL	
T		(N	
IMPORTED BORROW	Ν	NORTH	
INSIDE DIAMETER	NB	NORTHBOUND	
INSIDE FACE	NC	NORMAL CROWN	
INTERIOR	NIC	NOT IN CONTRACT	
INVERT	NO.	NUMBER (MUST HAV	
IRRIGATION	NOS.	NUMBERS (MUST H	
INTERLOCKING SITE	NPS	NOMINAL PIPE SIZ	Ł
	NS	NEAR SIDE	
	NTS	NOT TO SCALE	
JUNCTION		0	
JOINT POLE JOINTED PLAIN CONCRETE PAVEMENT	OBLR	OBLITERATE	
			CONTRACT NO.
CALIFORNIA HIGH-SPE Merced to fre			HSR08-05
CENTRAL VA			DRAWING NO. CV-B0020
CIVIL AND GRADE SE		LANS	SCALE NO SCALE
ABBREVIA			NU SCALE SHEET NO.
SHEET 1	UF 2		

(O CONTINUED)

ΡVΙ

PVMT

PVT

QTY

R

R & D

R & S

R/C

RCA

RCB

RCP

RCPA

REINF

RD

REL

REPL

RET

REV

RDWY

RM

RΡ

RR

RSP

RΤ

RTE

RW

R/W

RWY

S

SAE

SALV

SAPP

W. JOHNSEN

CHECKED BY

IN CHARGE C. LEMLEY

08/12/2016

SB

DESCRIPTION

	(U CONTINUED)
OC	OVERCROSSING
OCS	OVERHEAD CONTACT SYSTEM
OD	OUTSIDE DIAMETER
OF	OUTSIDE FACE
OG	ORIGINAL GROUND
OGAC	OPEN GRADED ASPHALT CONCRETE
OH	OVERHEAD
0-0	
OPP	OPPOSITE
	(<u> </u>
Р	PAGE
PAP	PERFORATED ALUMINUM PIPE
РВ	PULL BOX, PHASE BREAK
PC	POINT OF CURVATURE, PRECAST
PCC	POINT OF COMPOUND CURVE.
	PORTLAND CEMENT CONCRETE
РСР	PERFORATED CONCRETE PIPE,
	PRESTRESSED CONCRETE PIPE
PCVC	POINT OF COMPOUND VERTICAL CURVE
PED	PEDESTRIAN
	PEDESTRIAN OVERCROSSING
	PEDESTRIAN UNDERCROSSING
	PERMEABLE MATERIAL
PG	PROFILE GRADE
PG&E	PACIFIC GAS AND ELECTRIC
PI	POINT OF INTERSECTION
PITO	POINT OF INTERSECTION TURNOUT
PJP	PARTIAL JOINT PENETRATION
Æ, PL	PLATE
P/L	PROPERTY LINE
РМ	POST MILE,
	TIME FROM NOON TO MIDNIGHT
PN	PAVING NOTCH
POB	POINT OF BEGINNING
POC	POINT OF HORIZONTAL CURVE
POE	POINT OF END
POT	POINT OF TANGENT
POVC	POINT OF VERTICAL CURVE
PP	PIPE PILE, PLASTIC PIPE,
	POWER POLE
PPL	PREFORMED PERMEABLE LINER
PPP	PERFORATED PLASTIC PIPE
PRC	POINT OF REVERSE CURVE
PRF	PAVEMENT REINFORCING FABRIC
PRVC	POINT OF REVERSE VERTICAL CURVE
PS&E	PLANS, SPECIFICATIONS AND ESTIMATES
PS, P/S	POINT OF SWITCH, PRESTRESSED,
	PARALLELING STATION
PSP	PERFORATED STEEL PIPE
PT	POINT OF TANGENCY
PVC	POLYVINYL CHLORIDE,
	POINT OF VERTICAL CURVE

(P CONTINUED)
POINT OF VERTICAL INTERSECTION PAVEMENT
POINT OF VERTICAL TANGENT
QUANTITY
R
RADIUS
REMOVE AND DISPOSE
REMOVE AND SALVAGE
RATE OF CHANGE
REINFORCED CONCRETE ARCH
REINFORCED CONCRETE BOX
REINFORCED CONCRETE PIPE
REINFORCED CONCRETE PIPE ARCH ROAD
REINFORCED, REINFORCEMENT,
REINFORCING
RELOCATE
REPLACEMENT
RETAINING
REVISED
ROADWAY
ROAD-MIXED
RADIUS POINT,
REFERENCE POINT
RAILROAD
ROCK SLOPE PROTECTION
RIGHT
ROUTE
REDWOOD, RETAINING WALL
RIGHT-OF-WAY
RAILWAY
(<u> </u>
SOUTH, SUPPLEMENT
STRUCTURE APPROACH EMBANKMENT
SALVAGE
STRUCTURAL ALUMINUM PLATE PIPE
SOUTHBOUND
SAND CUSHION, SPIRAL CURVE POINT
SLOTTED CORRUGATED STEEL PIPE
STORM DRAIN
SECOND, SECTION
SEPARATION
SUBGRADE
SHOULDER
SHEET SIMILAR
JIVILAN

(S CONTINUED) SAN JOSE TO MERCED SAN JOAQUIN VALLEY STATION LINE SELECTED MATERIAL SPEC SPECIAL, SPECIFICATIONS SLOTTED PLASTIC PIPE STATE ROUTE STANDALONE RADIO SITE SLOPE STAKE, SUBSTATION SSBM STRAP AND SADDLE BRACKET METHOD STRUCTURAL SECTION DRAIN SSPA STRUCTURAL STEEL PLATE ARCH SSPP STRUCTURAL STEEL PLATE PIPE SSPPA STRUCTURAL STEEL PLATE PIPE ARCH SSRP STEEL SPIRAL RIB PIPE STREET, SPIRAL TANGENT POINT STATION STBB SINGLE THRIE BEAM BARRIER STANDARD STRUCTURE SURF SURFACING SIDEWALK, SOUND WALL SEWER SWITCHING STATION SYMMETRICAL SURFACE 4 SIDES SEMI-TANGENT TABLET TANGENT THRIE BEAM BARRIER TO BE DETERMINED TIMBER TOP OF CURB, TRAIN CONTROL TRAFFIC CONTROL BOX TEMPORARY CONSTRUCTION EASEMENT TELEPHONE TEMP TEMPORARY TOP OF GRADE TECHNICAL MEMORANDUM

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CALIFORNIA

HIGH-SPEED RAIL AUTHORITY

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VOLUM	-

W	WEST, WIDTH
WB	WESTBOUND
WCB	WORLD COORI
WH	WEEP HOLE
WM	WIRE MESH
WS	WATER SURF.
WSP	WELDED STE
WT	WEIGHT
W∨	WATER VALV
WW	WINGWALL
WWLOL	WINGWALL LA

CR	ROSS SECT
CR	ROSSING
CR	ROSSOVER
(
YE	AR

YEAR	
YEARS	5

		DESIGNED BY S. WELLS DRAWN BY W. JOHNSEN 15% DESIGN		
ICAL CURVE				
ORIDE,	SJD	SAN JOSE DIRIDON STATION		
GENCY	SIM	SIMILAR	TRK	TRACK
TEEL PIPE	SHT	SHEET	TRANS	TRANSITION
STATION	SHLD	SHOULDER	T/R	TOP OF RAIL
CH, PRESTRESSED,	SG	SUBGRADE	TPSS	TRACTION POWER SUBSTATION
ICATIONS AND ESTIMATES	SEP	SEPARATION	ТРМ	TREATED PERMEABLE MATERIAL
RSE VERTICAL CURVE	SEC	SECOND, SECTION	TPF	TRACTION POWER FACILITY
FORCING FABRIC	SD	STORM DRAIN	TPB	TREATED PERMEABLE BASE
RSE CURVE	SCSP	SLOTTED CORRUGATED STEEL PIPE	TP	TELEPHONE POLE
LASTIC PIPE	SC	SAND CUSHION, SPIRAL CURVE POINT	ТОТ	TOTAL

SUBMITTAL

NOT FOR

CONSTRUCTION

REV DATE BY CHK APP

(T CONTINUED)

SE, TRAFFIC SIGNAL, STEEL, TANGENT SPIRAL POINT

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CIFIC RAILROAD UNIVERSAL CROSSOVER

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JRVE LAY PIPE

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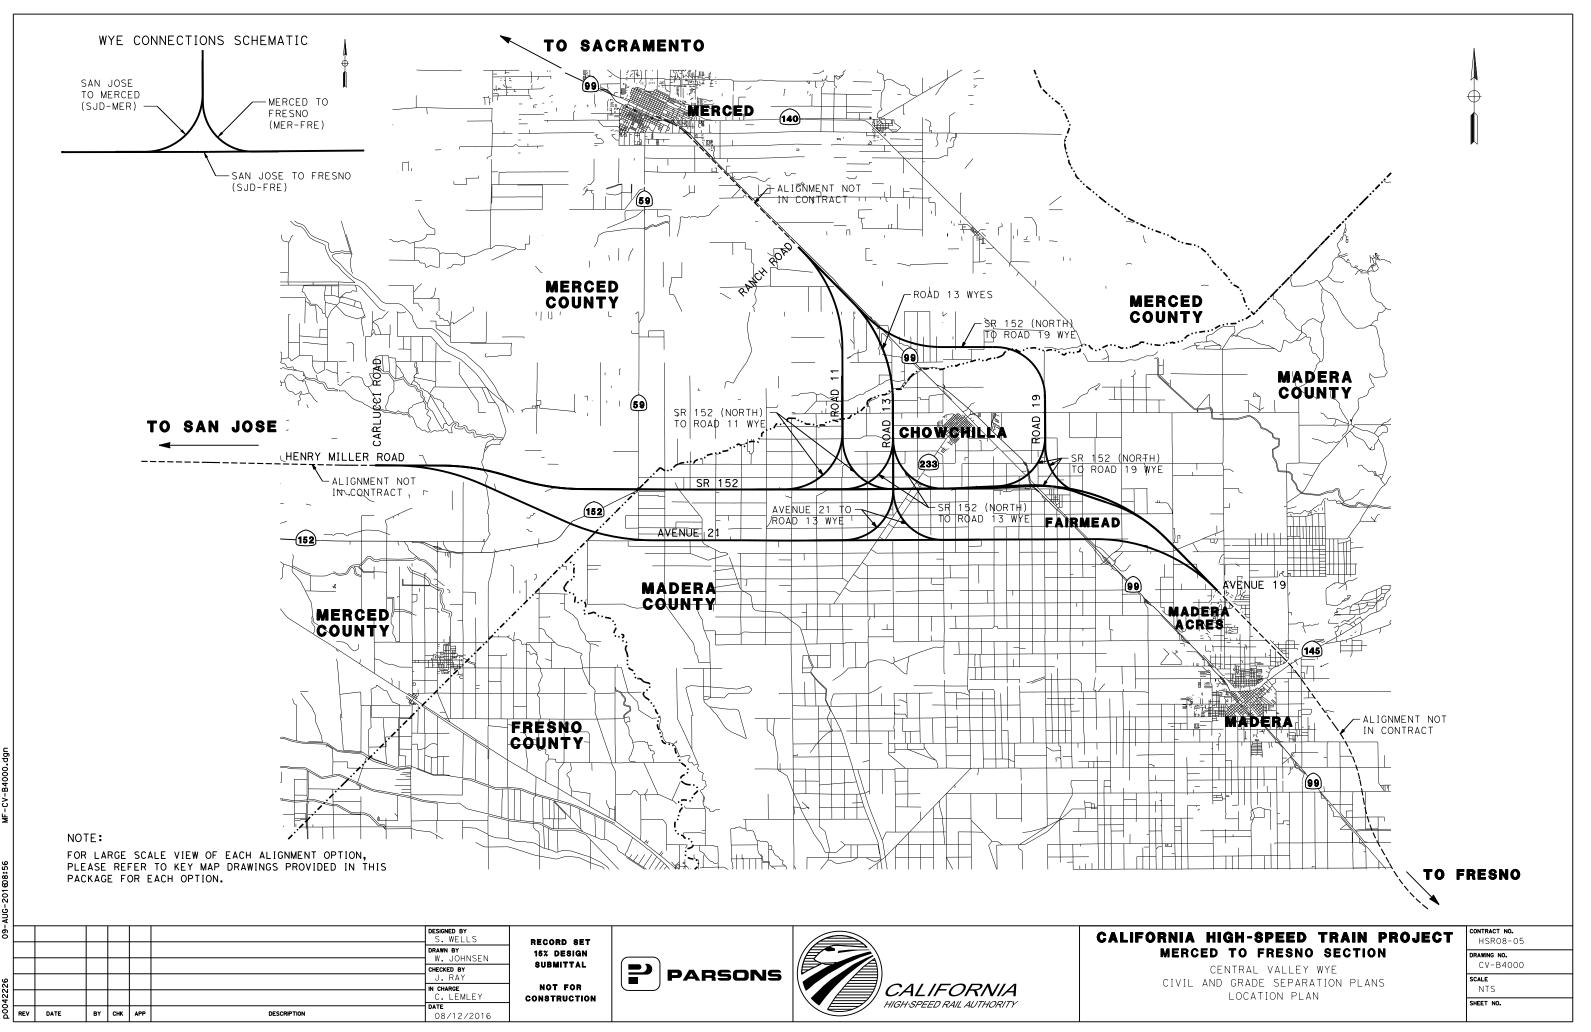
CALIFORNIA HIGH-SPEED TRAIN PROJECT MERCED TO FRESNO SECTION CENTRAL VALLEY WYE

CIVIL AND GRADE SEPARATION PLANS ABBREVIATIONS SHEET 2 OF 2

ONTRACT NO. HSR08-05 RAWING NO.

CV-B0021

NO SCALE



VUG-201608:56 MF-CV-B400

GENERAL NOTES:

201

- 1. DESIGN IS BASED ON THE FOLLOWING STANDARDS:
 - CALIFORNIA HIGH-SPEED RAIL AUTHORITY DIRECTIVE DRAWINGS FOR HIGH-SPEED RAIL PROJECT FACILITIES
 - CALTRANS HIGHWAY DESIGN MANUAL FOR STATE HIGHWAY FACILITIES LOCAL AGENCY STANDARDS FOR ALL OTHER FACILITIES
- 2. THE HORIZONTAL CONTROL DATUM IS NAD 83. ALL ELEVATIONS ARE BASED ON NAVD 88.
- 3. ALL MAJOR UTILITIES ARE SHOWN ON THE PLANS. PLEASE REFERENCE THE SECTION UTILITY REPORT FOR A DISCUSSION OF HIGH VS. LOW RISK AND MINOR UTILITIES.
- 4. RETAINING WALL TYPES ARE NOT SHOWN DUE TO CURRENT LACK OF GEOTECHNICAL BORINGS. TT CAN BE ASSUMED FOR COST PURPOSES THAT ALL FILL RETAINING WALLS ARE MSE AND THAT ALL CUT RETAINING WALLS ARE SOIL NAIL. PRELIMINARY RETAINING WALL TYPES WILL BE FINALIZED BASED ON SUBSEQUENT GEOTECHNICAL EXPLORATION.
- 5. MAJOR WATERCOURSES, IRRIGATION CANALS, AND BODIES OF WATER ARE SHOWN ON THE PLANS. FOR FURTHER INFORMATION REGARDING DRAINAGE DESIGN, PLEASE REFER TO THE FOLLOWING:
 - HYDROLOGY AND HYDRAULICS REPORT
 FLOODPLAIN IMPACTS ASSESSMENT REPORT

 - STORM WATER MANAGEMENT REPORT
 - STRUCTURE, VIADUCT AND TUNNEL PLANS (FOR FLOW DIRECTION)
- 6. WHERE PROPOSED ROADWAY R/W AND ROADWAY TCE LINES CROSS PERPENDICULAR TO EXISTING ROADWAY R/W LINES, IT IS ASSUMED THESE LINES SHOW A DEMARCATION OF CONSTRUCTION LIMITS. THEY ARE NOT INTENDED TO BE CONSTRUED AS A JURISDICTIONAL TRANSFER.
- 7. EMERGENCY VEHICLE ACCESS SHALL BE MAINTAINED AT ALL TIMES.
- 8. CUL-DE-SACS WERE DESIGNED BASED ON MERCED COUNTY STANDARD (ST-12).
- 9. METAL BEAM GUARD RAILING WAS DESIGNED PER CALTRANS STANDARD PLANS (A77) AND AASHTO ROADSIDE DESIGN GUIDE (TABLE 5-10).

20042226 09-/ 22		BY	СНК	APP	DESCRIPTION	DESIGNED BY S. WELLS DRAWN BY W. JOHNSEN CHECKED BY J. RAY IN CHARGE C. LEMLEY DATE OR (12/2016	RECORD SET 15% design Submittal Not for Construction	PARSONS	CALIFORNIA HIGH-SPEED RAIL AUTHORITY	CALIFO
C RE	V DATE	BY	СНК	APP	DESCRIPTION	08/12/2016				

RNIA HIGH-SPEED TRAIN PROJECT MERCED TO FRESNO SECTION CENTRAL VALLEY WYE


CIVIL AND GRADE SEPARATION PLANS GENERAL NOTES

NTRACT NO HSR08-05

RAWING NO.


CV-B0030

NO SCALE

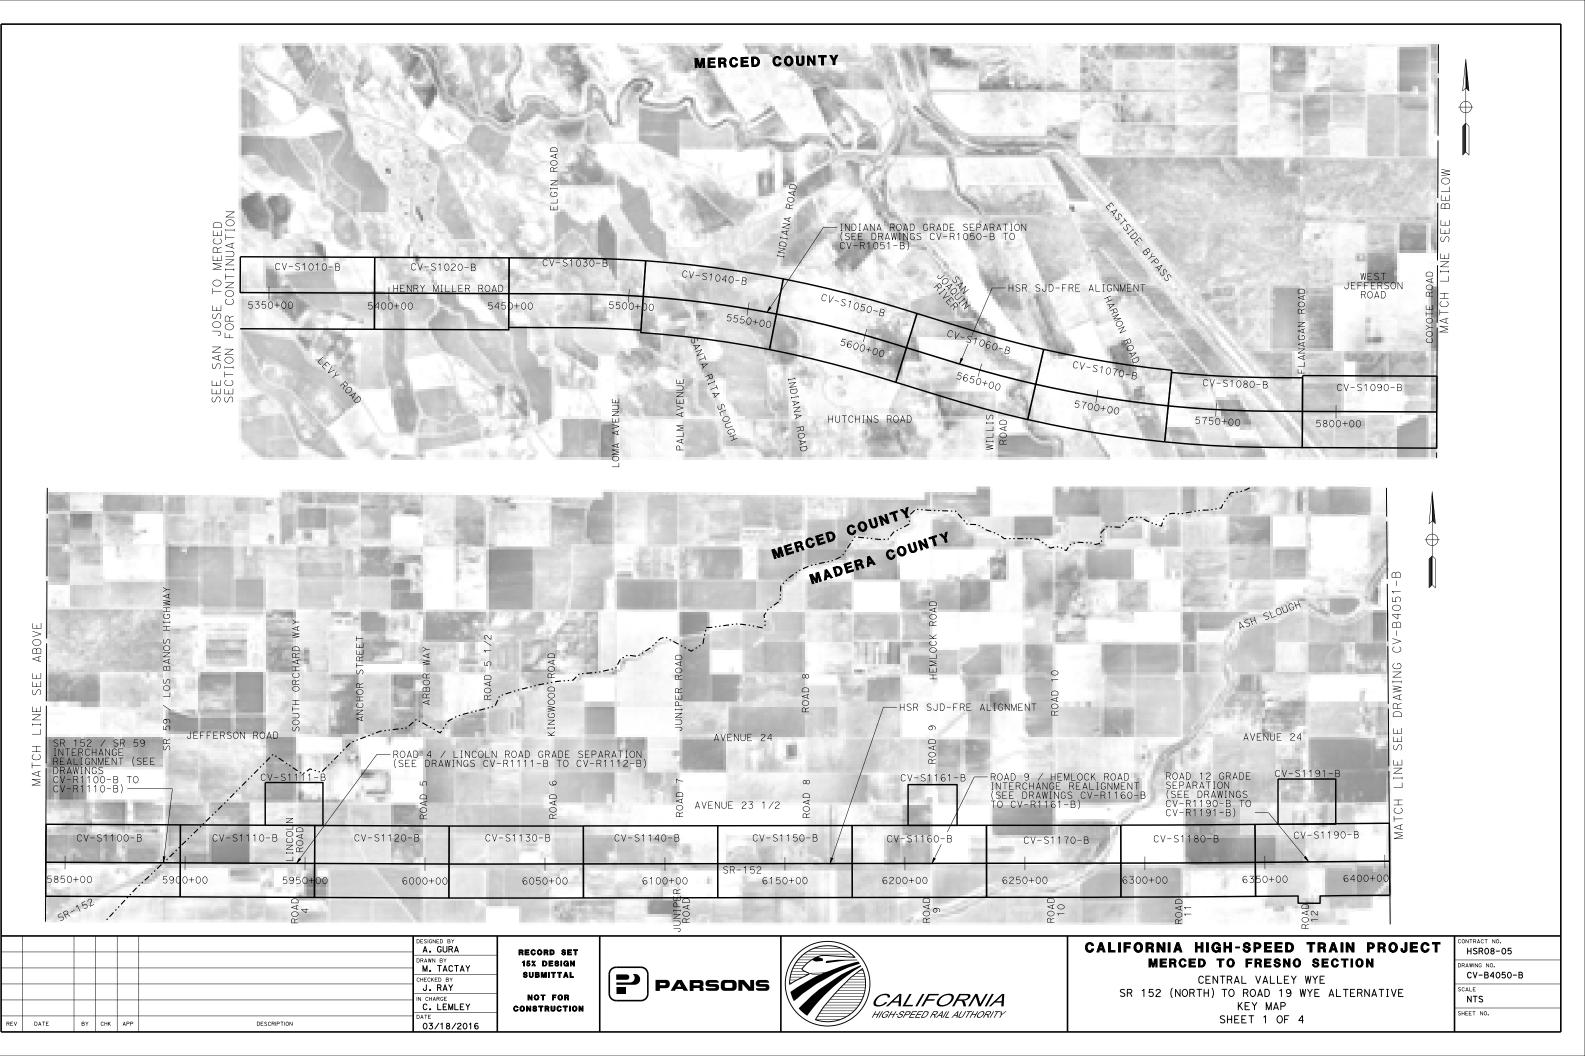


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ROAD 20 UNDERPASS (SEE DRAWINGS CV-R1260-B) S1270-B (V-R1261-B) S1270-B (V-R1261-B) S1270-B (V-R1261-B) S1270-B (V-R1260-B) S1270-B (V-R1280-B) S1270-B (V-R1280-B) S1270-B (V-R1280-B) S1270-B (V-R1280-B) S1270-B (V-R1280-B) S1270-B (V-R1280-B) S1270-B (V-R1280-B) S1270-B (V-R1280-B) S1270-B (V-R1280-B) S1270-B S1270-B (V-R1280-B) S1270-B (V-R12	CONTRACT NO. HSR08-05 DRAWING NO. CV-B4051-B SCALE NTS

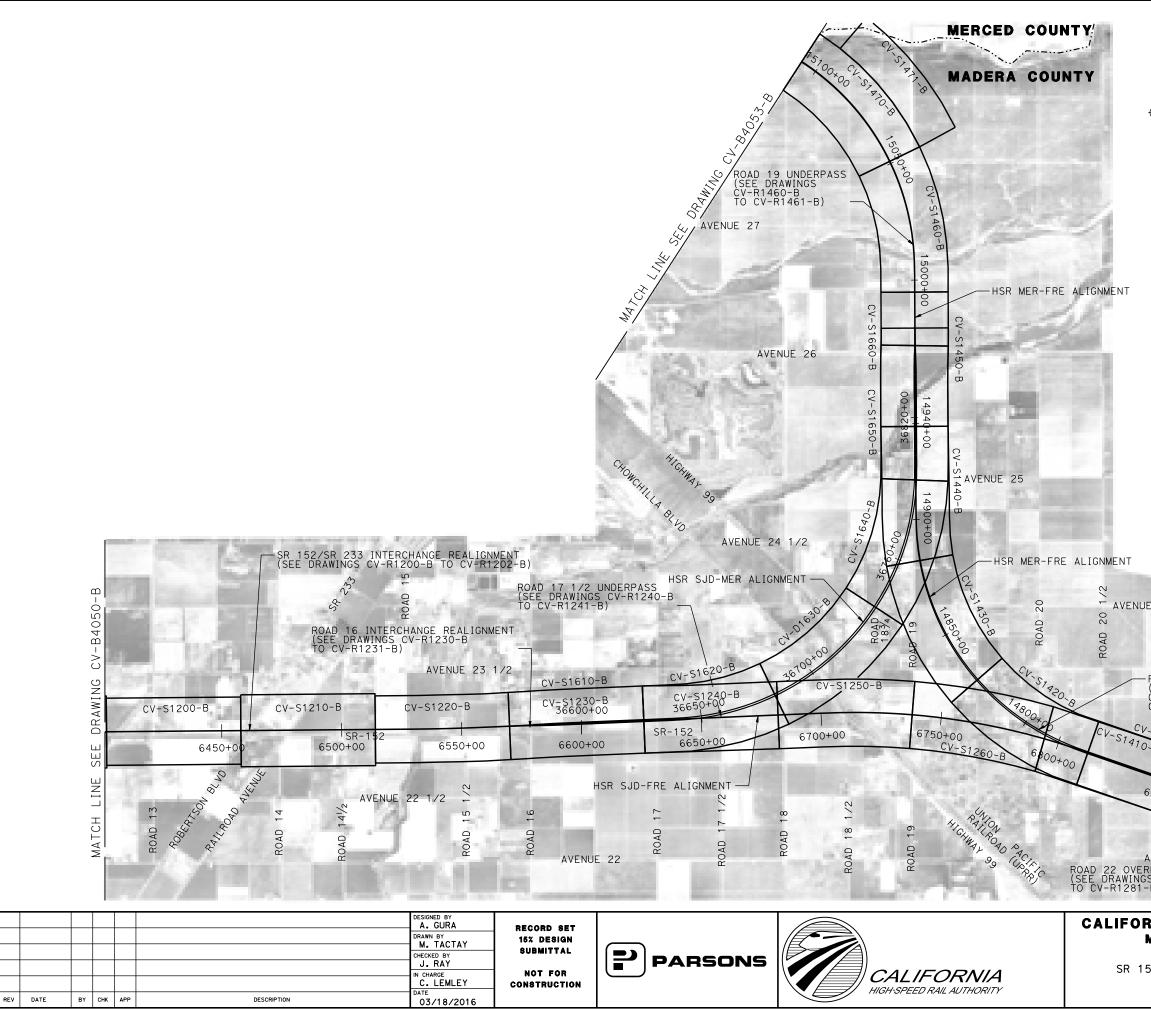


CALIFORNIA HIGH-SPEED TRAIN PROJECT MERCED TO FRESNO SECTION CENTRAL VALLEY WYE SR 152 (NORTH) TO

ONTRACT NO. HSR08-05

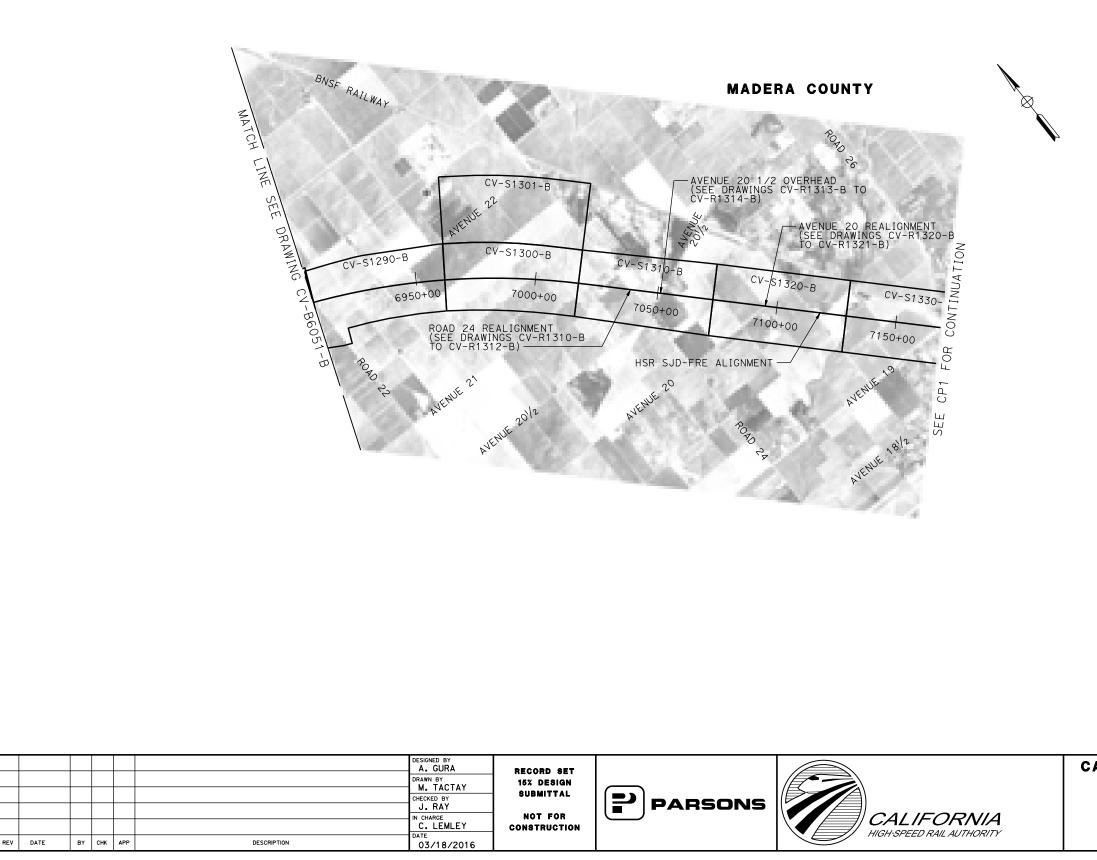DRAWING NO. CV-B4052-B
SCALE NTS
SHEET NO.

TO RO	AD	19	WYE	ALTERN
KEY	М	AP		
SHEET	3	OF	4	

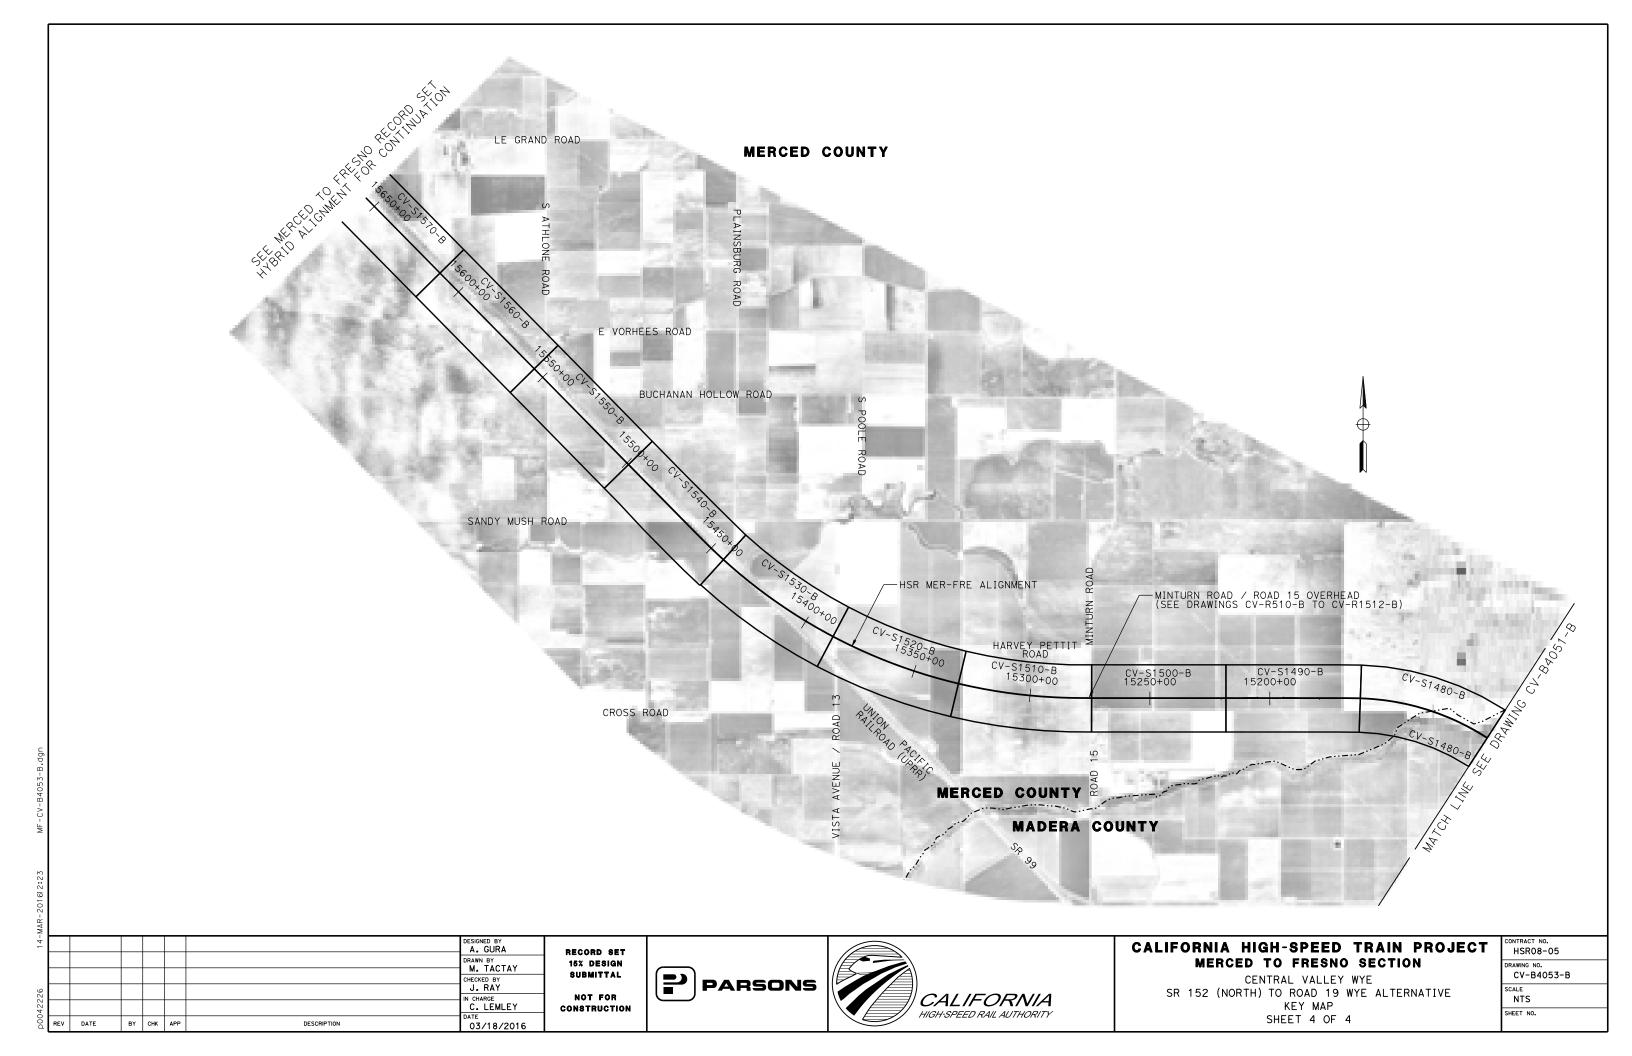

ROAD "ALIGNMENT NAME"	CURVE NO.		BC	PI	сс	EC	RADIUS (FT)	DELTA A	DEGREE OF CURVATURE (ARC)	LENGTH (FT)	TANGE (FT)
		STATION	45+25.89	51+56.52		57+85.49	10,000.00	7°13′01''	0° 34′23''	1,259.60	630.6
	030-01	NORTHING	1858106.10	1858106.10	1848106.10	1858026.88		RIGHT			
HENRY MILLER ROAD		EASTING	6525127.39	6525758.03	6525127.39	6526383.67					
"HENRY MILLER RD"		STATION	107+69.71	111+45.55		115+04.08	1,400.00	30°03′16"	4°05′33''	734.37	375.
	030-02	NORTHING	1857400.72	1857353.51	1858789.63	1857499.38		LEFT			
		EASTING	6531328.40	6531701.26	6531504.28	6532047.64					
		STATION	24+12.02	36+20.81		46+85.09	2,700.00	48°14′09''	2°07′19''	2,273.07	1,208
	050-01	NORTHING	1855871.61	1857038.63	1856575.18	1858050.89		LEFT			
INDIANA ROAD		EASTING	6532459.79	6532774.78	6529853.07	6532114.10					
"INDIANA RD"		STATION	50+03.45	58+17.71		65+50.00	2,000.00	44°18′20''	2° 51 ′53''	1,546.55	814.
	050-02	NORTHING	1858317.49	1858999.37	1859410.61	1859798.19		RIGHT			
		EASTING	6531940.10	6531495.06	6533614.94	6531652.85					
		STATION	13+00.00	18+01.57		20+86.97	500.00	90°10′48''	1 1° 27′33''	786.97	501.
COYOTE ROAD "COYOTE RD"	090-01	NORTHING	1852469.88	1852971.46	1852469.88	1852969.88		RIGHT			
		EASTING	6558672.51	6558672.51	6559172.51	6559174.08					
		STATION	12+03.86	14+20.96		16+37.98	9,700.00	2° 33′51.22″	0°35′26.44″	434.12	217,
	100-01	NORTHING	1850801.75	1850900.75	1842169.09	1850991.01		LEFT			
SR 152 REALIGNMENT AT SR 59 "SR 152/SR 59"		EASTING	6559575.36	6559768.57	6563998.84	6559966.01					
		STATION	22+10.04	53+19.69		83+68.55	17,999.00	19°36′15.24″	0°19′05.98″	6,158.51	3,109
	100-02	NORTHING	1851228.85	1852521.70	1834859.18	1852790.71		RIGHT			
		EASTING	6560486.29	6563314.44	6567969.48	6566412.44					
	100-03	STATION	93+42.18	97+71.35		101+99.97	9,700.00	5°04′00.52″	0°35′26.44″	857.80	429.
		NORTHING	1852874.94	1852912.06	1843211.30	1852911.28		RIGHT			
		EASTING	6567382.41	6567809.98	6568221.53	6568239.16					
		STATION	26+96.94	28+32.35		29+67.75	17,921.00	0°51′56.88″	0°19′10.97″	270.81	135.
	101-01	NORTHING	1851353.47	1851395.65	1834323.78	1851435.87		LEFT			
		EASTING	6560962.29	6561090.96	6566543.68	6561220.25					
		STATION	33+03.48	36+84.30		40+61.06	3,000.00	14°28′07.46″	1°54′35.49″	757.58	380.
	101-02	NORTHING	1851535.60	1851648.72	1848671.01	1851667.40		RIGHT			
SR 152 / SR 59 EB OFF RAMP		EASTING	6561540.84	6561904.46	6562431.98	6562284.82					
"EB OFF RAMP"		STATION	46+06.33	58+06.44		64+91.40	1,200.00	90°00′19.45″	4°46′28.73″	1,885.07	1,200
	101-03	NORTHING	1851694.15	1851753.02	1852892.70	1852951.68		LEFT			
		EASTING	6562829.43	6564028.10	6562770.57	6563969.12					
		STATION	78+16.20	78+94.50		79+72.76	3,000.00	2°59′24.27″	1°54′35.49″	156.56	78.
	101-04	NORTHING	1854274.88	1854353.09	1854422.33	1854431.38		RIGHT			
		EASTING	6563904.01	6563900.16	6566900.38	6563900.39					
		STATION	37+27.22	38+77.64		40+27.63	18,077.00	0°57′03.14″	0°19′01.03″	300.00	150
	102-01	NORTHING	1851874.32	1851927.78	1834984.69	1851978.92		LEFT			
		EASTING	6561865.11	6562005.26	6568308.60	6562146.28					
		STATION	40+27.63	41+11.19		41+94.72	3,594.62	2°39′47.43″	1°35′38.16″	167.08	83.
SR 59 / SR 152 WB ON RAMP "WB ON RAMP"	102-02	NORTHING	1851978.92	1852007.40	1855358.23	1852039.51		LEFT			
		EASTING	6562146.28	6562224.84	6560920.91	6562301.98					
		STATION	49+38.86	57+28.63		63+59.29	1,305.00	62°21′49.18"	4°23′25.73″	1,420.43	789.
	102-03	NORTHING	1852325.41	1852628.85	1853530.25	1853415.56		LEFT			
		EASTING	6562989.01	6563718.16	6562487.62	6563787.57					1

MF - CV - B0060-B

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p005133a 02-N	REV	DATE	BY	Снк арр	DESCRIPTION	DESIGNED BY A. GURA DRAWN BY M. TACTAY CHECKED BY J. RAY IN CHARGE C. LEMLEY DATE 10/30/2015	RECORD SET 15% design Submittal Not for Construction	PARSONS	CALIFORNIA HIGH-SPEED RAIL AUTHORITY	CALIFORNI ME SR 152
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NIA HIGH-SPEED TRAIN PROJECT IERCED TO FRESNO SECTION

CENTRAL VALLEY WYE (NORTH) TO ROAD 19 WYE ALTERNATIVE GEOMETRY DATA TABLE SHEET 1 OF 6 HSR08-05

DRAWING NO. CV-B0060-B

NO SCALE

ROAD "ALIGNMENT NAME"	CURVE NO.		BC	ΡI	сс	EC	RADIUS (FT)	DELTA A	DEGREE OF CURVATURE (ARC)	LENGTH (FT)	TANGENT (FT)
		STATION	52+03.54	53+67.46		55+31.05	3,000.00	6°15′17.78''	1° 54′35.49''	327.51	163.92
	103-01	NORTHING	LEFT	1853812.60	1854183.46	1853651.29		LEFT			
		EASTING	6563936.73	6563948.06	6566929.56	6563977.13					
		STATION	55+31.05	63+97.93		69+59.47	1,000.00	81°50′33.51″	5°43′46.48″	1,428.42	866.88
WB SR 152 TO NB SR 59 RAMP "WB OFF RAMP"	103-02	NORTHING	1853651.29	1852798.16	1853828.68	1852829.33		LEFT			
		EASTING	6563977.13	6564130.91	6564961.27	6564997.23					
		STATION	77+47.81	80+63.60		83+79.32	18,077.00	2°00′05.77"	0°19′01.03''	631.51	315.79
	103-03	NORTHING	1852857.67	1852869.02	1834792.36	1852869.35		RIGHT			
		EASTING	6565785.06	6566100.64	6566435.00	6566416.43					
		STATION	45+66.64			50+57.29	150.00	187°24′58.88"	38°11′49.87''	490.65	0.00
	104-01	NORTHING	1851816.07		1851950.65	1852092.65		RIGHT			
		EASTING	6563300.54		6563234.29	6563185.97					
		STATION	53+88.24	54+71.80		55+55.31	2,570.00	3°43′28.19″	2°13′45.87″	167.06	83.56
SB SR-59 TO EB SR 152 LOOP ON RAMP "EB LOOP RAMP"	104-02	NORTHING	1852199.27	1852226.18	1849766.26	1852247.91		RIGHT			
		EASTING	6563499.28	6563578.38	6564327.17	6563659.07					
		STATION	55+55.31	57+05.36		58+55.41	17,921.00	0°57′34.14″	0°19′10.97''	300.11	150.06
	104-03	NORTHING	1852247.91	1852286.91	1834943.04	1852323.49		RIGHT			
		EASTING	6563659.07	6563803.97	6568317.82	6563949.50					
		STATION	14+30.85	18+97.60		23+61.75	5,100.00	10°27′29.06"	1°07′24.41″	930.89	466.74
	160-01	NORTHING	1852856.89	1852856.05	1847756.90	1852770.49		RIGHT			
		EASTING	6592662.51	6593129.26	6592653.25	6593588.09					
		STATION	31+86.42	36+65.87		41+42.52	5,100.00	10°44′28.52″	1° 07′24.41″	956.10	479.45
	160-02	NORTHING	1852619.33	1852531.44	1857632.91	1852532.94		LEFT			
SR 152 REALIGNMENT AT ROAD 9 "SR 152 / RD 9"		EASTING	6594398.79	6594870.12	6595333.63	6595349.57					
		STATION	52+03.02	56+66.40		61+27.24	5,100.00	10°22′59.34″	1° 07′24.41″	924.22	463.38
	160-03	NORTHING	1852536.25	1852537.70	1857636.23	1852622.64		LEFT			
		EASTING	6596410.07	6596873.45	6596394.13	6597328.98					
		STATION	69+37.21	74+00.59		78+61.43	5,100.00	10°22′59.34″	1°07'24.41''	924.22	463.38
	160-04	NORTHING	1852771.11	1852856.05	1847757.52	1852857.50		RIGHT			
		EASTING	6598125.22		6599060.06	6599044.13					
		STATION	25+62.64	28+26.67		30+89.34	3,000.00	10°03′32.93"	1° 54′35.49''	526.70	264.03
	161-01	NORTHING	1852632.87	1852562.61	1849741.01	1852448.99		LEFT			
ROAD 9/SR 152 EB OFF RAMP "EB OFF RAMP"		EASTING	6593767.20		6592968.96	6594260.03					
		STATION	38+53.84	41+86.88		45+09.29	1,500.00	25°02′11.73″	3°49′10.99"	655.46	333.04
	161-02	NORTHING	1852119.98		1853473.97	1851974.01		LEFT			
		EASTING	6594950.11	6595250.74	6595595.65	6595583.77	1 500 00		78.40/40.00		700.00
	1.00.01	STATION	46+58.21	49+60.83	1057404 44	52+55.44	1,500.00	22°48′44.95''	3°49′10.99"	597.23	302.62
	162-01	NORTHING	1851984.11	1851984.11	1853484.11	1852101.44		LEFT			
ROAD 9/SR 152 EB ON RAMP "EB ON RAMP"		EASTING	6595983.41	6596286.03	6595983.41	6596564.98	7 000 00	11900/15 00"		501 40	201.62
	162-02	STATION NORTHING	62+99.90 1852506.39	65+91.52 1852619.46	1849741.06	68+81.32 1852678.64	3,000.00	11°06′15.69" RIGHT	1°54′35.49''	581.42	291.62
	162-02	EASTING	6597527.74		6598690.89	6598082.11		RIGHI			
		STATION	35+12.64	35+84.78	0090090.09	36+25.88	72.00	90°06′45.82″	79° 34′ 38,90''	117 04	72.14
	163-01	NORTHING	1852074.00		1852074.43	1852002.43	72.00	90 06 43.82 LEFT	79 54 56.90	113.24	(∠.14
	163-01	EASTING	6595855.99		6595783.99	6595783.42					
		STATION	37+87.02	66+21.04	0595765.99	43+87.16	200.00	171°55′35.46"	28° 38′52.40''	600.14	2,834.02
ROAD 9/SR 152 EB LOOP ON RAMP "EB LOOP RAMP"	163-02	NORTHING	1852003.71	1852026.15	1852203.70	1852401.94	200.00	RIGHT	20 30 32.40	000.14	2,034.02
	103-02	EASTING	6595622.28	6592788.35	6595623.86	6595597.34		NIGHT			
		STATION	45+73.35	47+38.32	0393023.00	49+02.96	3,000.00	6°17′42.07''	1° 54′35.49″	329.61	164.97
	163-03	NORTHING	1852426.63	1852448.50	1849453.12	1852452.32	3,000.00	RIGHT		523.01	104.31
	105 05	EASTING	6595781.89		6596179.69	6596110.33		1110111			
			0353701.05	0000010.11	0550175.05	0330110.33					
		A. GURA	RECORD SET						CALIFORNIA HIGH-SPEEI		ROJECT HSI
		RAWN BY M. TACTAY	15% DESIGN		/ <i>/</i> /				MERCED TO FRESH		
		HECKED BY	SUBMITTAL	PAR	sons 🛙				CENTRAL VALLE		
	11	CHARGE	NOT FOR Construction				4 <i>LIFOR</i> Λ	//A	SR 152 (NORTH) TO ROAD 19 GEOMETRY DATA		NO
			CONSTRUCTION			V 🗐 HIGH	I-SPEED RAIL AUTHC	DRITY	SHEET 2 OF		SHEET

ROAD "ALIGNMENT NAME"	CURVE NO.		BC	ΡI	СС	EC	RADIUS (FT)	DELTA A	DEGREE OF CURVATURE (ARC)	LENGTH (FT)	TANGEN (FT)
		STATION	29+35.25	34+55.35		39+65.22	3,000.00	19°40′15''	1° 54′35''	1,029.97	520.10
	164-01	NORTHING	1852746.97	1852661.88	1855706.55	1852754.47		LEFT			
ROAD 9/SR 152 WB ON RAMP		EASTING	6594167.03	6594680.13	6594657.86	6595191.92					
"WB ON RAMP"		STATION	42+15.63	43+50.22		44+84.09	1,500.00	10°15′16''	3°49′11''	268.46	134.5
	164-02	NORTHING	1852799.04	1852823.00	1851323.00	1852823.00		RIGHT			
		EASTING	6595438.33	6595570.77	6595705.36	6595705.36					
		STATION	64+97.60	65+49.41		66+01.18	1,500.00	3° 57′24''	3°49′11''	103.59	51.8
	165-01	NORTHING	1852835.00	1852835.00	1854335.00	1852838.58		LEFT			
ROAD 9/SR 152 WB OFF RAMP		EASTING	6597675.09	6597726.91	6597675.09	6597778.60					
"WB OFF RAMP"		STATION	68+52.53	70+08.53		71+64.43	5,177.00	3°27′07''	1° 06′24''	311.91	156.0
	165-02	NORTHING	1852855.92	1852866.69	1847691.26	1852868.06		RIGHT			
		EASTING	6598029.34	6598184.97	6598386.57	6598340.97					
		STATION	102+81.31	106+94.07		111+05.02	5,088.50	9°16′29.19"	1°07′33.55″	823.70	412.
SR 152 REALIGNMENT AT SR 233	200-01	NORTHING	1852936.63	1852938.67	1847848.20	1852874.15		RIGHT			
	-	EASTING	6617571.49	6617984.24	6617596.55	6618391.92					
		STATION	120+30.32	124+39.39		128+46.71	5,100.00	9°10′18.20″	1°07′24.41″	816.39	409.0
	200-02	NORTHING	1852729.52	1852665.58	1857766.83	1852666.85		LEFT			
		EASTING	6619305.85	6619709.89	6620103.02	6620118.96					
"SR 152 / SR 233"		STATION	139+46.65	143+98.52		148+48.04	5,100.00	10°07′35.70″	1°07′24.41″	901.39	451.
	200-03	NORTHING	1852670.29	1852671.70	1857770.27	1852752.54		LEFT			
		EASTING	6621218.89	6621670.76	6621202.96	6622115.34					
	200-04	STATION	155+40.07	159+48.84		163+55.87	5,088.50	9°11′08.76″	1°07′33.55″	815.80	408.
		NORTHING	1852876.35	1852949.48	1847869.94	1852957.47		RIGHT			
		EASTING	6622796.21	6623198.39	6623706.54	6623607.09					
		STATION	13+02.73	15+74.24		18+42.45	2,000.00	15°27′43.13″	2°51′53.24″	539.72	271.
SR 233/SR 152 EB OFF RAMP "EB OFF RAMP"	201-01	NORTHING	1852725.08	1852655.69	1850791.51	1852518.82		RIGHT			
EB OFF RAMP		EASTING	6618732.18	6618994.67	6618221.00	6619229.16					
		STATION	10+00.00	10+86.90		11+39.78	93.00	86°06′50.38″	61°36′30.11″	139.78	86.9
	202-01	NORTHING	1852116.15	1852044.25	1852168.37	1852088.05		RIGHT			
	-	EASTING	6620190.24	6620141.45	6620113.28	6620066.40					
		STATION	13+02.25	19+40.71		18+09.14	200.00	145°12′47.90″	28°38′52.40″	506.89	638.4
SR 233/SR 152 EB LOOP ON RAMP "EB LOOP RAMP"	202-02	NORTHING	1852169.95	1852491.79	1852342.68	1852542.06		RIGHT			
EB LOOF RAMP	-	EASTING	6619926.08	6619374.67	6620026.90	6620011.15					
		STATION	22+51.67	23+35.24		24+18.76	3,000.00	3°11′28.67″	1°54′35.49″	167.10	83.5
	202-03	NORTHING	1852576.90	1852583.48	1849586.22	1852585.42		RIGHT			
		EASTING	6620452.30	6620535.61	6620688.52	6620619.16					
		STATION	16+72.81	22+15.00		27+45.61	3,000.00	20°29′20''	1° 54′35''	1,072.80	542.
	203-01	NORTHING	1852867.39	1852793.36	1855839.30	1852912.03		LEFT			
SR 233/SR 152 WB ON RAMP		EASTING	6618965.65	6619502.76	6619375.23	6620031.81					
"WB ON RAMP"		STATION	31+35.85	32+43.86		33+45.37	350.00	34°17′55''	16°22′13"	209.52	108.0
	203-02	NORTHING	1852997.44	1853021.07	1852655.92	1852981.22	• • • •	RIGHT			
		EASTING	6620412.59	6620517.98	6620489.19	6620618.36					

V DATE	BY CH	К АРР	DESCRIPTION	DESIGNED BY A. GURA DRAWN BY M. TACTAY CHECKED BY J. RAY IN CHARGE C. LEMLEY DATE 10/30/2015	RECORD SET 15% DESIGN Submittal Not for Construction	PARSONS	CALIFORNIA HIGH-SPEED RAIL AUTHORITY	CALIFORI M SR 152
	V DATE	V DATE BY CH	V DATE BY CHK APP	Image: Constraint of the system Image: Constand of the system Image: Constand	A. GURA DRAWN BY M. TACTAY CHECKED BY J. RAY IN CHARGE C. LEMLEY DATE	A. GURA RECORD SET DRAWN BY M. TACTAY DRAWN BY M. TACTAY CHECKED BY J. RAY IN CHARGE C. LEMLEY DATE DATE	A. GURA Record set DRAWN BY M. TACTAY M. TACTAY SUBMITTAL J. RAY NOT FOR Image: Construction DATE	A. GURA DRAWN BY DRAWN BY M. TACTAY CHECKED BY J. RAY IN CHARGE C. LEMLEY DATE

NIA HIGH-SPEED TRAIN PROJECT Merced to fresno section

CENTRAL VALLEY WYE 52 (NORTH) TO ROAD 19 WYE ALTERNATIVE GEOMETRY DATA TABLE SHEET 3 OF 6 HSR08-05

DRAWING NO. CV-B0062-B

NO SCALE

ROAD "alignment name"	CURVE NO.		BC	PI	СС	EC	RADIUS (FT)	DELTA A	DEGREE OF CURVATURE (ARC)	LENGTH (FT)	TANG (F
		STATION	12+18.03	15+67.22		18+50.52	600.00	60°23′53.55″	9° 32′57.47″	632.49	349
	210-01	NORTHING	1851893.73	1851717.71	1852411.92	1851892.98		LEFT			
SR 233/SR 152 EB ON RAMP		EASTING	6620323.95	6620625.53	6620626.40	6620927.55					
"EB ON RAMP"		STATION	29+50.66	34+43.98		39+28.54	3,000.00	18°40′34.42″	1° 54′35.49''	977.88	493
	210-02	NORTHING	1852445.17	1852692.78	1849850.44	1852790.72		RIGHT			
		EASTING	6621879.08	6622305.75	6623384.86	6622789.25					
		STATION	37+30.21	38+77.53		40+19.14	600.00	27° 35′29''	9° 32′57''	288.94	147
	211-01	NORTHING	1852847.48	1852793.11	1853405.13	1852808.35		LEFT			
SR 233/SR 152 WB OFF RAMP		EASTING	6620987.67	6621124.60	6621209.10	6621271.14					
"WB OFF RAMP"		STATION	52+23.14	54+44.03		56+64.66	5,177.00	4° 53′11''	1° 06′24''	441.52	220
	211-02	NORTHING	1852932.83	1852955.67	1847783.58	1852959.71		RIGHT			
		EASTING	6622468.68	6622688.39	6623003.95	6622909.25					
		STATION	13+44.20	14+13.01		14+78.49	250.00	30°46′36.50"	22°55′05.92''	134.29	68.
	212-01	NORTHING	1854386.24	1854347.54	1854179.52	1854285.18		RIGHT			
CATES COURT		EASTING	6622168.17	6622225.07	6622027.58	6622254.15					
"CATES CT"		STATION	15+34.15	16+02.94		16+68.41	250.00	30°46′14.25″	22°55′05.92"	134.26	68.
	212-02	NORTHING	1854234.74	1854172.40	1854340.41	1854133.70		LEFT			
		EASTING	6622277.68	6622306.75	6622504.25	6622363.63					
		STATION	14+25.89	19+02.52		23+76.40	5,100.00	10°40′42.20″	1°07′24.41″	950.50	476
	220-01	NORTHING	1853031.56	1853042.05	1847932.80	1852964.06		LEFT			
		EASTING	6629753.42	6630229.94	6629865.63	6630700.14					
		STATION	28+57.10	33+02.66		37+45.96	5,100.00	9° 59′09.18''	1°07′24.41″	888.86	445
	220-02	NORTHING	1852885.40	1852812.49	1857916.66	1852816.91		LEFT			1.10
SR 152 REALIGNMENT AT ROAD 16		EASTING	6631174.37	6631613.92	6632008.89	6632059.46					
"SR 152 / RD 16"		STATION	48+64.72	53+03.74		57+40.60	5,100.00	9°50′24.30''	1°07′24.41″	875.88	439
	220-03	NORTHING	1852828.00	1852832.36	1857927.75	1852911.67	0,100100	LEFT		010100	100
	220 00	EASTING	6633178.16	6633617.16	6633127.59	6634048.96					
		STATION	63+83.13	68+31.57	0000121100	72+77.70	5,100.00	10°03′00.07"	1°07′24.41″	894.57	448
	220-04	NORTHING	1853027.75	1853108.76	1848011.67	1853111.57		RIGHT		001101	
		EASTING	6634680.92	6635121.98	6635602.29	6635570.40					
		STATION	16+67.72	23+35.36	0033002.23	29+95.16	5,000.00	15°12′40.64″	1° 08′45,30″	1,327.44	667
	221-01	NORTHING	1852981.15	1852877.22	1848042.10	1852603.89	3,000.00	LEFT	1 00 13.30	19021811	001
	221 01	EASTING	6629993.95	6630653.46	6629215.62	6631262.59					
ROAD 16/SR 152 EB OFF RAMP "EB OFF RAMP"		STATION	34+96.52	38+17.64	0023213.02	41+29.21	1,500.00	24°10′00.28''	3°49′10.99″	632.68	321
	221-02	NORTHING	1852398.63	1852267.17	1853767.17	1852267.17	1,300.00	LEFT	5 -5 -0.55	032.00	521
	221 02	EASTING	6631720.02	6632012.99	6632334.11	6632334.11					
		STATION	19+63.41	21+13.74	0002004.11	22+63.98	5,024.00	3° 25′40''	1° 08′26''	300.57	150
	222-01	NORTHING	1853068.53	1853065.87	1848045.32	1853054.22	3,024:00	RIGHT	10020	500.51	1.50
	222 01	EASTING	6630294.90	6630445.21	6630205.95	6630595.08		NIGHT			
ROAD 16/SR 152 WB ON RAMP "WB ON RAMP"		STATION	25+90.18	29+78.04	0030203.33	33+65.52	10,000.00	4° 26′32''	0° 34′23''	775.33	387
	222-02	NORTHING	1853028.96	1852998.91	1862998.91	1852998.91	10,000.00	LEFT	0 54 25		100
		EASTING	6630920.31	6631307.00	6631694.86	6631694.86					
		STATION	43+83.24	46+71.67	0031094.00	49+49.35	1,200.00	27°01′47.16″	4°46′28.73''	566.11	288
	230-01	NORTHING	1852279.17	1852279.17	1853479.17	49+49.35	1,200.00	LEFT	4020.13	11.000	208
	230-01	EASTING									
ROAD 16/SR 152 EB ON RAMP "EB ON RAMP"		STATION	6632824.23 55+18.08	6633112.66 59+25.72	6632824.23	6633369.58 63+28.39	3 000 00	15°28′32.72"	1° 54′35,49″	910 71	407
	270.00				1940000 70		3,000.00		1 54 35.49	810.31	407
	230-02	NORTHING	1852668.70	1852853.95	1849996.39	1852935.60		RIGHT			

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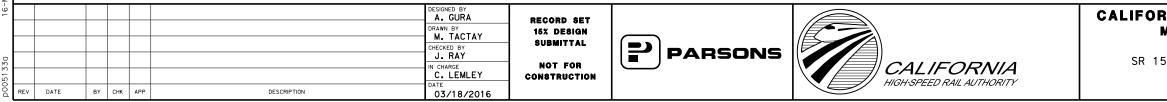
CALIFORNIA HIGH-SPEED TRAIN PROJECT Merced to Fresno Section

CENTRAL VALLEY WYE SR 152 (NORTH) TO ROAD 19 WYE ALTERNATIVE GEOMETRY DATA TABLE SHEET 4 OF 6 CONTRACT NO. HSR08-05 DRAWING NO.

CV-B0063-B

NO SCALE

ROAD "ALIGNMENT NAME"	CURVE NO.		BC	ΡI	СС	EC	RADIUS (FT)	DELTA A	DEGREE OF CURVATURE (ARC)	LENGTH (FT)	TANGE (FT)
		STATION	31+70.24	32+40.24		32+80.20	70.00	90°00′00.00''	81°51′04.01″	109.96	70.00
ROAD "ALIGNMENT NAME" "ALIGNMENT NAME" OAD 16/SR 152 EB LOOP ON RAMP "EB LOOP RAMP" ROAD 16/SR 152 WB OFF RAMP "WB OFF RAMP" ROAD 17 1/2 "RD 17 1/2" FAIRMEAD BLVD REALIGNMENT "FAIR BLVD" LINE ROAD 24 REALIGNMENT "RD 24" AVENUE 20 1/2 "AVE 20 1/2"	231-01	NORTHING	1852367.17	1852297.17	1852367.17	1852297.17		LEFT			
		EASTING	6632596.67	6632596.67	6632526.67	6632526.67					
		STATION	34+31.05	73+31.13		40+38.88	200.00	174°07′43.56″	28°38′52.40″	607.82	3,900.
	231-02	NORTHING	1852297.17	1852297.17	1852497.17	1852696.12		RIGHT			
		EASTING	6632375.81	6628475.74	6632375.81	6632355.35					
		STATION	43+46.98	44+55.87		45+64.66	3,000.00	4°09′26.29″	1°54′35.49″	217.68	108.
	231-03	NORTHING	1852727.64	1852738.77	1849743.37	1852742.03		RIGHT			
		EASTING	6632661.85	6632770.16	6632968.73	6632879.00					
		STATION	49+57.47	53+00.61		56+43.20	7,000.00	5°36′46.15″	0°49′06.64″	685.74	343.
	232-01	NORTHING	1853010.91	1853010.91	1860010.91	1853044.48		LEFT			
ROAD 16/SR 152 WB OFF RAMP		EASTING	6633247.64	6633590.78	6633247.64	6633932.28					
		STATION	61+34.77	63+33.48		65+32.00	5,177.00	4°23′46.86″	1°06′24.25″	397.24	198.
	232-02	NORTHING	1853092.55	1853111.99	1847940.37	1853116.21		RIGHT			
		EASTING	6634421.48	6634619.25	6634927.82	6634817.92					
		STATION	36+18,95	53+21.46		52+71.94	700.00	135°17′56.82"	8°11′06.40″	1,652.99	1,702
	240-01	NORTHING	1852923.78	1851221.29	1852920.12	1852425.15		LEFT			,
ROAD 17 1/2		EASTING	6640582.20	6640573.31	6641282.19	6641777.16					
		STATION	58+73.58	61+60.97		64+18.98	700.00	44° 38′ 30. 37''	8°11′06.40″	545.40	287.
	240-02	NORTHING	1852850.57	1853053.78	1852355.59	1853055.58		RIGHT			
		EASTING	6642202.58	6642405.80	6642697.56	6642693.18					
		STATION	12+00.00	13+22.86		14+45.59	3,000.00	4° 41 ′26''	1° 54′35''	245,59	122.
	250-01	NORTHING	1854489.53	1854402.12	1856597.89	1854322.07	,	LEFT			
		EASTING	6645883.36	6645969.71	6648017.56	6646062.92					
		STATION	16+48.79	18+94.19		21+38.49	3,000.00	9°21′10''	1° 54′35''	489.71	245.
	250-02	NORTHING	1854189.68	1851913.85	1856597.89	1853841.77	,	RIGHT			
FAIR BLVD LINE		EASTING	6646217.06	6644262.42	6648017.56	6646560.92					
		STATION	23+45.89	24+68.01		25+90.00	3,000.00	4° 39′44''	1° 54′35''	244.11	122.
	250-03	NORTHING	1853682.87	1853589.31	1855610.79	1853502.43	0,000100	LEFT			
		EASTING	6646694.20	6646772.68	6648992.71	6646858.51					
		STATION	13+01.85	24+70.25		31+54.79	1,200.00	88°28′17''	4° 46′29''	1,852.94	1,168
	310-01	NORTHING	1842114.13	1840945.76	1842122.67	1840922.90	.,200100	LEFT		.,	.,
		EASTING	6675261.67	6675269.98	6676461.64	6676438.16					
RUAD 24 REALIGNMENT "RD 24"		STATION	35+52.49	37+81.87		39+87.13	550.00	45°16′44''	10°25′03″	434.65	229.
	310-02	NORTHING	1840915.12	1840910.63	1840365.22	1840744.52		RIGHT			
		EASTING	6676835.79	6677065.13	6676825.03	6677223.32					
		STATION	27+78.31	35+81.73	0010020.00	43+06.23	2,000.00	43° 46′18''	2° 51 ′53''	1,527.92	803.
	311-01	NORTHING	1839905.08	1839902.68	1841905.07	1840456.73	2,000.00	LEFT	2 31 33	1,521.52	005.
	511 01	EASTING	6675844.57	6676647.98	6675850.55	6677229.80					
		STATION		53+43.44	0075650.55	57+04.54	3 000 00	20° 55′32''	2° 51 ′53''	730.44	360
	311-02		49+74.10	-	1930/69 07		2,000.00		2 31 33	100.44	369.
	511-02	NORTHING	1840917.31	1841172.01	1839468.97	1841314.39		RIGHT			
		EASTING	6677713.45	6677980.91	6679092.70	6678321.70	700.00	459 46/501	0944/001		0.05
	700.04	STATION	11+69.34	14+64.90		17+28.66	700.00	45° 46′52''	8° 11 ′06''	559.32	295.
	320-01	NORTHING	1837282.83	1837284.39	1836582.84	1837073.66		RIGHT			
AVENUE 20 "AVE 20"		EASTING	6678557.18	6678852.73	6678560.87	6679059.97	700.00	479 40/751	0944/001		
AVE 20	700.05	STATION	36+78.85	39+59.61		42+12.86	700.00	43° 42′35"	8° 11′06''	534.01	280.
	320-02	NORTHING	1835683.20	1835483.02	1835192.38	1835202.30		RIGHT			
		EASTING	6680427.38	6680624.24	6679928.29	6680628.22					



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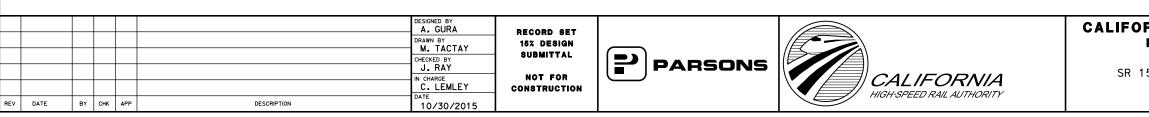
CALIFORNIA HIGH-SPEED TRAIN PROJECT MERCED TO FRESNO SECTION

CENTRAL VALLEY WYE SR 152 (NORTH) TO ROAD 19 WYE ALTERNATIVE GEOMETRY DATA TABLE SHEET 5 OF 6

ONTRACT NO. HSR08-05 CV-B0064-B

CALE NO SCALE

ROAD "ALIGNMENT NAME"	CURVE NO.		BC	ΡI	СС	EC	RADIUS (FT)	DELTA	DEGREE OF CURVATURE (ARC)	LENGTH (FT)	TANGEN (FT)
		STATION	50+48.78	51+36.39		52+15.16	215.00	44° 20′ 26''	26° 38′57''	166.39	87.61
	420-01	NORTHING	1855068.79	1855074.68	1855283.30	1855139.98		RIGHT			
AIRLANE COURT REALIGNMENT "FAIRLANE CT" ROAD 19 1/2 REALIGNMENT "RD 19 1/2" LINE		EASTING	6651788.01	6651700.60	6651802.46	6651642.20					
		STATION	57+73.65	58+55.77		59+30.52	215.00	41° 48′ 17''	26° 38′57''	156.87	82.11
	420-02	NORTHING	1855556.29	1855617.50	1855699.61	1855699.61		RIGHT			
		EASTING	6651269.91	6651215.18	6651430.18	6651215.18					
		STATION	10+39.58	11+28.93		12+11.21	250.00	39°20′05''	22°55′06''	171.63	89.35
	421-01	NORTHING	1854964.83	1855054.18	1854964.83	1855123.29		LEFT			
		EASTING	6651214.96	6651214.96	6650964.96	6651158.32					
		STATION	15+23.48	15+69.74		16+15.28	300.00	1 7° 31 ′59''	19°05′55''	91.80	46.26
	421-02	NORTHING	1855364.81	1855400.59	1855174.66	1855425.88		LEFT			
		EASTING	6650960.39	6650931.07	6650728.35	6650892.32					
		STATION	17+26.02	18+42.43		19+39.41	215.00	56° 52′04''	26° 38′57''	213.39	116.4
	421-03	NORTHING	1855486.41	1855550.04	1855666.45	1855666.45		RIGHT			
		EASTING	6650799.59	6650702.10	6650917.10	6650702.10					
		STATION	13+16.26	15+93.96		18+65.43	1,500.00	20° 58′36''	3° 49′11''	549.17	277.6
	460-01	NORTHING	1873327.22	1873604.91	1873327.22	1873864.20		LEFT			
		EASTING	6648504.06	6648504.06	6647004.06	6648404.65					
		STATION	23+90.76	29+01.03		33+55.70	1,200.00	46°04′20''	4° 46′29''	964.94	510.2
ROAD 19 REALIGNMENT "RD 19" LINE	460-02	NORTHING	1874354.71	1874831.16	1874784.30	1875293.25		RIGHT			
		EASTING	6648216.59	6648033.92	6649337.06	6648250.34					
		STATION	36+86.84	39+53.92		42+12.44	1,200.00	25°05′44''	4° 46′29''	525.60	267.0
	460-03	NORTHING	1875593.13	1875835.01	1876102.09	1876102.09		LEFT			
		EASTING	6648390.78	6648504.06	6647304.06	6648504.06					
		STATION	17+65.31	20+10.11		22+53.83	3,000.00	9°19′48''	1° 54′35''	488.51	244.8
	510-01	NORTHING	1879058.01	1879302.73	1878985.00	1879543.26		LEFT			
		EASTING	6627396.32	6627390.37	6624397.21	6627344.81					
		STATION	37+04.29	48+20.15		59+10.81	6,000.00	21°04′15″	0° 57′18''	2,206.52	1,115.
MINTURN ROAD / ROAD 15 "MINTURN RD"	510-02	NORTHING	1880968.38	1882064.76	1882084.89	1883162.48		RIGHT			
		EASTING	6627074.90	6626867.26	6632970.11	6627067.67					
		STATION	73+09.90	75+81.52		78+51.65	3,000.00	10°20′48''	1° 54′35''	541.76	271.6
	510-03	NORTHING	1884538.82	1884806.02	1885077.62	1885077.64		LEFT			
		EASTING	6627318.94	6627367.72	6624367.72	6627367.72					



321

CALIFORNIA HIGH-SPEED TRAIN PROJECT MERCED TO FRESNO SECTION CENTRAL VALLEY WYE SR 152 (NORTH) TO ROAD 19 WYE ALTERNATIVE GEOMETRY DATA TABLE SHEET 6 OF 6

CONTRACT	NO.
HSRO	08-05
	NO

CV-B0065-B

NO SCALE

Utility Type	Conflict ID #	Utility	Description	Approximate Location of Conflict	Potential Project Impact	Sheet #
	JVC-2	Electric Overhead	115 KV, crossing at Eastside Bypass	5786+10		CV-S1080-B to CV-S1090
	JVC-3	Electric Overhead	70 KV, west side of Road 4 / Lincoln Road	5945+70		CV-S1110-B to CV-S1111
	WYH-1	Electric Overhead	115 KV, east side of Road 11	6315+85	-	CV-S1180-B
	WYH-2	Electric Overhead	115 KV, west side of Road 13	6420+35	-	CV-S1200-B
			270 KV Disease bases in Band 40 months of Damada Character	14955+00	-	CV-S1450-B
	WYH-4	Electric Overhead	230 KV, Diagonal crossing Road 19 north of Berenda Slough	36832+00		CV-S1650-B
Electrical Utility >60KV				36832+00	High Risk	CV-S1650-B to CV-S166
	WYH-3	Electric Overhead	115 KV, south side of Avenue 26	14969+45	-	CV-S1450-B
			115 KV, longitudinal east side of Road 19	14955+40 to 15047+40	-	CV-S1450-B to CV-S146
	WYH-5	Electric Overhead	230 KV	15021+25	-	CV-S1490-B
	WYH-6	Electric Overhead	115 KV, west side of Minturn Road (Road 15)	15276+20		CV-S1510-B
	WYH-7	Electric Overhead	230 KV, Diagonal at Road 22 & Avenue 22	6883+80 to 6929+25		CV-S1280-B to CV-S129
	WYH-16	Electric Overhead	115 KV, north side of Sandy Mush Road	15466+50		CV-S1540-B to CV-S154
	G44	Natural Gas	12", east side of Chowchilla Blvd	36704+10		CV-S1630-B
	G39	Natural Gas	8", east side of Chowchilla Blvd	36704+35		CV-S1630-B
	G30	Natural Gas	12", adjacent to west side of UPRR ROW	15412+90 TO 15655+00		CV-S1530-B to CV-S157
	G52	Natural Gas	8" line on west side of Fairmead Blvd	6716+50		CV-S1250-B
Natural Gas Line	G51	Natural Gas	12", west side of Fairmead Blvd	6716+65	High Risk	CV-S1250-B
	WYH-8	Natural Gas	4" Feeder Main, west side of Road 22	6905+75		CV-S1280-B to CV-S129
	WYH-8	Natural Gas	4" Feeder Main, north side of Avenue 22	6935+45		CV-S1290-B
	G4	Natural Gas	4" Feeder Line at unknown location on west side of Road 4 (Lincoln Rd)	Approximately 5946+35	-	CV-S1110-B
	JVC-8	Challenger Pipeline	8-inch, high pressure natural gas gathering steel line on west side of Flanagan Road	5724+30	High Risk	CV-S1020-B to CV-S107
				36702+25		CV-S1630-B
Petroleum Products	P2	Petroleum	12.75" O.D. / 12" I.D 0.219" WT X-60 high pressure, east side of UPRR	6716+25	High Risk	CV-S1250-B
				15412+70 TO 15462+90		CV-S1530-B to CV-S154

<u>NOTES:</u>

1. ALL CONFLICTS ARE TRANSVERSE UNLESS OTHERWISE NOTED. ALL PIPE SIZES ARE SHOWN IN INCHES IN DIAMETER.

2. REFER TO THE 15% UTILITY REPORT FOR ADDITIONAL UTILITY INFORMATION.

3. REFER TO THE 15% HYDROLOGY AND HYDRAULICS REPORT FOR ADDITIONAL WATER CROSSING INFORMATION.

REV DATE	BY	нкарр	DESCRIPTION	DESIGNED BY D.SCHWANIK DRAWN BY M. TACTAY CHECKED BY A. GURA IN CHARGE C. LEMLEY DATE 02 (13 (2015	RECORD SET 15% design Submittal Not for Construction	PARSONS	CALIFORNIA HIGH-SPEED RAIL AUTHORITY	CENTRAL VALLEY WYE SR 152 (NORTH) TO ROAD 19 WYE ALTERNATIVE UTILITY CONFLICT TABLE	CONTRACT NO. HSR08-05 DRAWING NO. CV-B0070-B SCALE NO SCALE SHEET NO.
REV DATE	ВТ		DESCRIPTION	02/13/2015)		

29-0CT-201513:49 MF-CV-B0070-B.dgr

4321

Utility Type	Conflict ID #	U+ility		Description	Approximate Location of Conflict	Potential Project Impact	Sheet #	
	JVC-65	Irrigation Ditch #40		Unknown flow, irrigation infrastructure	5348+00		CV-S1010-B	
	JVC-66	West San Juan Drain No. 1		Max flow - 20 cfs, irrigation infrastructure	5361+10		CV-S1010-B	
	JVC-137	Irrigation Ditch #41			5378+70		CV-S1010-B	
	JVC-38	Irrigation Ditch #42		Unknown flow, irrigation infrastructure	5391+70		CV-S1010-B	
	JVC-39	San Juan Canal		Max flow - 80 cfs, irrigation infrastructure	5399+50		CV-S1020-B	
	JVC-40	San Juan Drain		Unknown flow, irrigation infrastructure	5419+00		CV-S1020-B	
	JVC-85	Irrigation Ditch #43		Max flow - 80 cfs, irrigation infrastructure	5427+90		CV-S1020-B	
	JVC-41	Temple Santa Rita Canal			5436+95		CV-S1020-B	
	JVC-42	West Santa Rita Drain			5446+30		CV-S1020-B	
	JVC-67	Drain No. 2			5494+60		CV-S1030-B	
	JVC-68	Escano Branch Ditch			5496+90		CV-S1030-B	
	JVC-85	Drain No. 3			5509+15]	CV-S1040-B	
	JVC-45	Orchard Ditch			5521+70		CV-S1040-B	
	JVC-70	Santa Rita Slough			5522+75		CV-S1040-B	
	JVC-71	Santa Rita Drain No. 1	in No. 1		5527+90	Low Risk	CV-S1040-B	
Water Infrastructure	JVC-72	Drain No. 4		Unknown flow, irrigation infrastructure	5535+55		CV-S1040-B	
	JVC-73	Santa Rita Drain No. 1A			5544+75		CV-S1040-B	
	JVC-86	Drain No. 5			5564+20		CV-S1050-B	
	JVC-88	Santa Rita Ditch		5564+75		CV-S1050-B		
	JVC-87	Island Field			5573+20		CV-S1050-B	
	JVC-12	Lucerne Ditch			5594+40		CV-S1050-B	
	JVC-148	Historical Wood Slough			5596+00 to 5596+75		CV-S1050-B	
	JVC-13	Wood Slough			5623+55		CV-S1060-B	
	JVC-147	Irrigation Ditch #57			5646+00		CV-S1060-B	
	JVC-74	Riverside Canal		Max flow - 50 cfs, irrigation infrastructure	5666+55		CV-S1060-B	
	JVC-98	San Joaquin River			5567+20 to 5570+40		CV-S1060-B	
	JVC-101	Mariposa Slough		NZA	5685+85		CV-S1070-B	
	JVC-15	Eastside Bypass			5772+10 to 5783+85	-	CV-S1080-B	
	JVC-46	Chowchilla Canal		Unknown flow, concrete lined irrigation infrastructure	5976+00		CV-S1120-B	
	JVC-77	Ash Slough		NZA	6276+40 +0 6282+40		CV-S1170-B	
	JVC-15 JVC-46	Eastside Bypass Chowchilla Canal		Unknown flow, concrete lined irrigation infrastructure N/A <u>NOTES:</u> 1. ALL CONFLICTS ARE	5772+10 to 5783+85 5976+00		CV-S1080-B CV-S1120-B CV-S1170-B ZES ARE SHOWN IN INCHE	s in
		DESIGNED BY			HYDROLOGY AND HYDRAULICS REPORT F	OR ADDITIONAL	WATER CROSSING INFORM	CONTRACT N
		DRAWN BY M. TACTAY	ECORD SET 5% design Bu bmitt al		MERCED '	TO FRESNO	SECTION	HSR08-0 DRAWING NO. CV-B007
		CHECKED BY A. GURA IN CHARGE	NOT FOR	PARSONS	SR 152 (NORTH)		YE ALTERNATIVE	SCALE
			NSTRUCTION	CALIFORNIA HIGH-SPEED RAIL AUTHORITY		TY CONFLICT SHEET 2 OF 4		NO SCALE

0044321

Utility Type	Conflict ID #	U+ili+y	Description	Approximate Location of Conflict	Potential Project Impact	Sheet #
	JVC-80	Road 11 Canal	Max flow - 24 cfs, irrigation infrastructure	6316+30		CV-S1180-B
	JVC-82	Bethel Canal	Max flow - 40 cfs, irrigation infrastructure	6406+55		CV-S1200-B
	JVC-133	Berenda Canal	Max flow - 875 cfs, irrigation infrastructure	6478+40		CV-S1210-B
	JVC-120	Berenda P.L.	42" M.C.P. irrigation infrastructure, Unknown flow, east side of Road 15	6526+85		CV-S1220-B
	JVC-111	Berenda Slough	N/A	6544+00 to 6547+65		CV-S1220-B
	JVC-113	Califa Canal	Max flow 600 cfs, irrigation infrastructure	6737+85		CV-S1250-B
	WYH-17	Lat 32.2	Max flow 600 cfs, irrigation infrastructure	6878+20		CV-S1280-B
	JVC-130	Berenda Creek	NZA	7009+80 to 7010+25		CV-S1300-B
	JVC-129	24.2-8.9-1.0	Max flow 320 cfs, irrigation infrastructure	7097+00		CV-S1320-B
	JVC-143	24.2-8.9	Unknown flow, irrigation infrastructure	7115+65		CV-S1320-B
	JVC-134	Dry Creek	N/A	7128+40 to 7129+25		CV-S1320-B
	JVC-131	24.2	Max flow 990 cfs, irrigation infrastructure	7166+70		CV-S1330-B
Water Infrastructure	JVC-113	Califa Canal	Max flow 600 cfs, irrigation infrastructure	14948+80	Low Risk	CV-S1450-B
	WO 111	Deveende Cleviek	N 74	14951+00 to 14955+20		CV-S1450-B
	JVC-111	Berenda Slough	N/A	36828+00 to 36831+60		CV-S1650-B
	JVC-136	Main Canal	Unknown flow, irrigation infrastructure	14995+80		CV-S1460-B
	JVC-77	Ash Slough	N/A	15008+00 to 15011+25		CV-S1460-B
	JVC-107	Chowchilla River	N/A	15108+10 to 15113+30		CV-S1480-B
	JVC-110	Dutchman Creek	N/A	15433+00		CV-S1530-B
	JVC-105	Deadman's Creek	NZA	15575+70		CV-S1560-B
				36675+20		CV-S1620-B
	JVC-112	Califa Lateral A	Max flow - 320 cfs, Irrigation infrastructure	36696+65		CV-S1630-B
				36781+05		CV-S1640-B
			Nav flow - 600 of a Instantion infrantsucture	36737+60		CV-S1630-B
	JVC-113	Califa Canal	Max flow - 600 cfs, Irrigation infrastructure	36778+50 to 36825+80		CV-S1640-B to CV-S1650
orm Water Infrastructure	e		None Found			

/ DATE BY	аларанананананананананананананананананан	DESCRIPTION	DESIGNED BY D.SCHWANIK DRAWN BY M. TACTAY CHECKED BY A. GURA IN CHARGE C. LEMLEY DATE 10/30/2015	RECORD SET 15% design Submittal Not for Construction	PARSONS	CALIFORNIA HIGH-SPEED RAIL AUTHORITY	CENTRAL VALLEY WYE SR 152 (NORTH) TO ROAD 19 WYE ALTERNATIVE UTILITY CONFLICT TABLE	CONTRACT NO. HSR08-05 DRAWING NO. CV-B0072-B SCALE NO SCALE SHEET NO.
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<u>NOTES:</u>

2. REFER TO THE 15% UTILITY REPORT FOR ADDITIONAL UTILITY INFORMATION.

3. REFER TO THE 15% HYDROLOGY AND HYDRAULICS REPORT FOR ADDITIONAL WATER CROSSING INFORMATION.

1. ALL CONFLICTS ARE TRANSVERSE UNLESS OTHERWISE NOTED. ALL PIPE SIZES ARE SHOWN IN INCHES IN DIAMETER.

Utility Type	Conflict ID #	U+ili+y	Description	Approximate Location of Conflict	Potential Project Impact	Sheet #
	Т97	Fiber Optic	Underground Trenched Ducts with Fiber Optic, east side of Fairmead Blvd	6717+05		CV-S1250-B
	Т89	Fiber Optic	Underground trenched, 4 Ducts, east side of Chowchilla Blvd.	36703+35		CV-S1630-B
	T44	Fiber Optic	Underground trenched, 4 Ducts, east side of UPRR	15412+70 to 15460+70		CV-S1530-B to CV-S1540-B
	F9	Fiber Optic	Underground 2-2"HDPE, west side of UPRR	6715+85		CV-S1250-B
	F9	Fiber Optic	Underground 2-2"HDPE, east side of UPRR	36702+50		CV-S1630-B
Communication Facilities	F9	Fiber Optic	Underground 2-2"HDPE, east side of UPRR	15412+70 to 15460+90	Low Risk	СV-S1530-В +о СV-S1540-В
	F11	Fiber Optic	Underground Telephone, west side of UPRR	6716+00		CV-S1250-B
	F11	Fiber Optic	Underground Telephone, east side of UPRR	36702+35		CV-S1630-B
	F11	Fiber Optic	Underground Telephone, east side of UPRR	15412+70 to 15460+95		CV-S1530-B to CV-S1540-B
	JVC-56	Copper Cable	Buried cable. Runs North-South on the west side of Elgin Road right-of-way. 12 Pair.	5468+15		CV-S1030-B to CV-S1032-B
	JVC-57	Copper Cable	Buried cable. Runs North-South on the east side of Indiana Road right-of-way. 6 Pair.	5565+05		CV-S1050-B

NOTES:

2. REFER TO THE 15% UTILITY REPORT FOR ADDITIONAL UTILITY INFORMATION.

3. REFER TO THE 15% HYDROLOGY AND HYDRAULICS REPORT FOR ADDITIONAL WATER CROSSING INFORMATION.


DATE	BY	СНК	APP		DESIGNED BY D.SCHWANIK DRAWN BY M. TACTAY CHECKED BY A. GURA IN CHARGE C. LEMLEY DATE 10/30/2015	RECORD SET 15% DESIGN Submittal Not for Construction	PARSONS	CALIFORNIA HIGH-SPEED RAIL AUTHORITY	CALIFOR N SR 15
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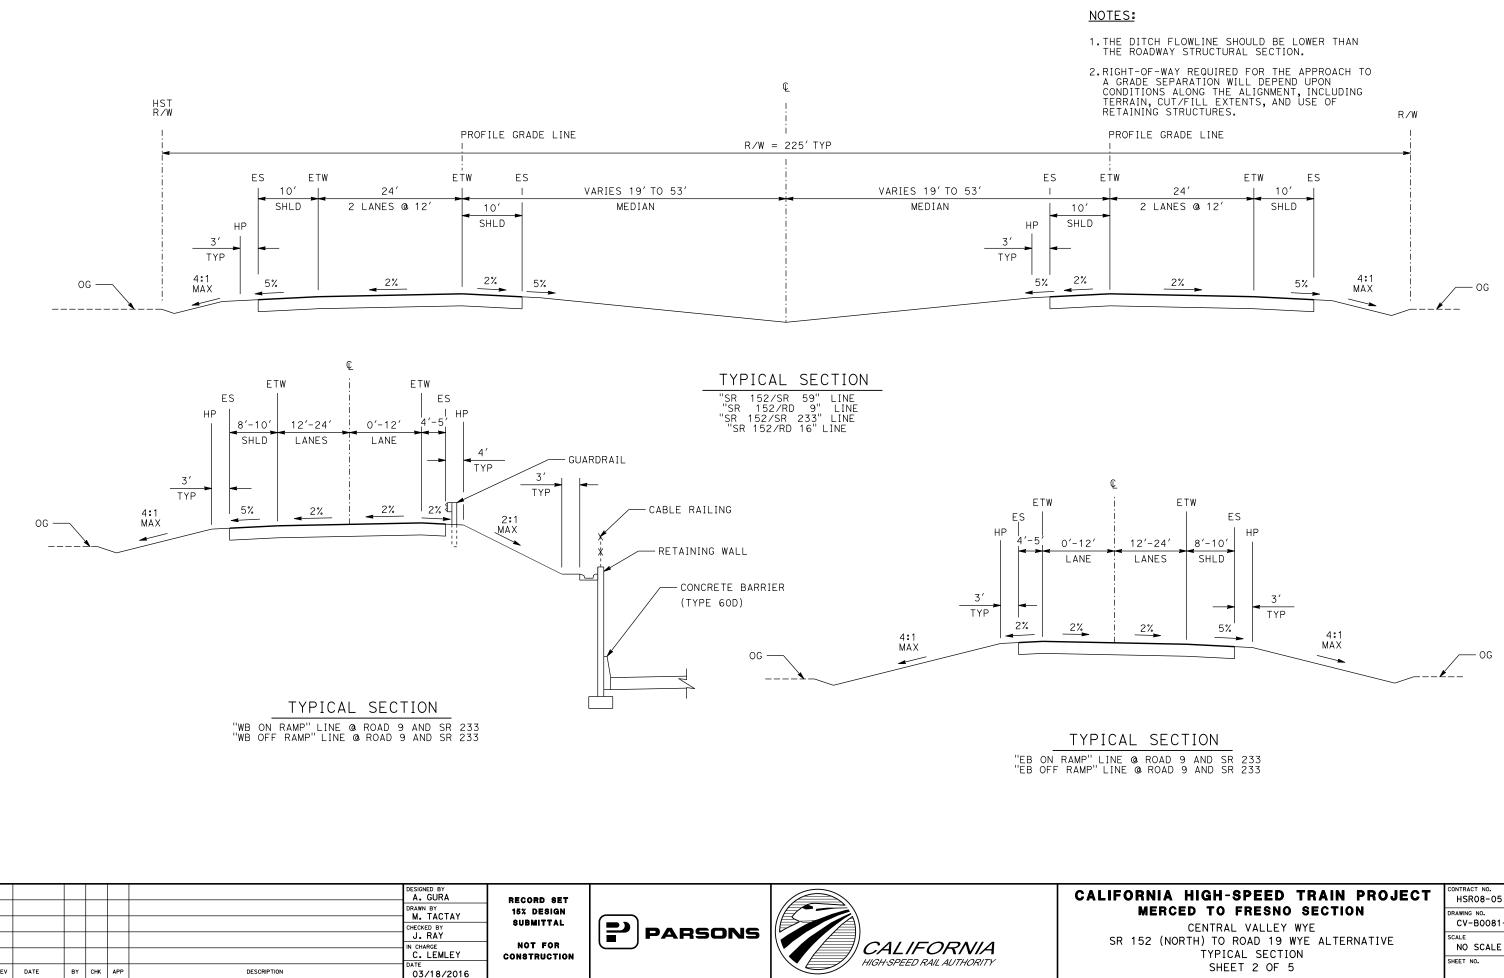
REV

1. ALL CONFLICTS ARE TRANSVERSE UNLESS OTHERWISE NOTED. ALL PIPE SIZES ARE SHOWN IN INCHES IN DIAMETER.

ONTRACT NO. NIA HIGH-SPEED TRAIN PROJECT HSR08-05 MERCED TO FRESNO SECTION RAWING NO. CV-B0073-B CENTRAL VALLEY WYE 52 (NORTH) TO ROAD 19 WYE ALTERNATIVE UTILITY CONFLICT TABLE CALE NO SCALE SHEET NO. SHEET 4 OF 4




REV DATE

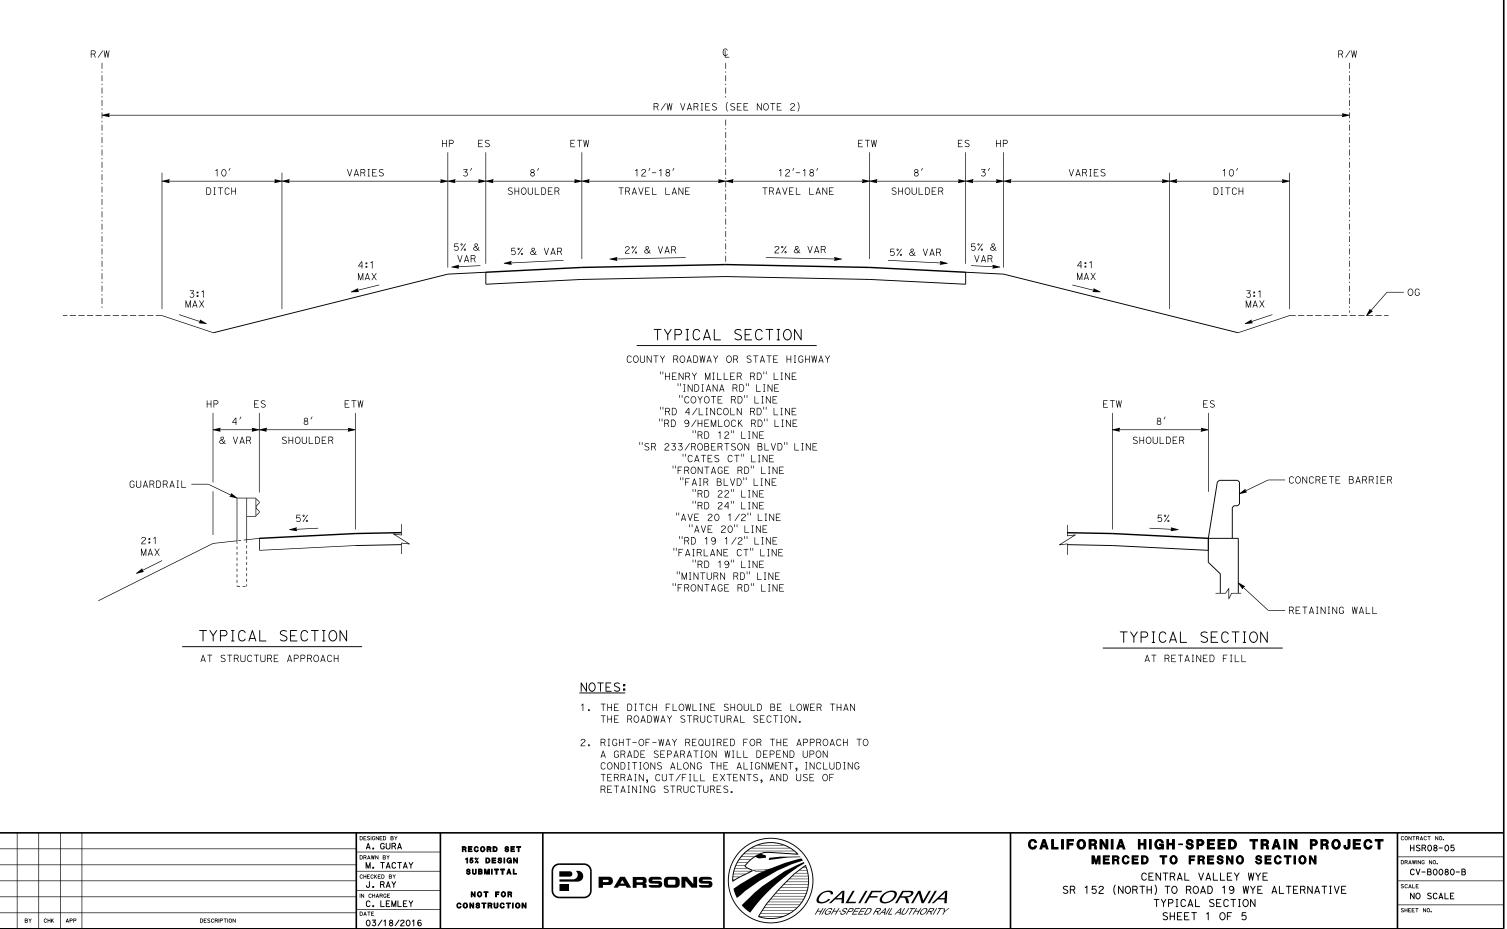

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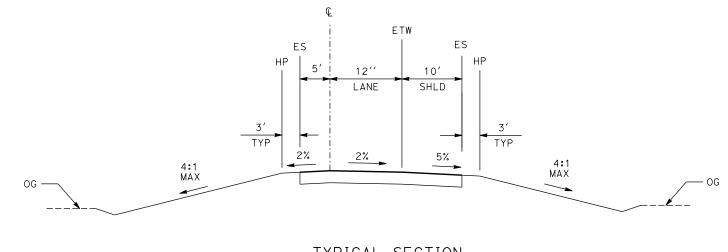
DESCRIPTION

NIA HIGH-SPEED TRAIN PROJECT	CONTRACT NO. HSR08-05
MERCED TO FRESNO SECTION Central Valley Wye	DRAWING NO. CV-BOO81-B
52 (NORTH) TO ROAD 19 WYE ALTERNATIVE TYPICAL SECTION	SCALE NO SCALE
SHEET 2 OF 5	SHEET NO.

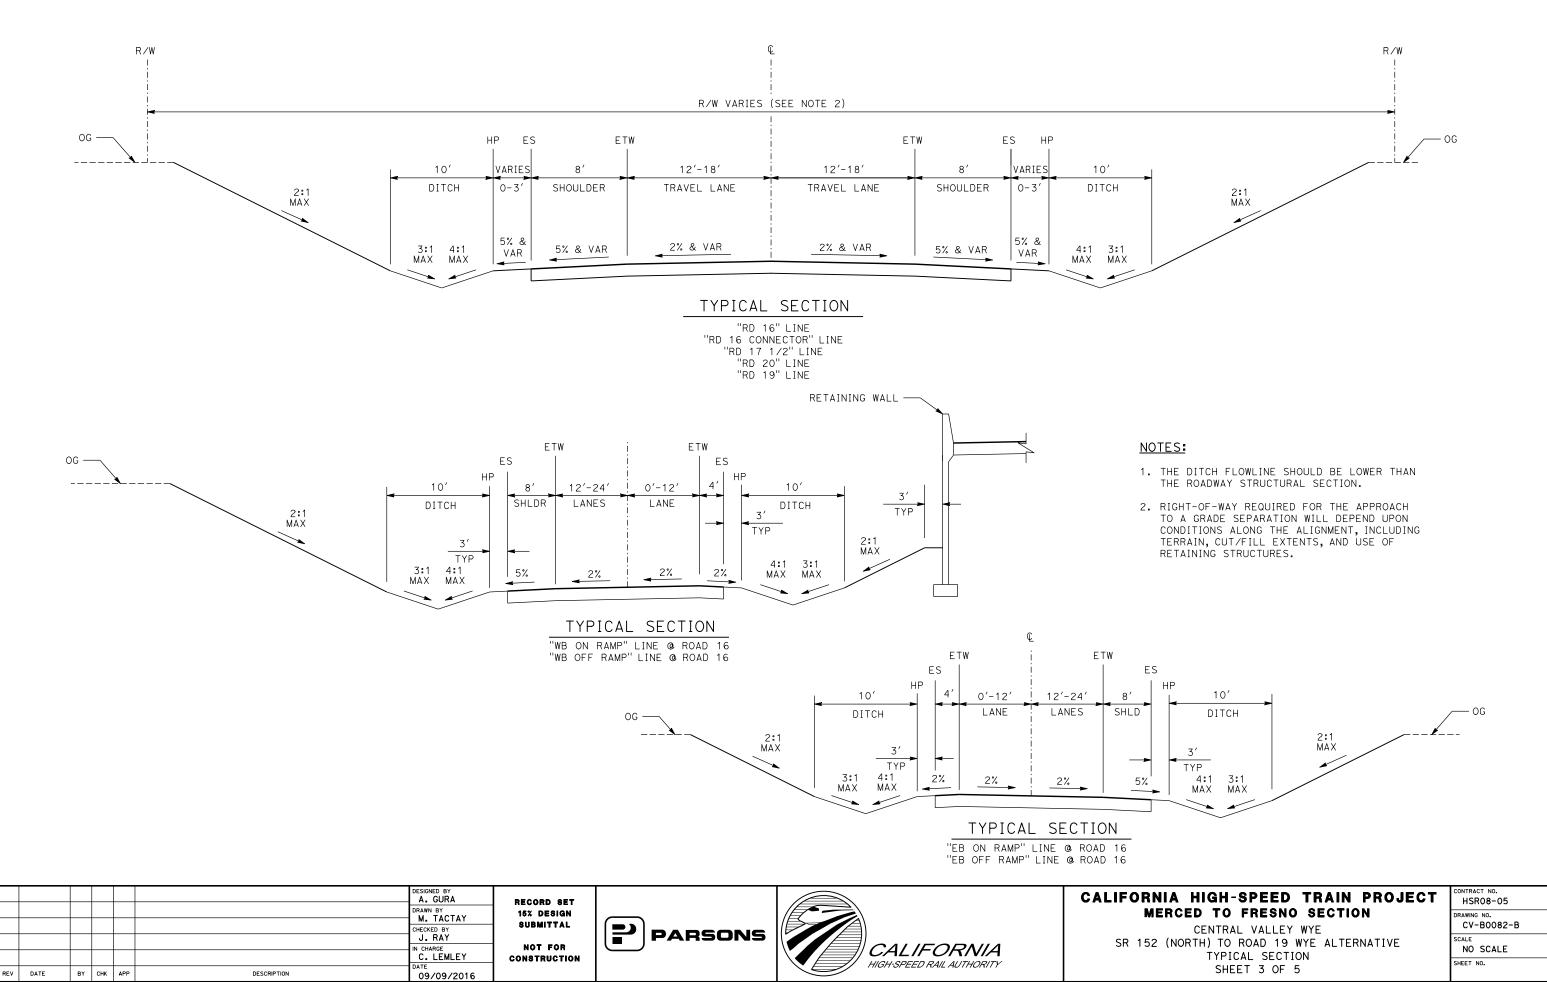


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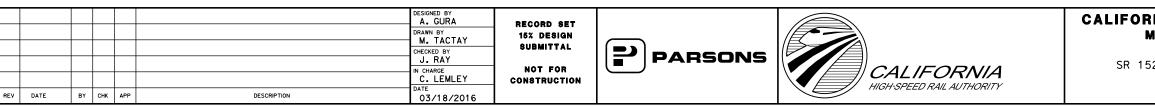
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MERCED TO FRESNO SECTION CENTRAL VALLEY WYE	DRAWING NO. CV-B0082-B
2 (NORTH) TO ROAD 19 WYE ALTERNATIVE TYPICAL SECTION	NO SCALE
SHEET 3 OF 5	SHEET NO.



TYPICAL SECTION "WB ON RAMP" LINE @ SR 59 "WB OFF RAMP" LINE @ SR 59 "EB ON RAMP" LINE @ SR 59

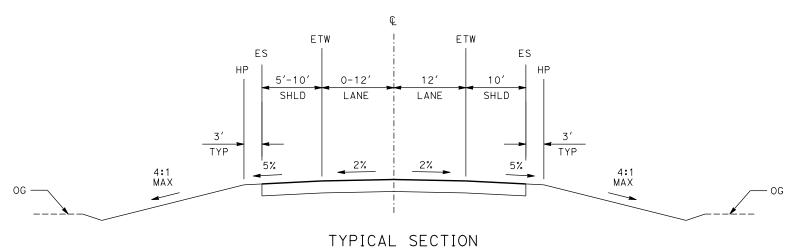

"EB OFF RAMP" LINE @ SR 59



4-MAR-201612:25 MF-CV-B0083-B

NOTES:


- 1. THE DITCH FLOWLINE SHOULD BE LOWER THAN THE ROADWAY STRUCTURAL SECTION.
- RIGHT-OF-WAY REQUIRED FOR THE APPROACH TO A GRADE SEPARATION WILL DEPEND UPON CONDITIONS ALONG THE ALIGNMENT, INCLUDING TERRAIN, CUT/FILL EXTENTS, AND USE OF RETAINING STRUCTURES.

NIA HIGH-SPEED TRAIN PROJECT	CONTRACT NO. HSR08-05
MERCED TO FRESNO SECTION Central Valley wye	DRAWING NO. CV-B0083-B
52 (NORTH) TO ROAD 19 WYE ALTERNATIVE TYPICAL SECTION	NO SCALE
SHEET 4 OF 5	SHEET NO.

MAY-201519:44									
20-				DESIGNED BY A. GURA DRAWN BY M. TACTAY CHECKED BY	RECORD SET 15% design Submittal			CALIFORNIA HIGH-SPEED TRAIN PROJECT MERCED TO FRESNO SECTION CENTRAL VALLEY WYE	CONTRACT NO. HSR08-05 DRAWING NO. CV-B0084-B
p0021811	EV DATE BY CHK	APP	DESCRIPTION	J. RAY IN CHARGE C. LEMLEY DATE 05/08/2015	NOT FOR Construction	PARSONS	CALIFORNIA HIGH-SPEED RAIL AUTHORITY	SR 152 (NORTH) TO ROAD 19 WYE ALTERNATIVE TYPICAL SECTION	SCALE NO SCALE SHEET NO.


TYPICAL SECTION "SR 152/RD 17 1/2" LINE

4

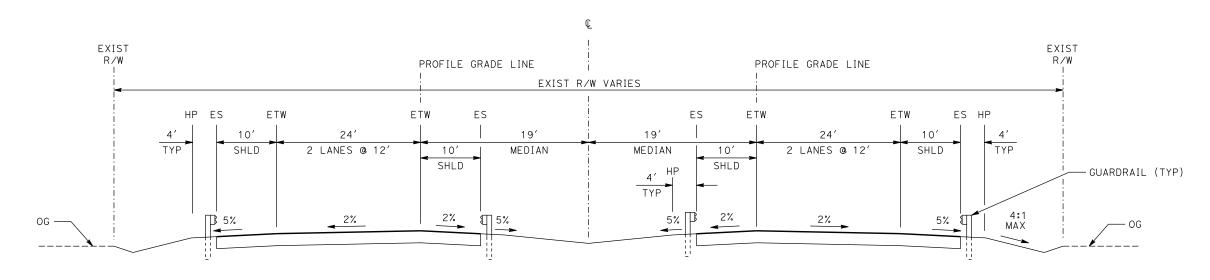



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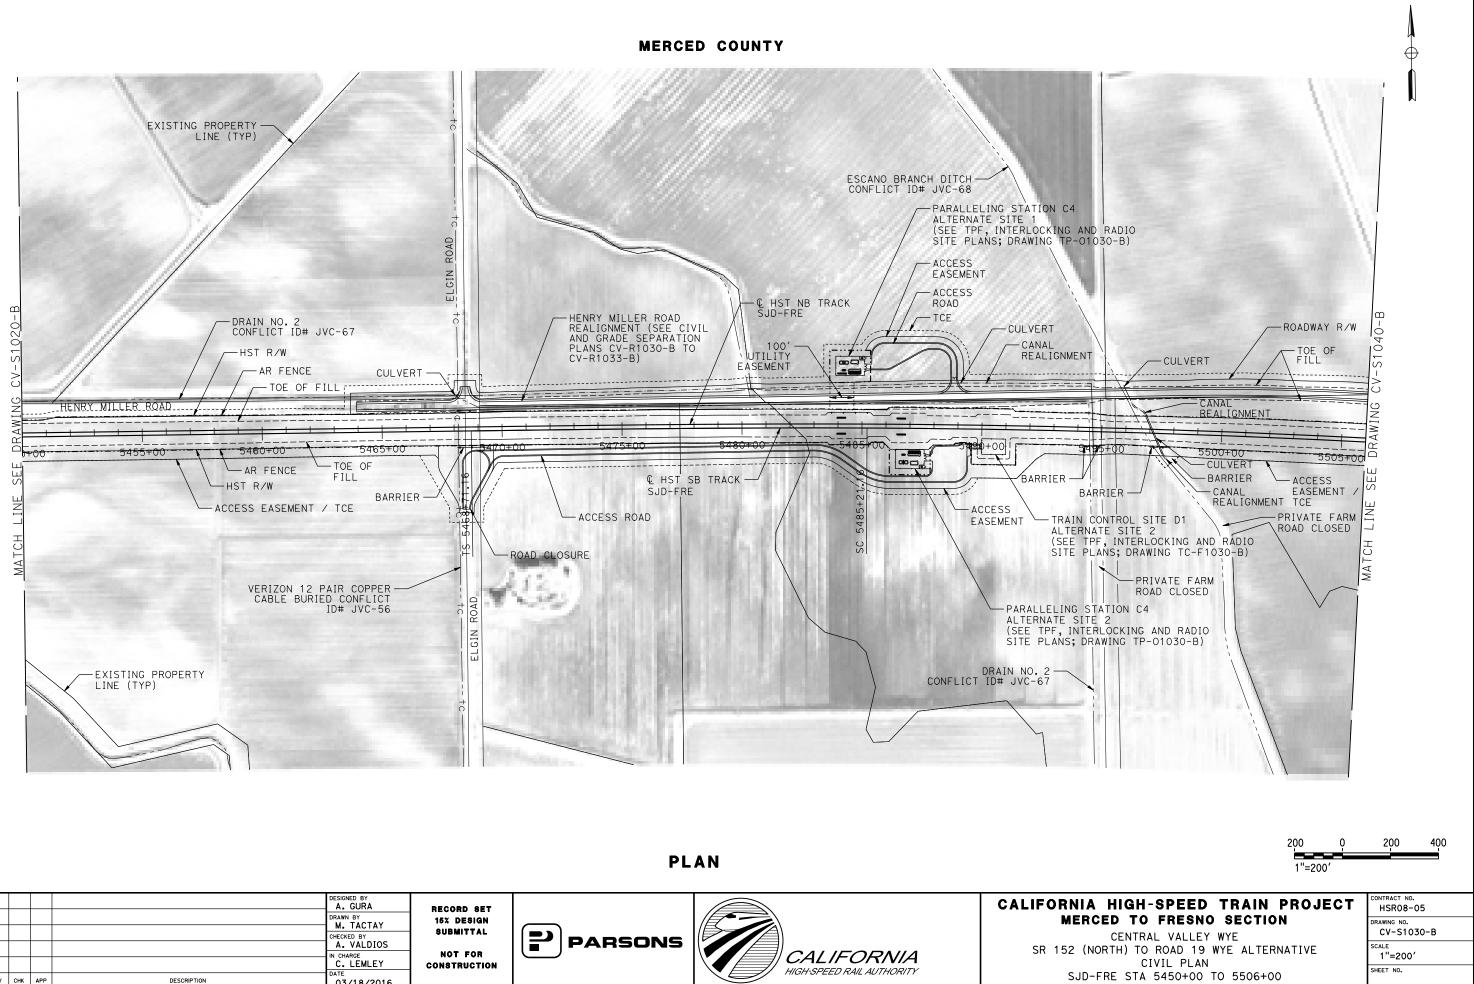
- 1. THE DITCH FLOWLINE SHOULD BE LOWER THAN THE ROADWAY STRUCTURAL SECTION.
- 2. RIGHT-OF-WAY REQUIRED FOR THE APPROACH TO A GRADE SEPARATION WILL DEPEND UPON CONDITIONS ALONG THE ALIGNMENT, INCLUDING TERRAIN, CUT/FILL EXTENTS, AND USE OF RETAINING STRUCTURES.

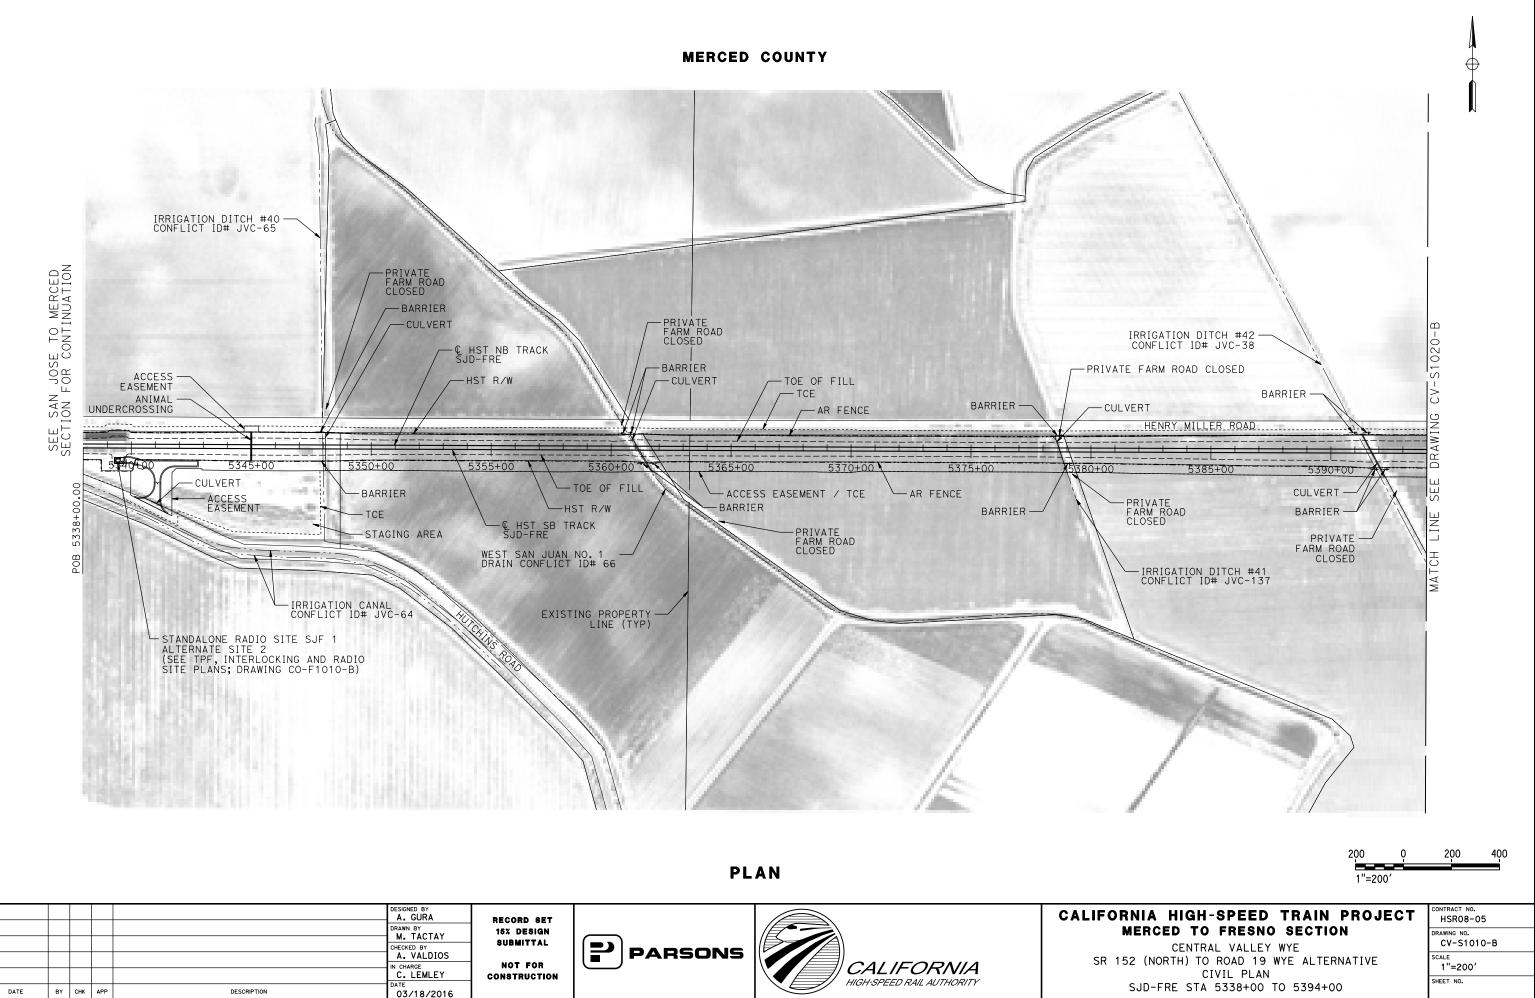


REV




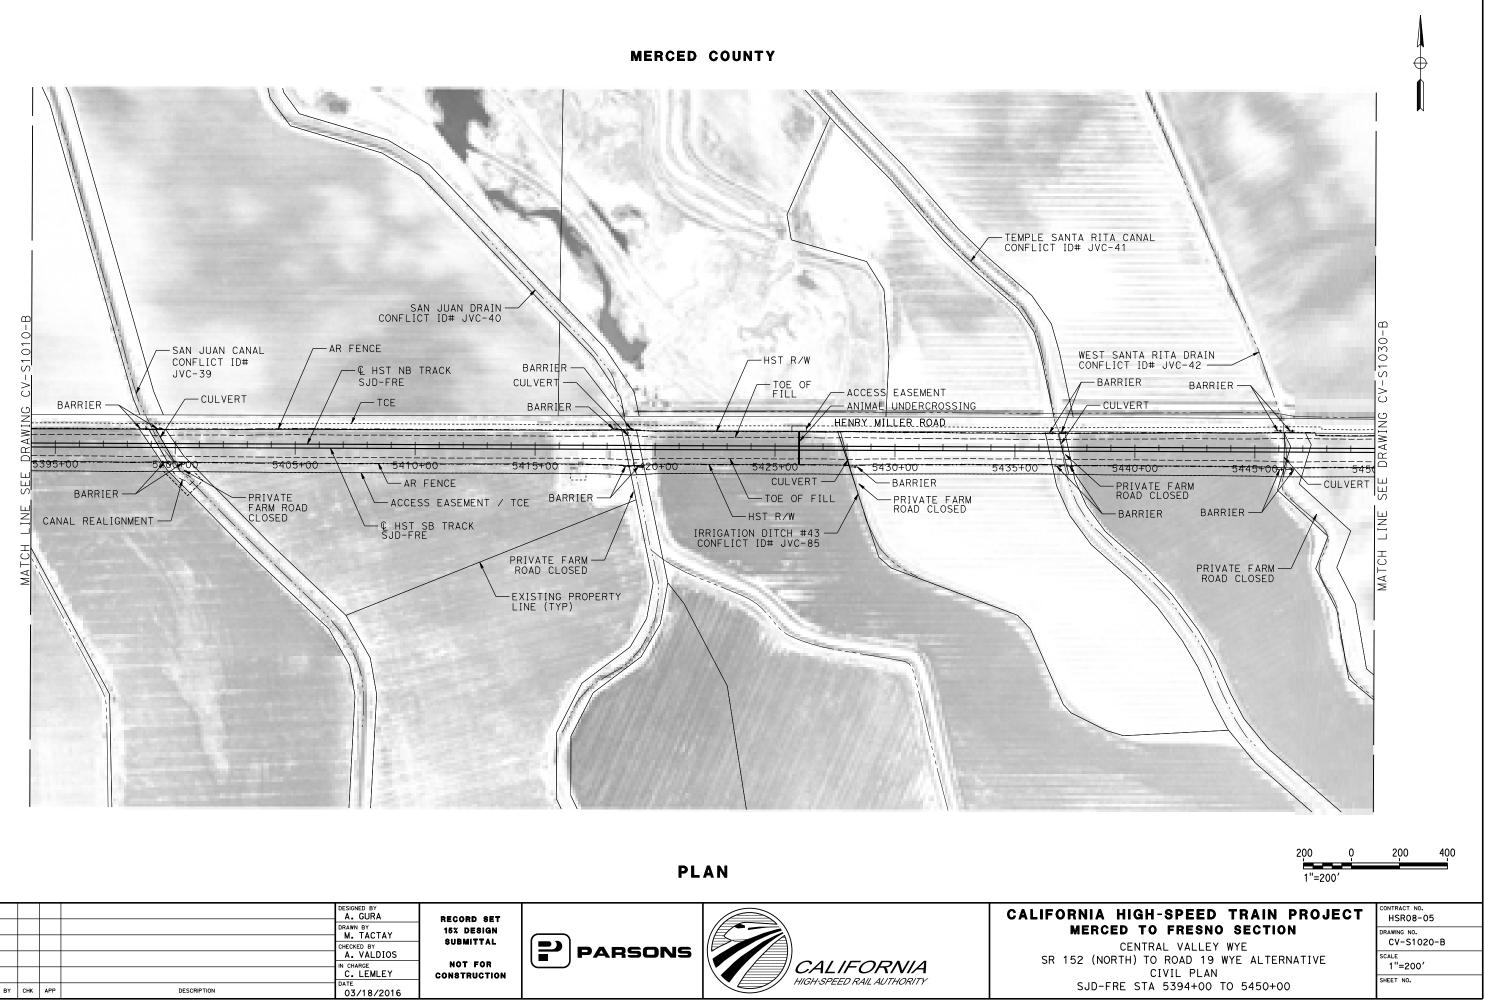

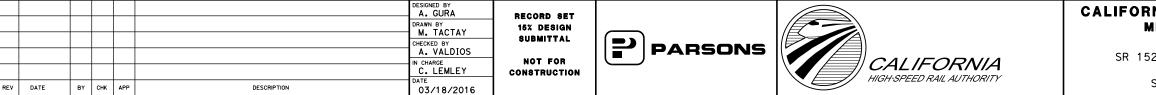


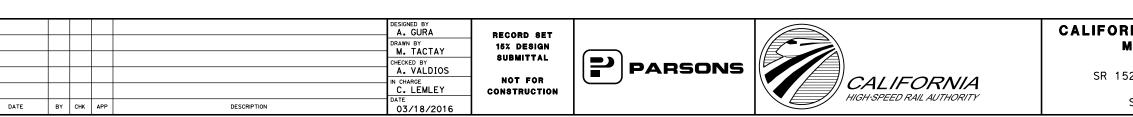


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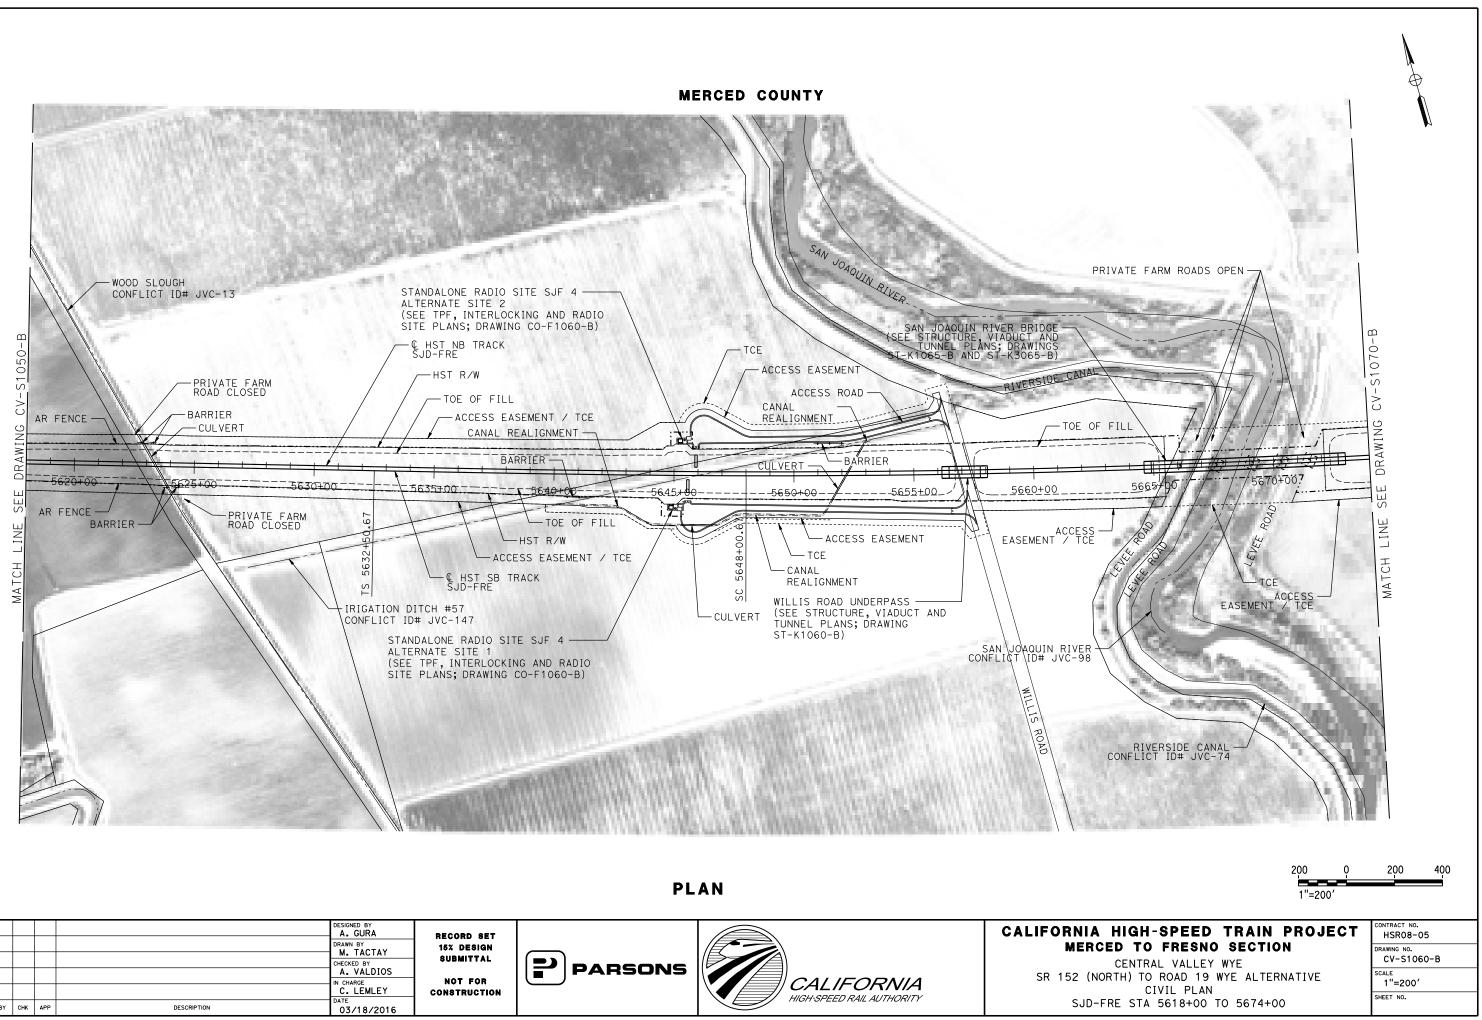


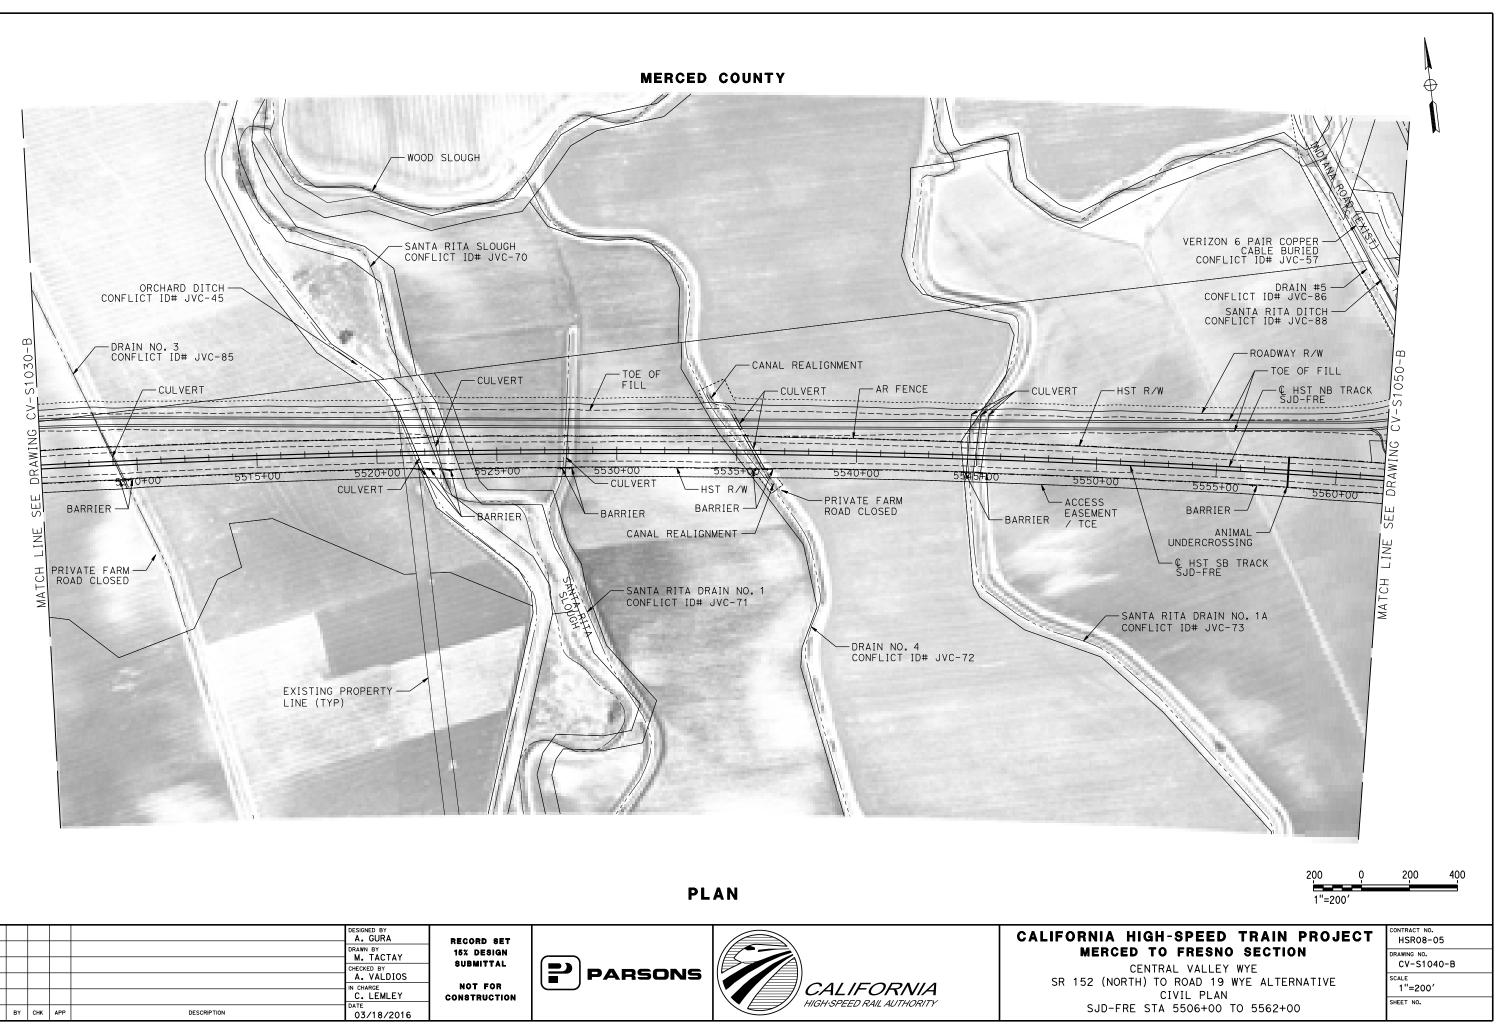REV DATE




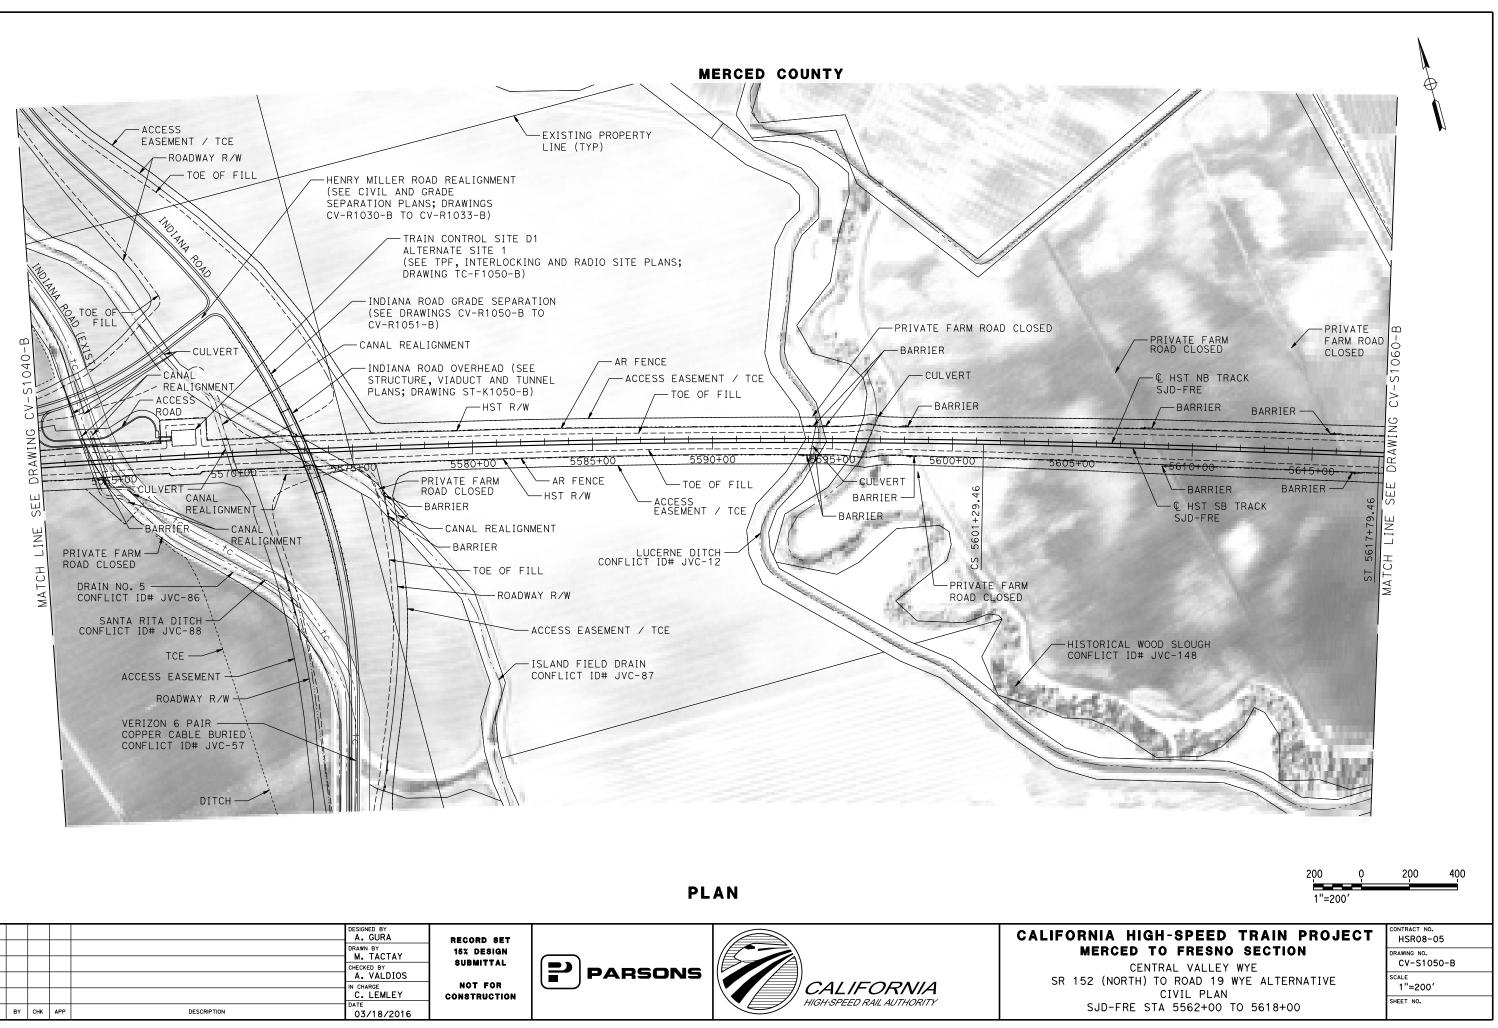





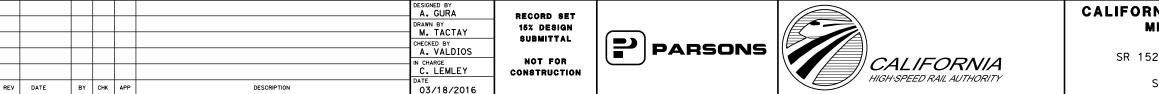


REV DATE BY CHK APP

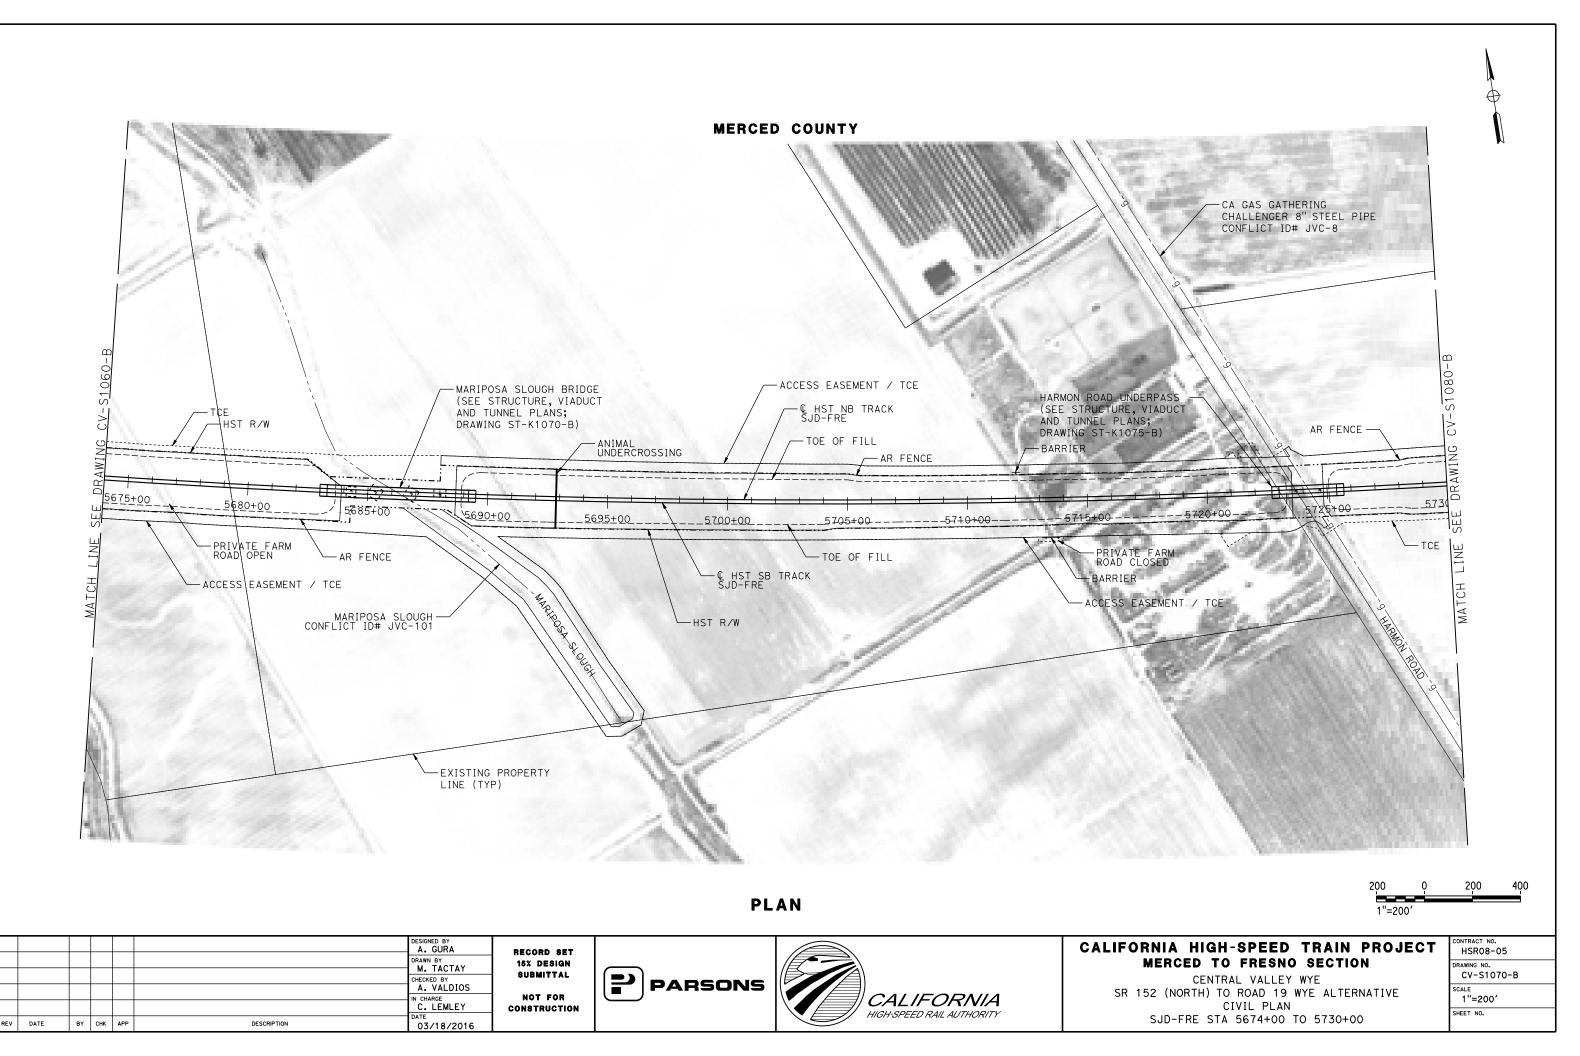

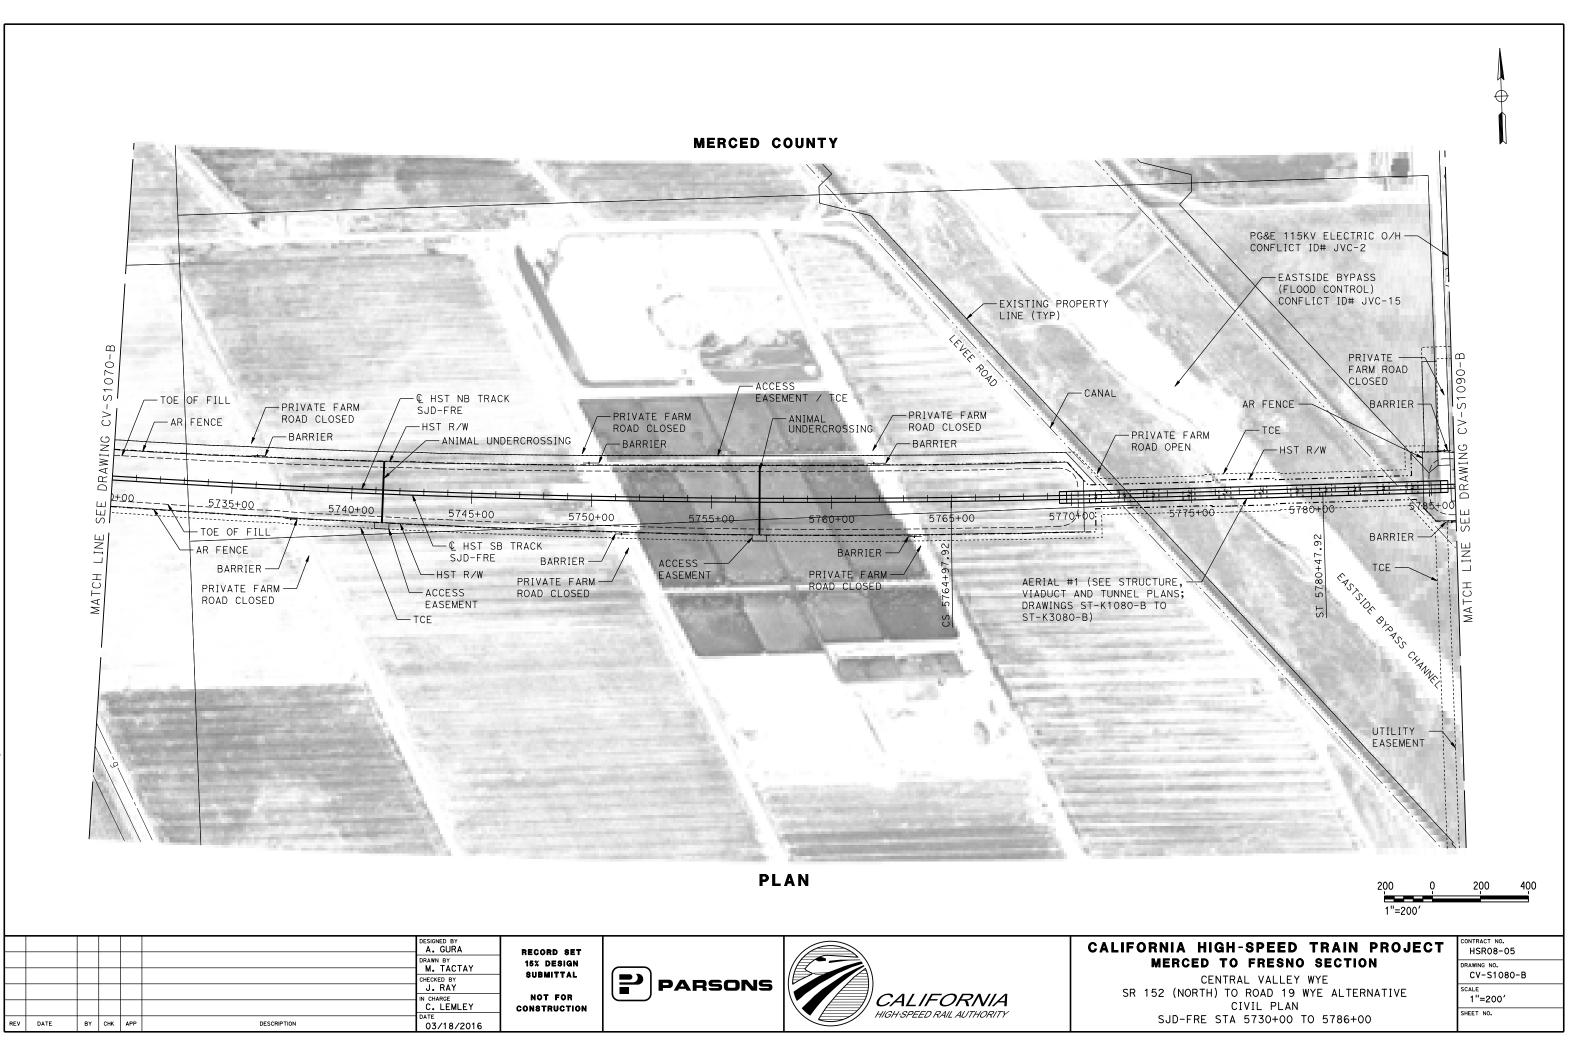

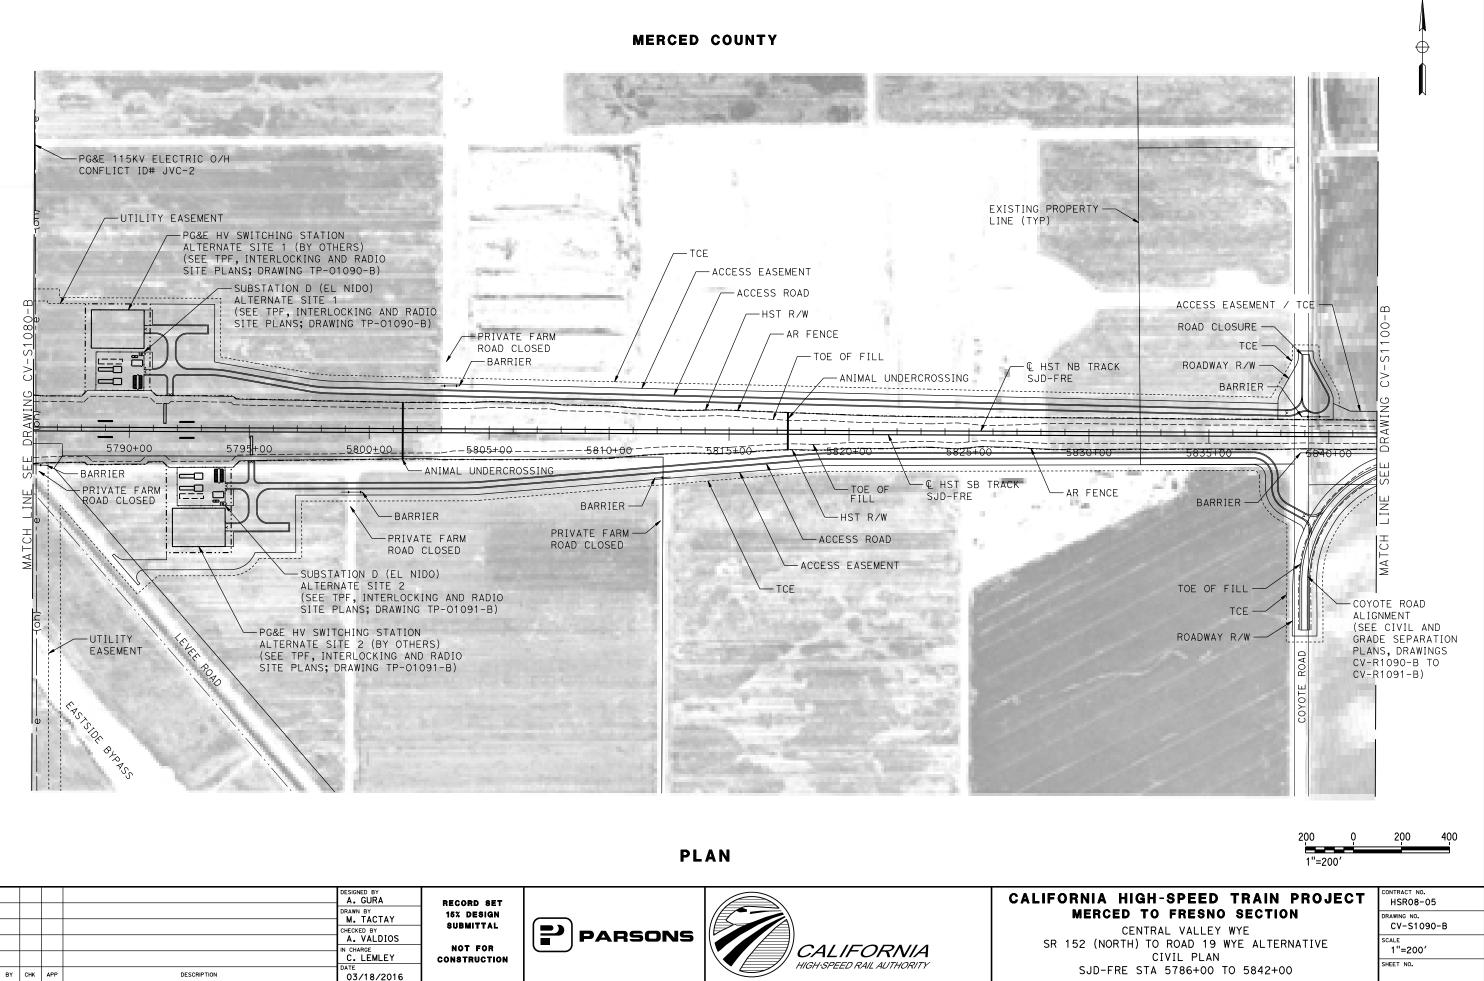



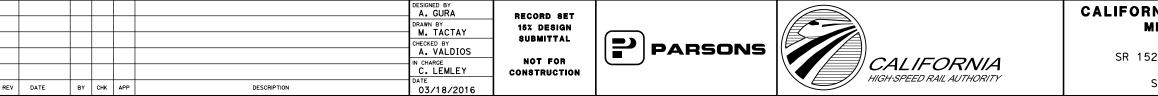

-EXISTING PROPERTY LINE (TYP) SR 152/ SR 59 INTERCHANGE -REALIGNMENT (SEE DRAWINGS CV-R1104-B TO CV-R1110-B) ACCESS EASEMENT TOE OF FIL SR 59/ SR 152 INTERCHANGE (SEE STRUCTURE, VIADUCT -PRIVATE FARM ACCESS AND TUNNEL PLANS; DRAWINGS -PRIVATE FARM ROAD CLOSED EASEMENT / TCE ST-K1100-B TO ST-K1102-B) ROAD CLOSED BARRIER BARRIER HST R/W STANDALONE RADIO SITE SJF 6 - AR FENCE ALTERNATE SITE 1 L HST NB TRACK BARRIER (SEE TPF, INTERLOCKING AND RADIO SJD-FRE - TOE OF FILL SITE PLANS; DRAWING CO-F1100-B) 5845+00--5860+00 5870 ± 00 5880+0 -€ HST SB TRACK TCE - TCE SJD-FRE -TOE OF FILL -ROADWAY R/W -AR FENCE -COYOTE ROAD REALIGNMENT (SEE CIVIL AND GRADE -HST R/W SEPARATION PLANS; DRAWINGS CV-R1090-B TO CV-R1091-B) SR 152 REALIGNMENT AT SR 59 -(SEE DRAWINGS CV-R1100-B TO CV-R1103-B) TCE -ROADWAY R/W TOE OF FILL




SR

152/SR 59" LINE

"EB_OFF_RAMP" LINE

MERCED COUNTY

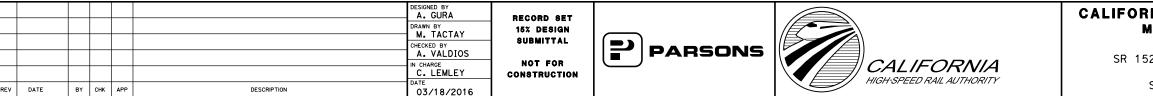

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S1090-


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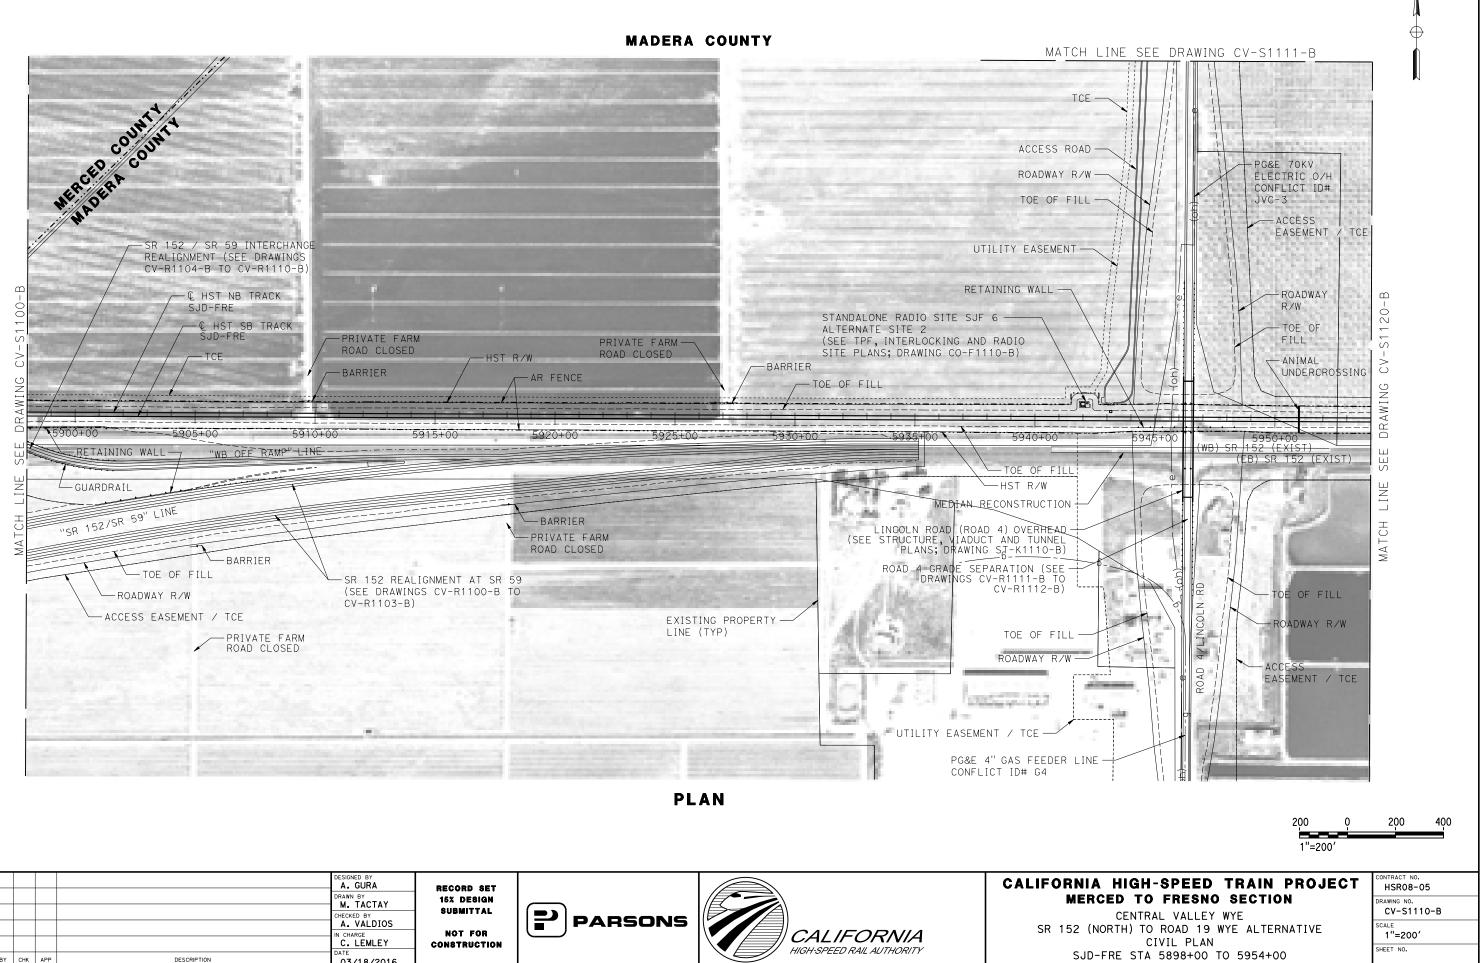
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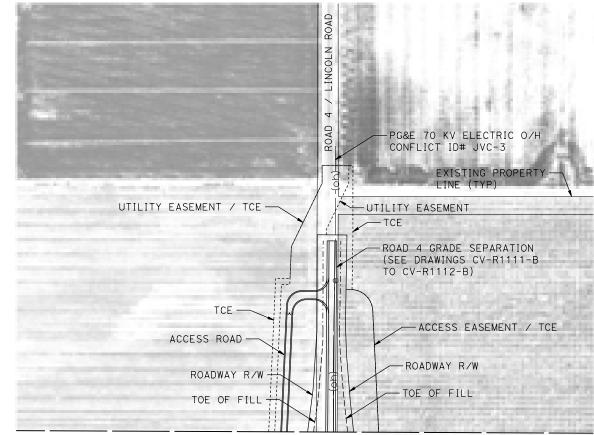
MATCH





		DESIGNED BY A. GURA DRAWN BY M. TACTAY CHECKED BY	RECORD SET 15% design Submittal			CALIFOR
REV DATE BY CHK	APP DESCRIPTION	A. VALDIOS IN CHARGE C. LEMLEY DATE 03/18/2016	NOT FOR Construction	PARSONS	CALIFORNIA HIGH-SPEED RAIL AUTHORITY	SR 15

MΑ

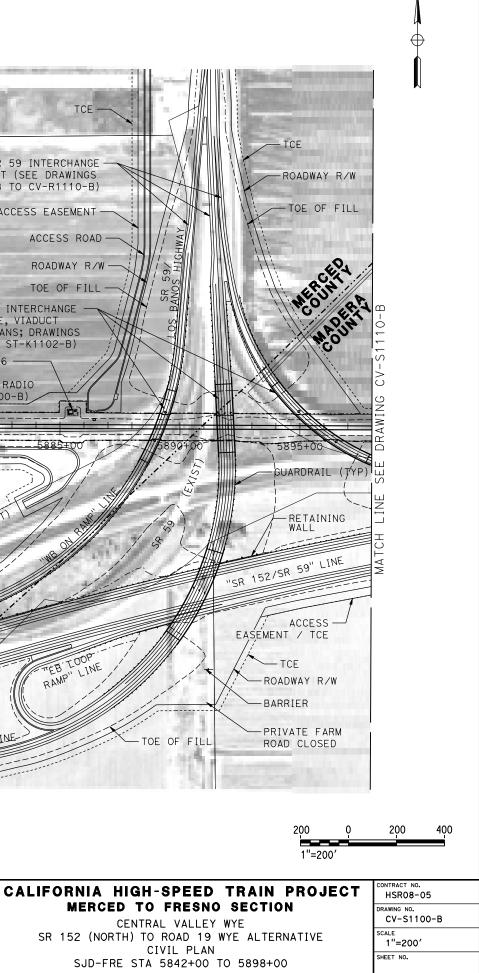


MADERA COUNTY

MATCH LINE SEE DRAWING CV-S1110-B




			PLAN	200 0 1"=200'	200 400
	DESIGNED BY A. GURA DRAWN BY M. TACTAY CHECKED BY CHECKED BY DESIGN SUBMITTAL			CALIFORNIA HIGH-SPEED TRAIN PROJECT MERCED TO FRESNO SECTION CENTRAL VALLEY WYE	CONTRACT NO. HSR08-05 DRAWING NO. CV-S1111-B
REV DATE BY CHK APP DESCRIPTION	A. VALDIOS IN CHARGE C. LEMLEY DATE 03/18/2016	PARSONS	CALIFORNIA HIGH-SPEED RAIL AUTHORITY	SR 152 (NORTH) TO ROAD 19 WYE ALTERNATIVE CIVIL PLAN SJD-FRE ACCESS ROAD	SCALE 1"=200' SHEET NO.


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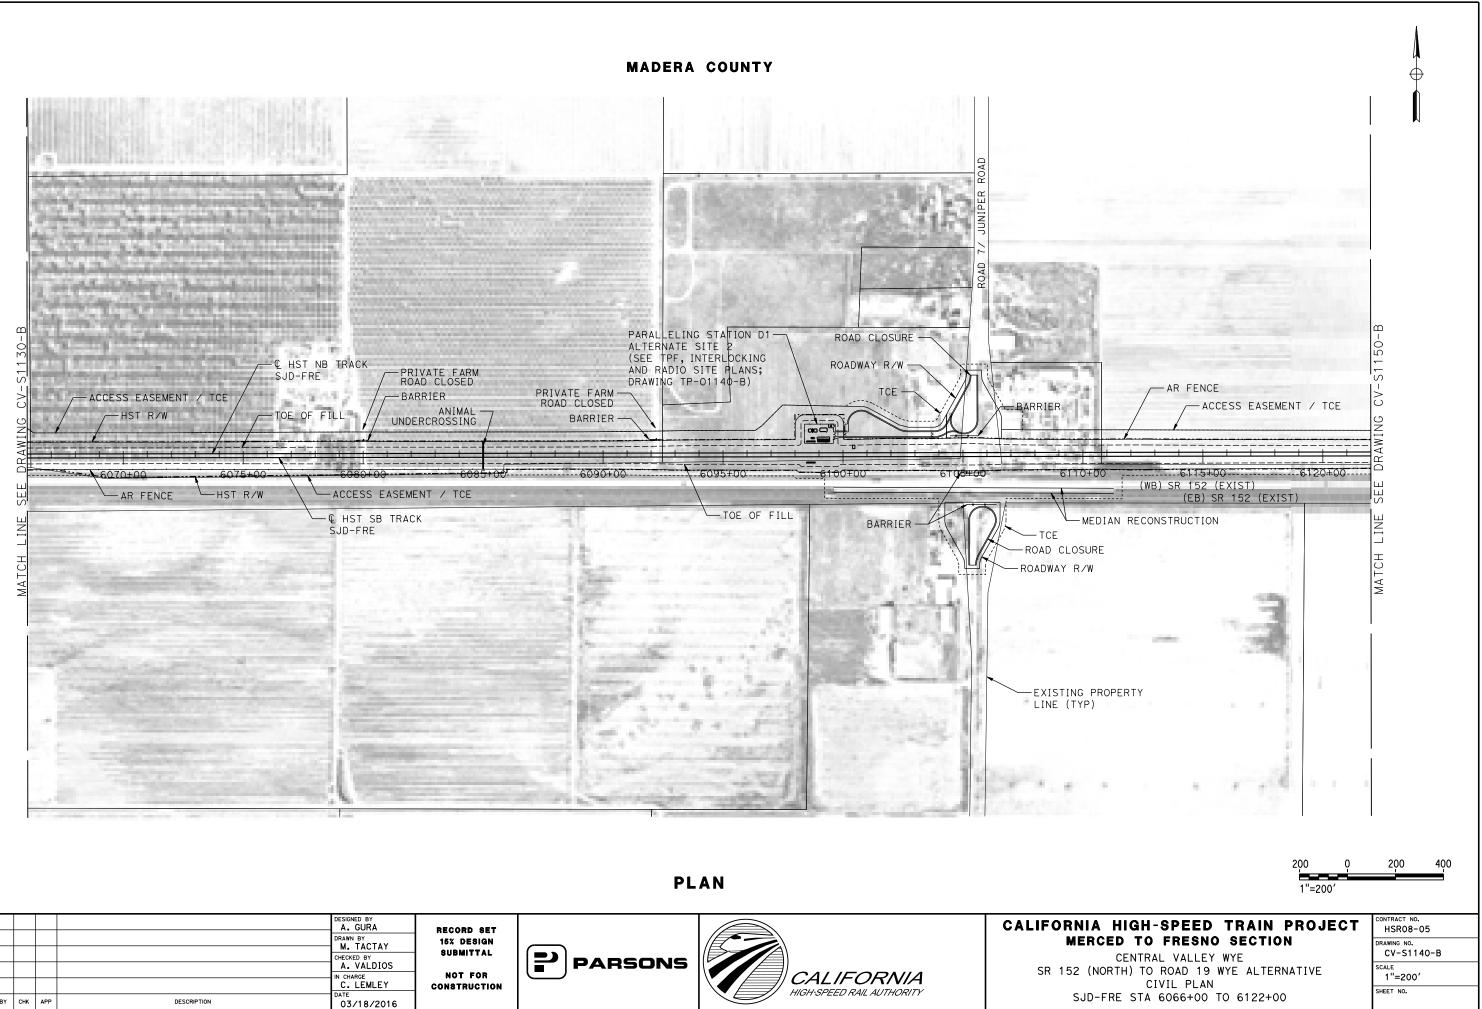


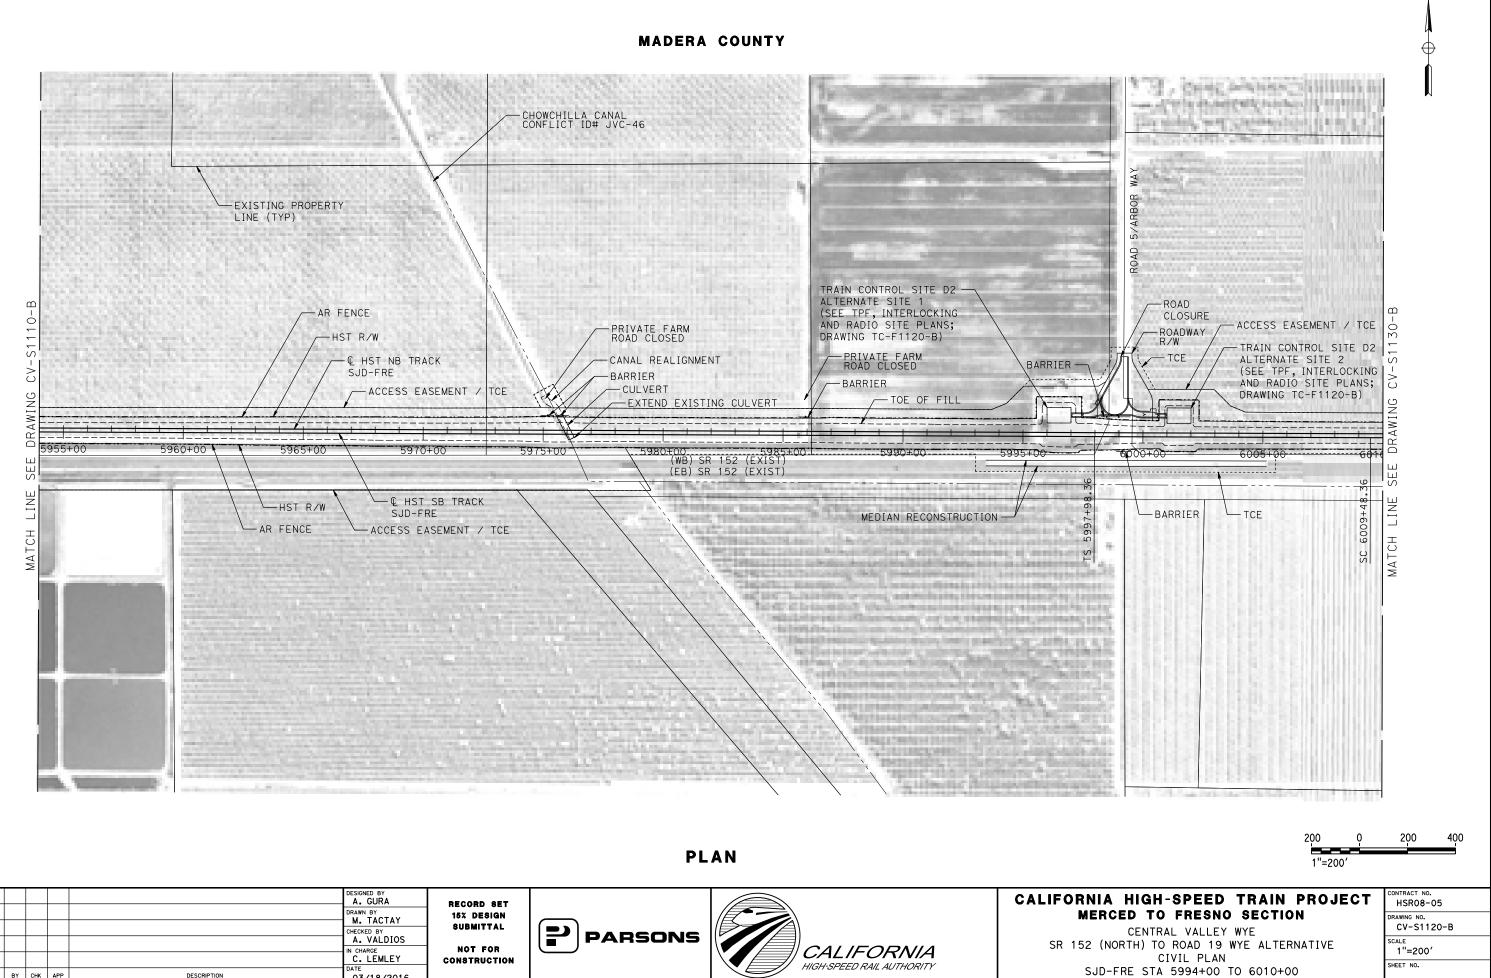
				DESIGNED BY A. GURA DRAWN BY M. TACTAY	RECORD SET 15% Design		CALIFORI M
				CHECKED BY A. VALDIOS	SUBMITTAL Not for	PARSONS	SR 152
REV DATE	BY	СНК АРР	DESCRIPTION	C. LEMLEY DATE 03/18/2016	CONSTRUCTION		S




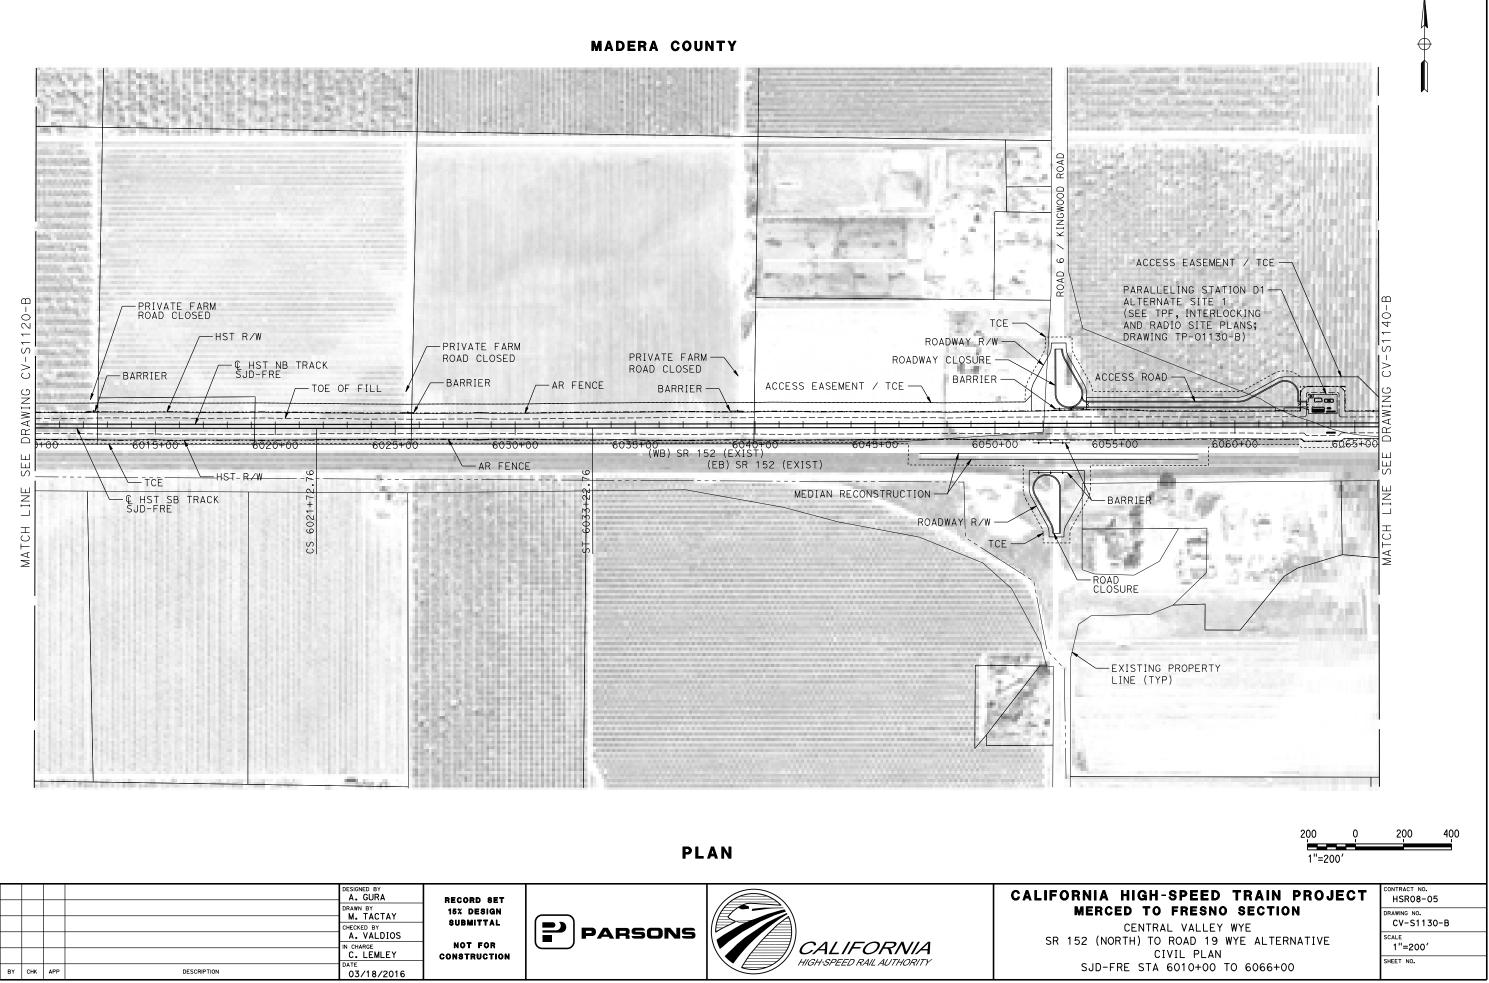




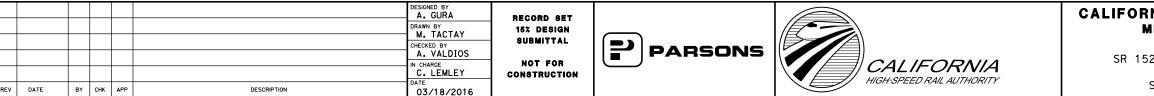


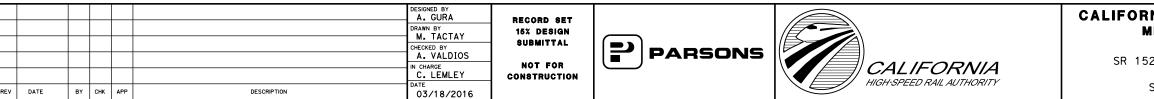


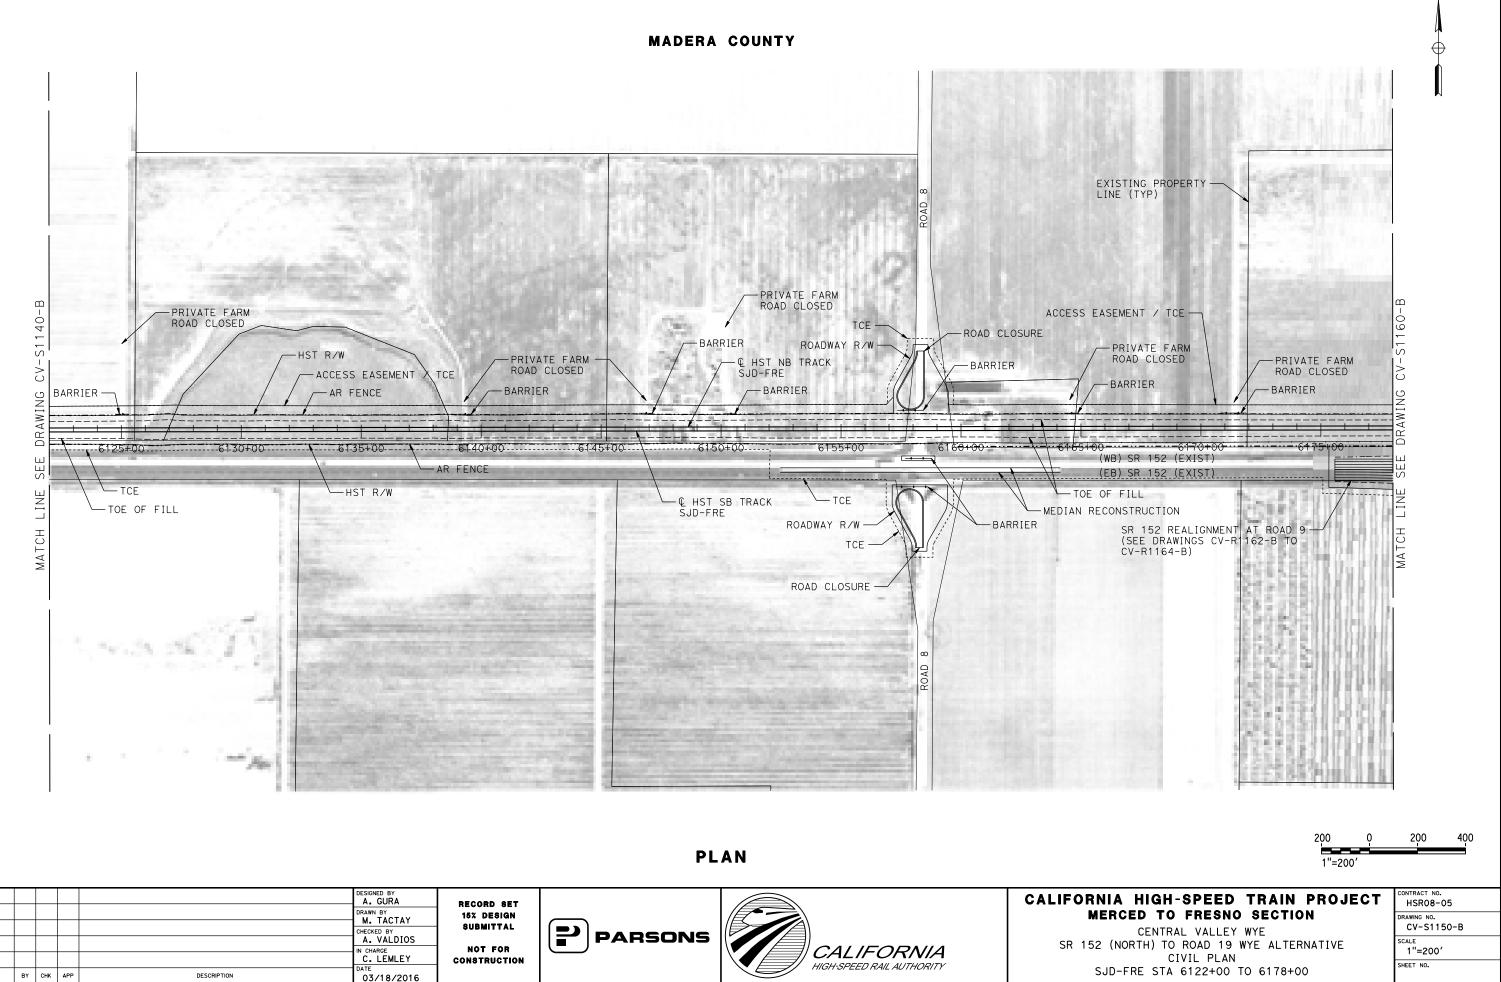




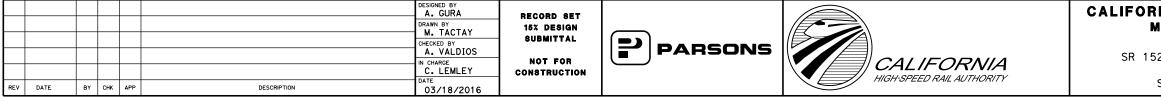

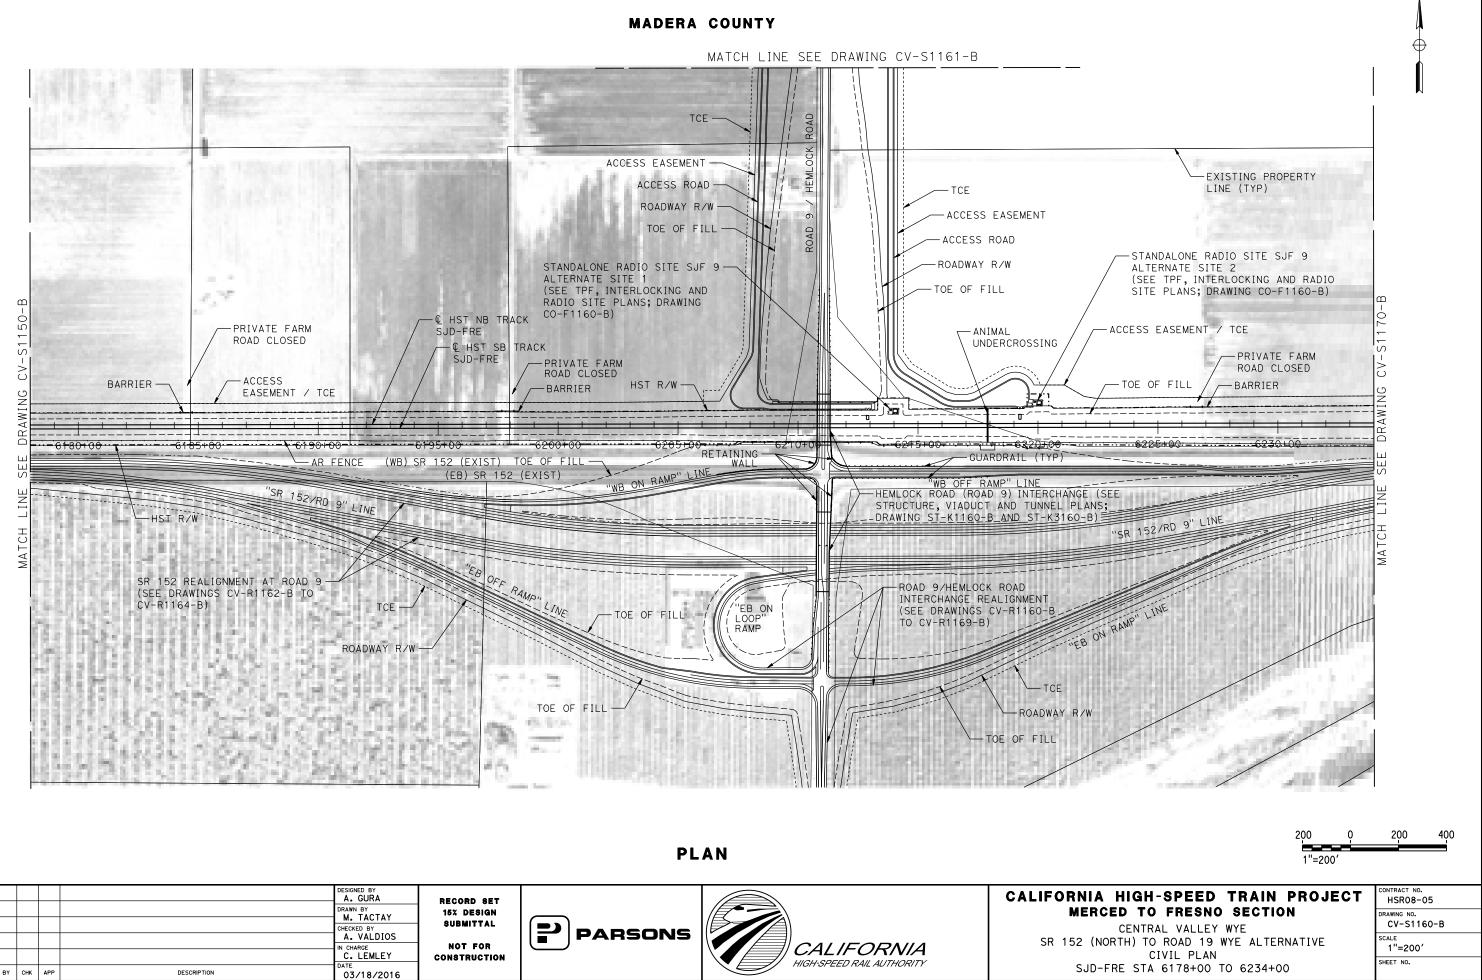

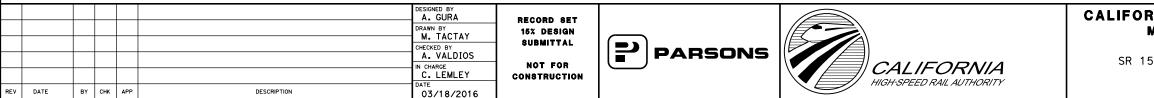



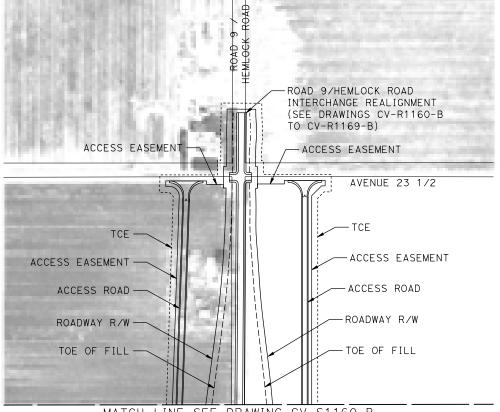


MATCH LINE SEE DRAWING CV-S1160-B




0 200 400

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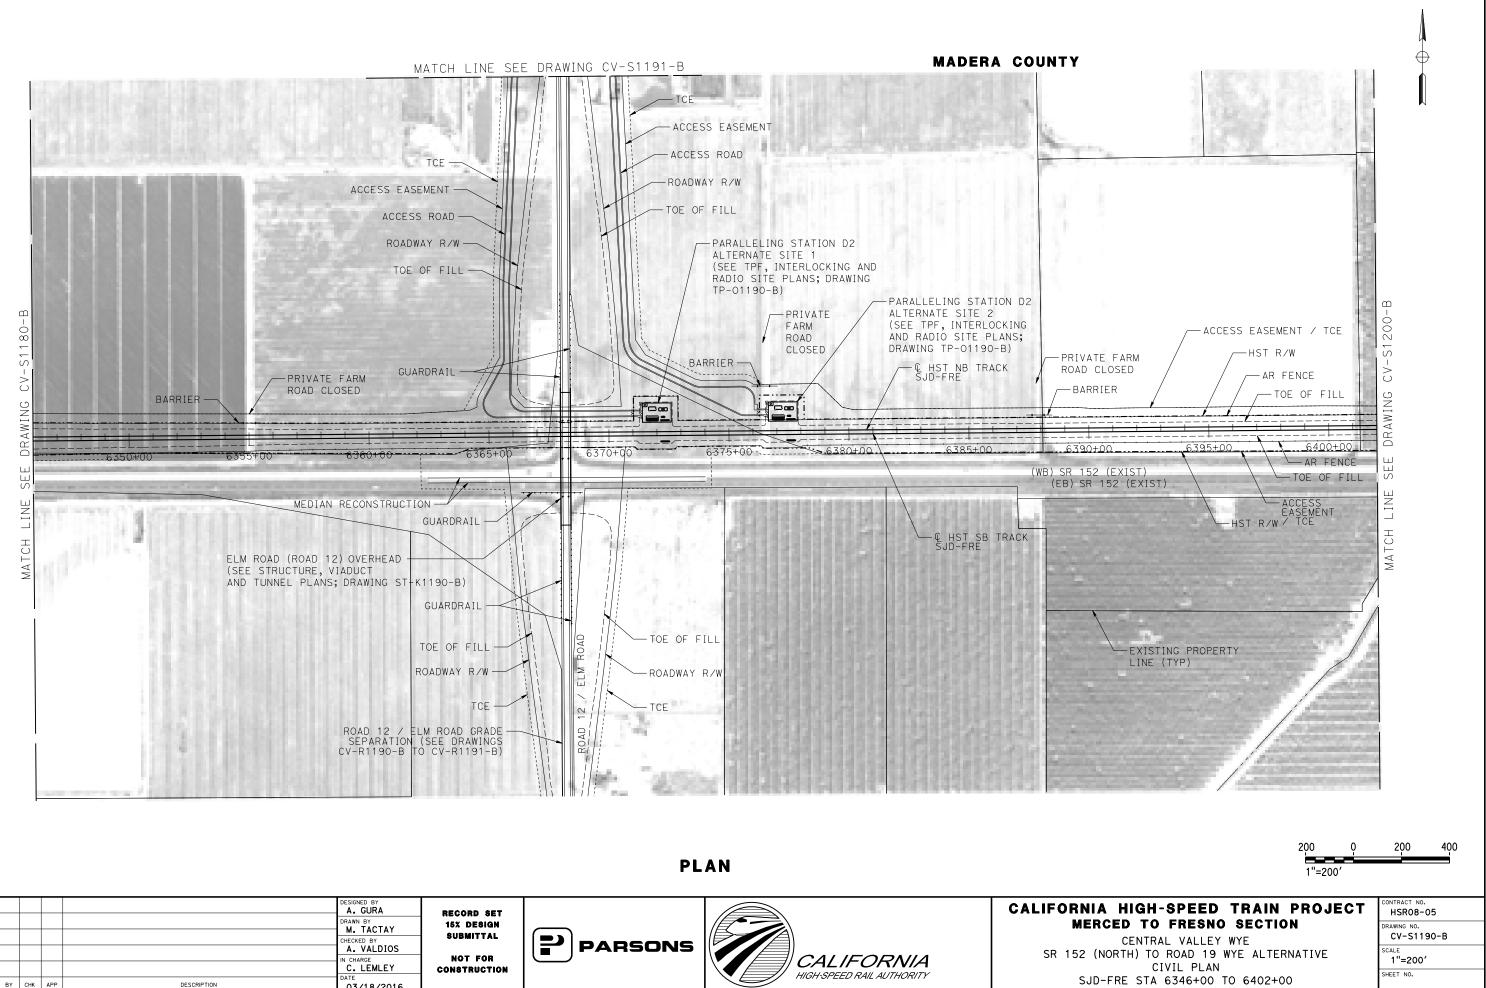
							PLAN	1"=200′	
				DESIGNED BY A. GURA DRAWN BY M. TACTAY CHECKED BY A. VALDIOS IN CHARGE C. LEMLEY	RECORD SET 15% design Submittal Not for Construction	PARSONS		CALIFORNIA HIGH-SPEED TRAIN PROJECT MERCED TO FRESNO SECTION CENTRAL VALLEY WYE SR 152 (NORTH) TO ROAD 19 WYE ALTERNATIVE CIVIL PLAN	CONTRACT NO. HSR08-05 DRAWING NO. CV-S1161-B SCALE 1"=200'
REV DATE	вү снк	APP	DESCRIPTION	DATE 03/18/2016	CONSTRUCTION		HIGH-SPEED RAIL AUTHORITY	SJD-FRE ACCESS ROAD	SHEET NO.

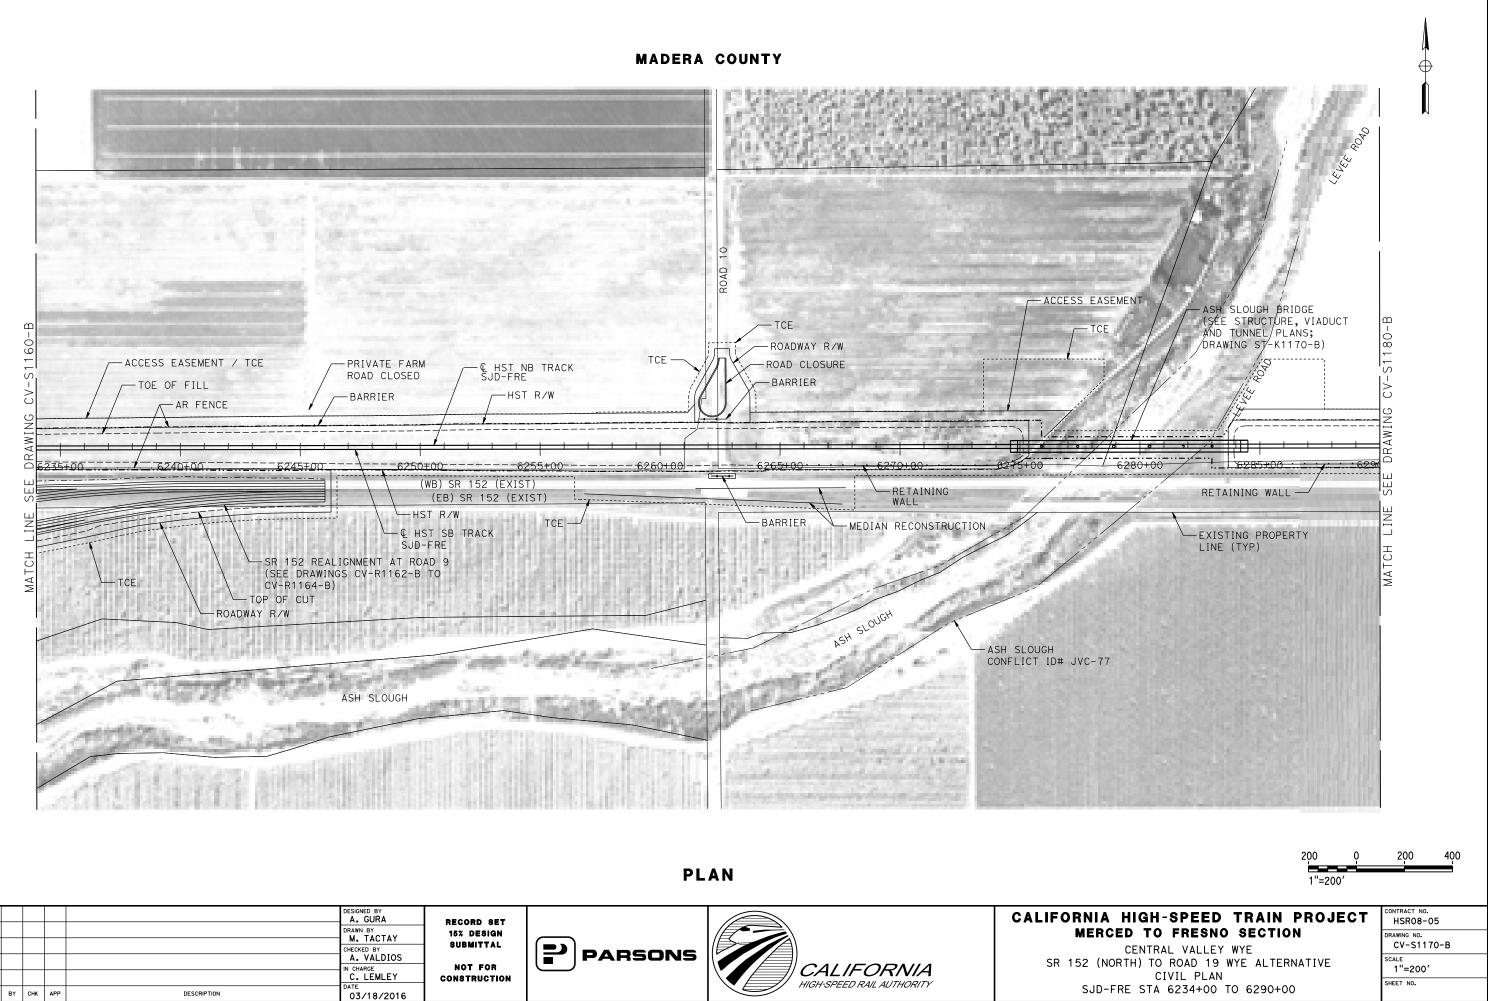


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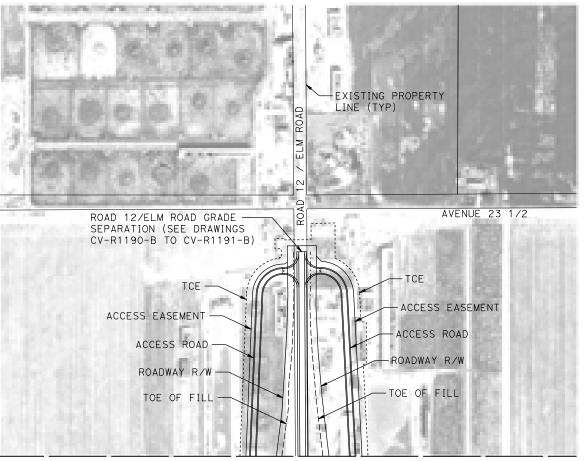
REV DATE ВҮ СНК АРР 03/18/2016



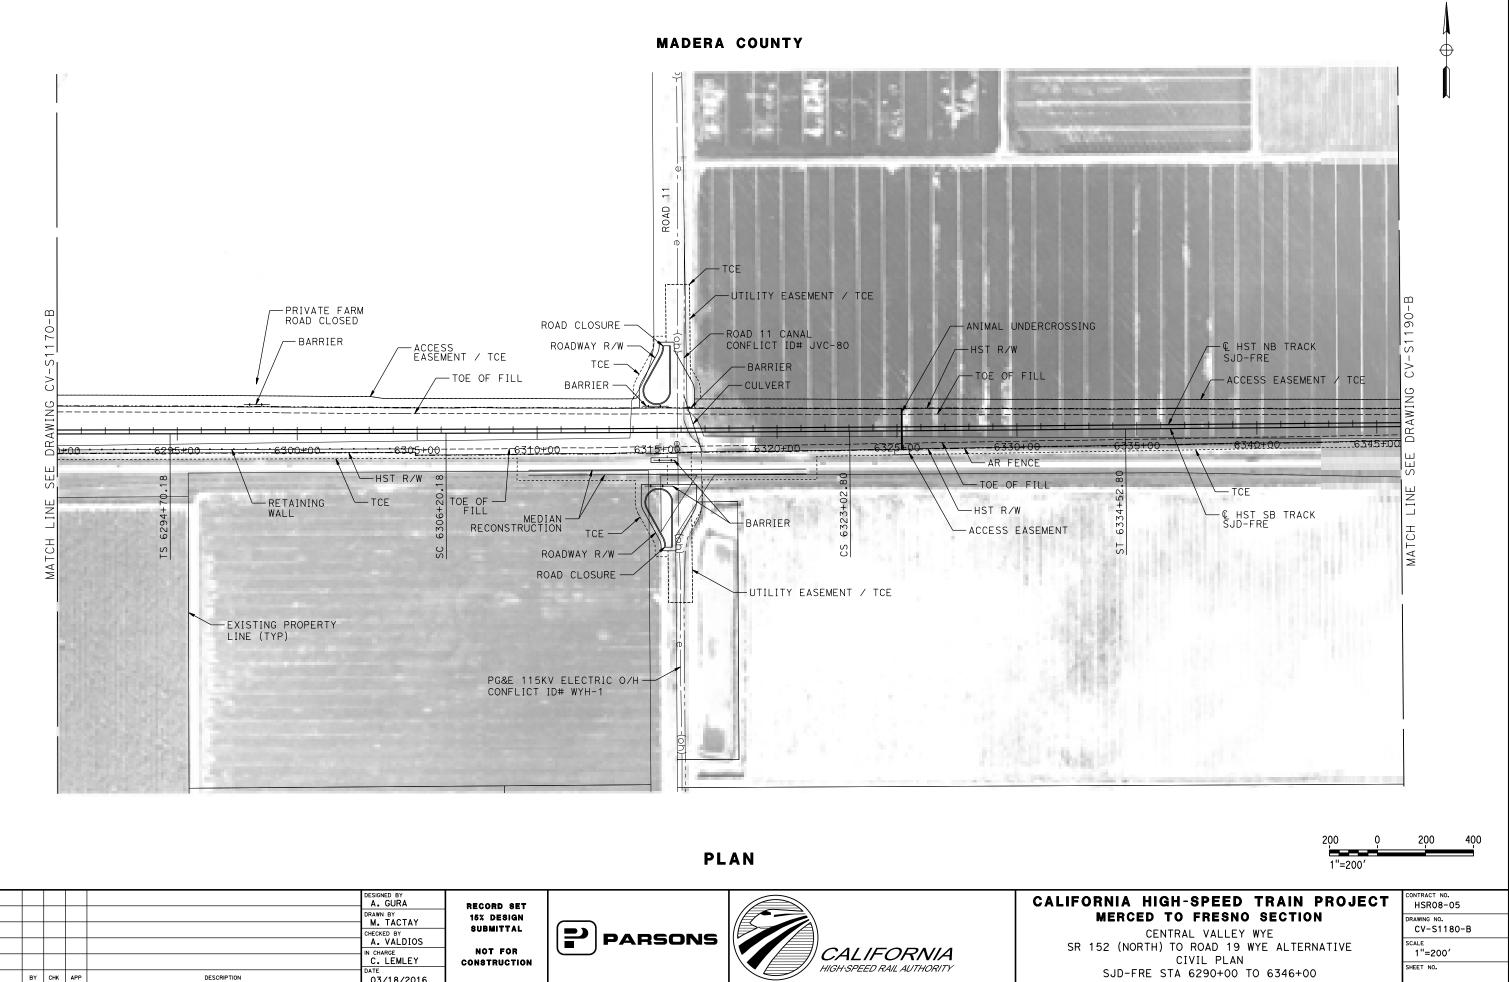



MADERA COUNTY

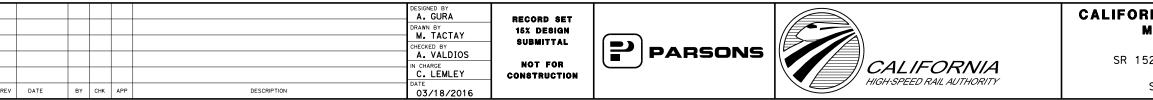


MATCH LINE SEE DRAWING CV-S1190-B



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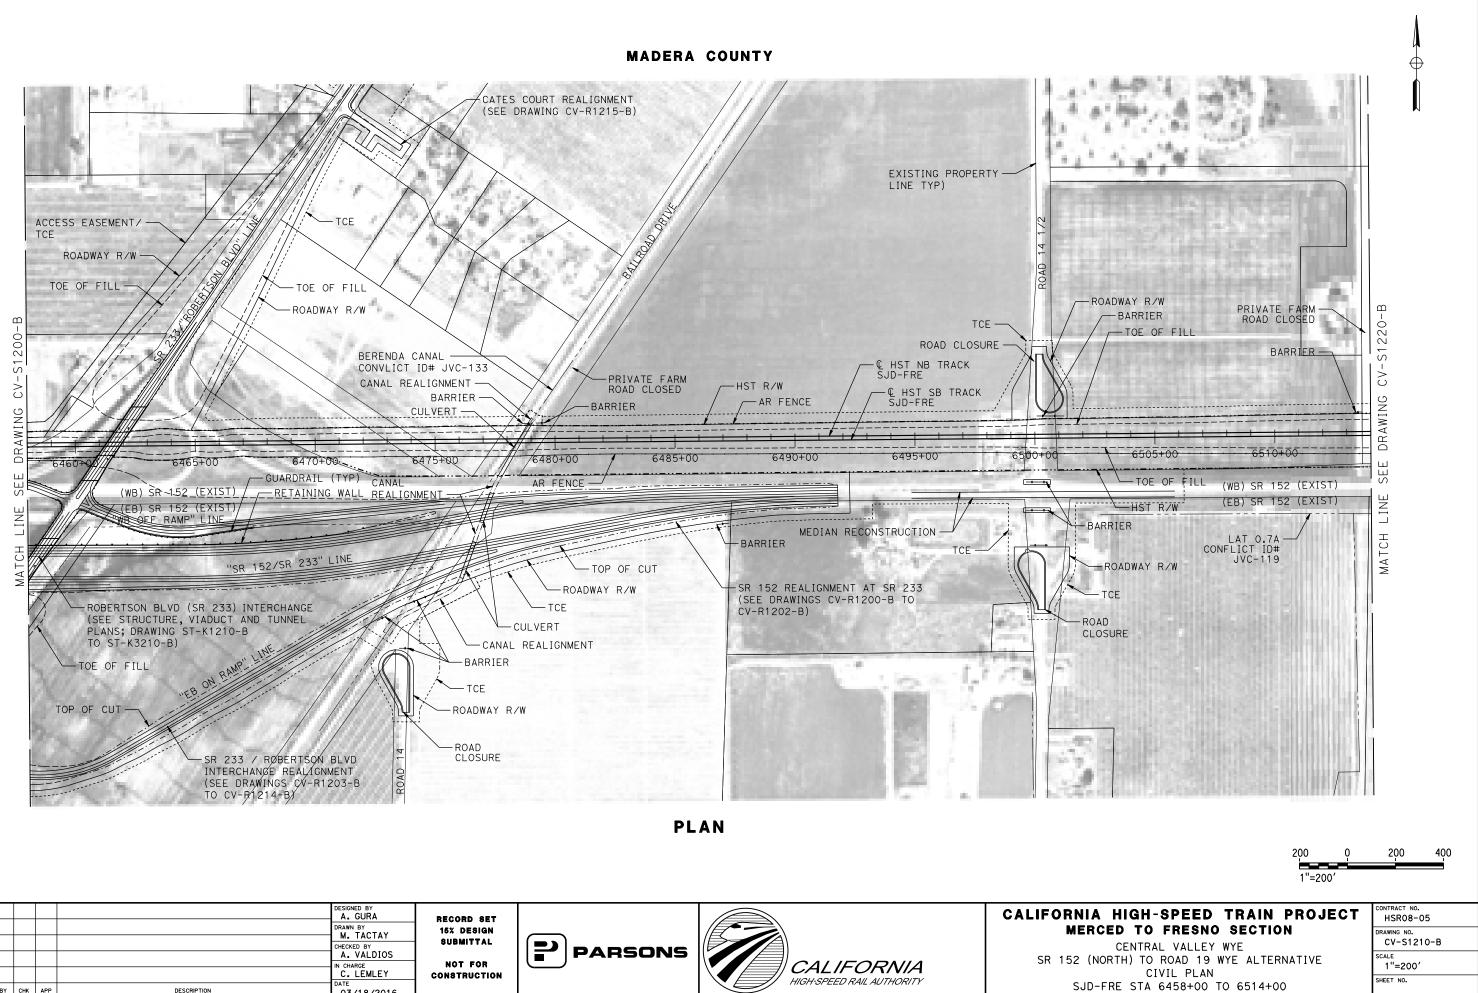
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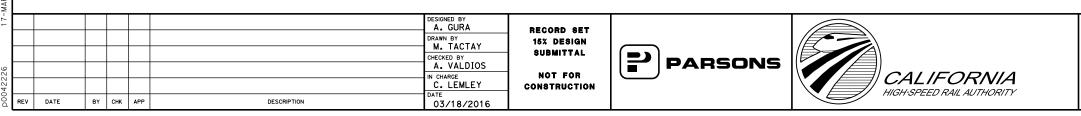
							1"=200′	
			DESIGNED BY A. GURA	RECORD SET			CALIFORNIA HIGH-SPEED TRAIN PROJECT	CONTRACT NO. HSR08-05
			DRAWN BY M. TACTAY CHECKED BY	15% DESIGN Submittal	PARSONS		MERCED TO FRESNO SECTION CENTRAL VALLEY WYE	DRAWING NO. CV-S1191-B
			A. VALDIOS	NOT FOR Construction	PARSONS		SR 152 (NORTH) TO ROAD 19 WYE ALTERNATIVE CIVIL PLAN	SCALE 1"=200'
V DATE	BY CHK APP	DESCRIPTION	DATE 03/18/2016			HIGH-SPEED RAIL AUTHORITY	SJD-FRE ACCESS ROAD	SHEET NO.




16-MAR-201610:28 MF-CV

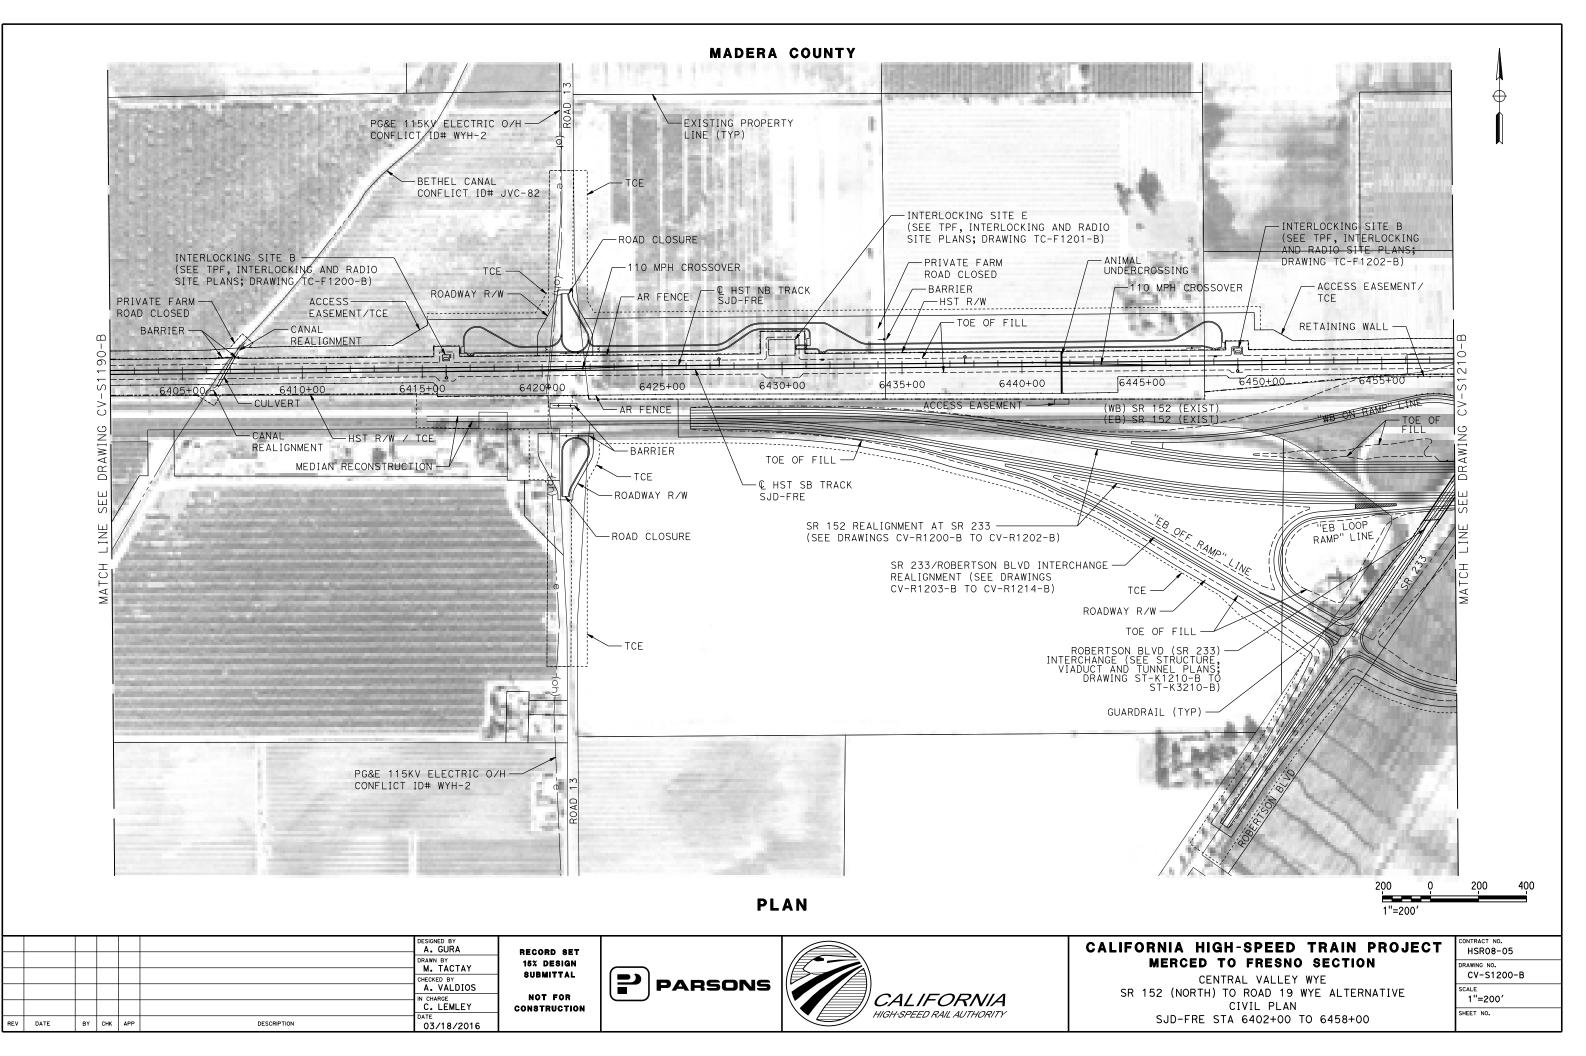
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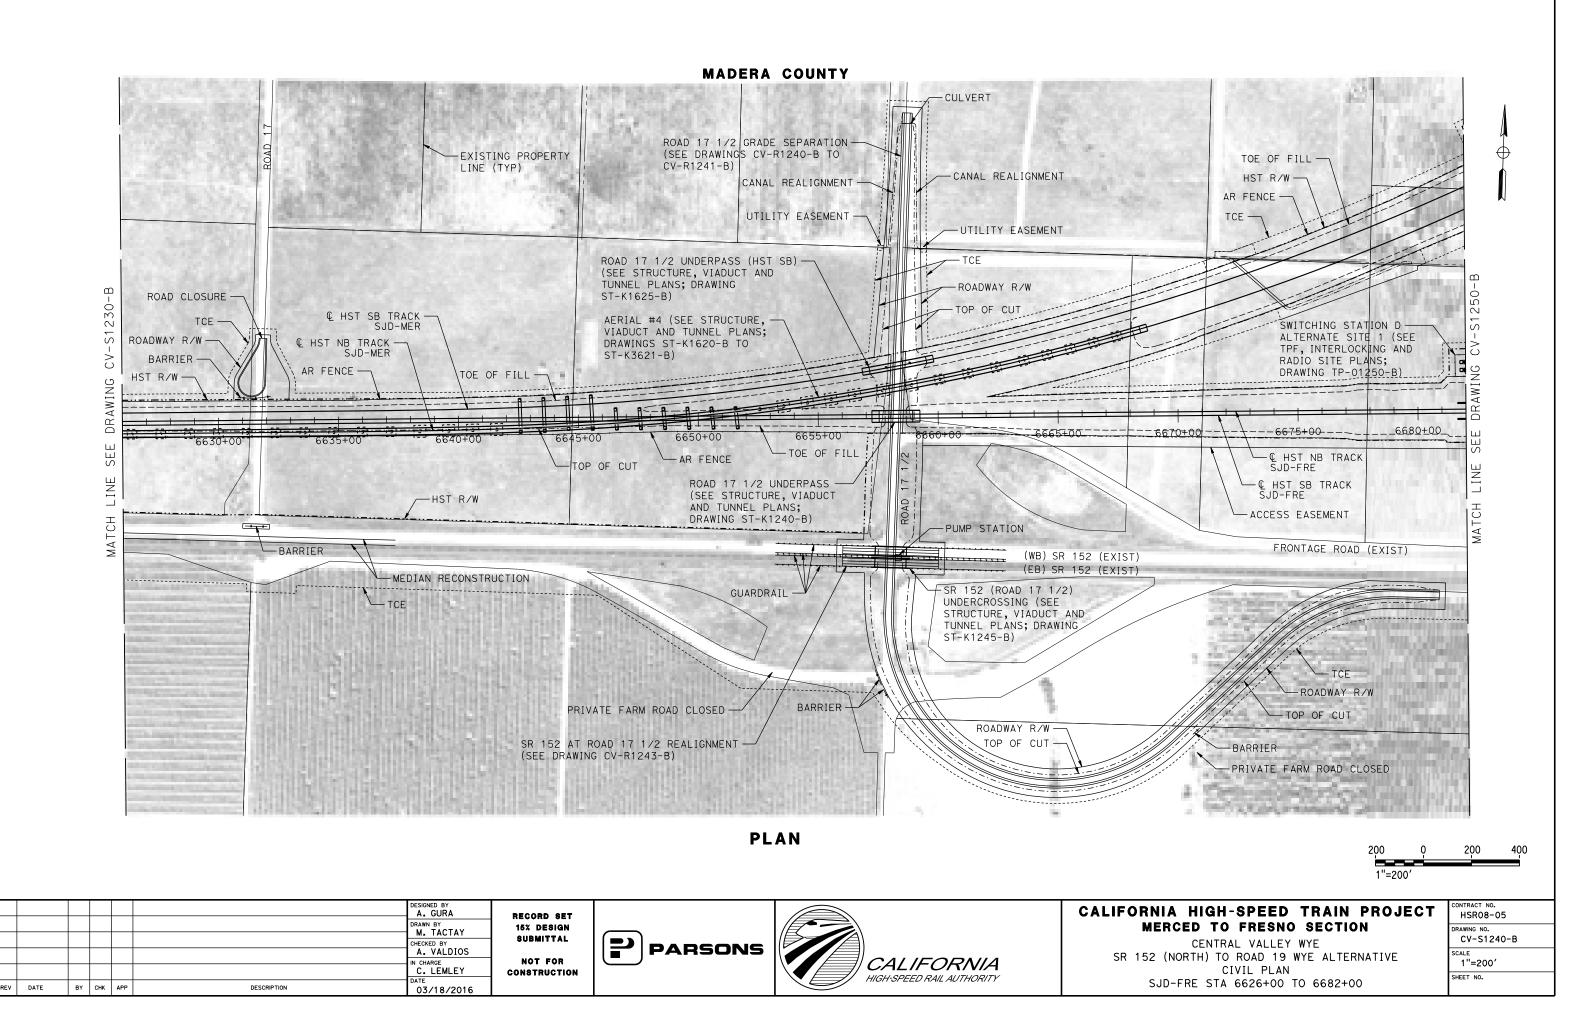





HIGH-SPEED RAIL AUTHORITY REV DATE BY CHK APP DESCRIPTION 03/18/2016

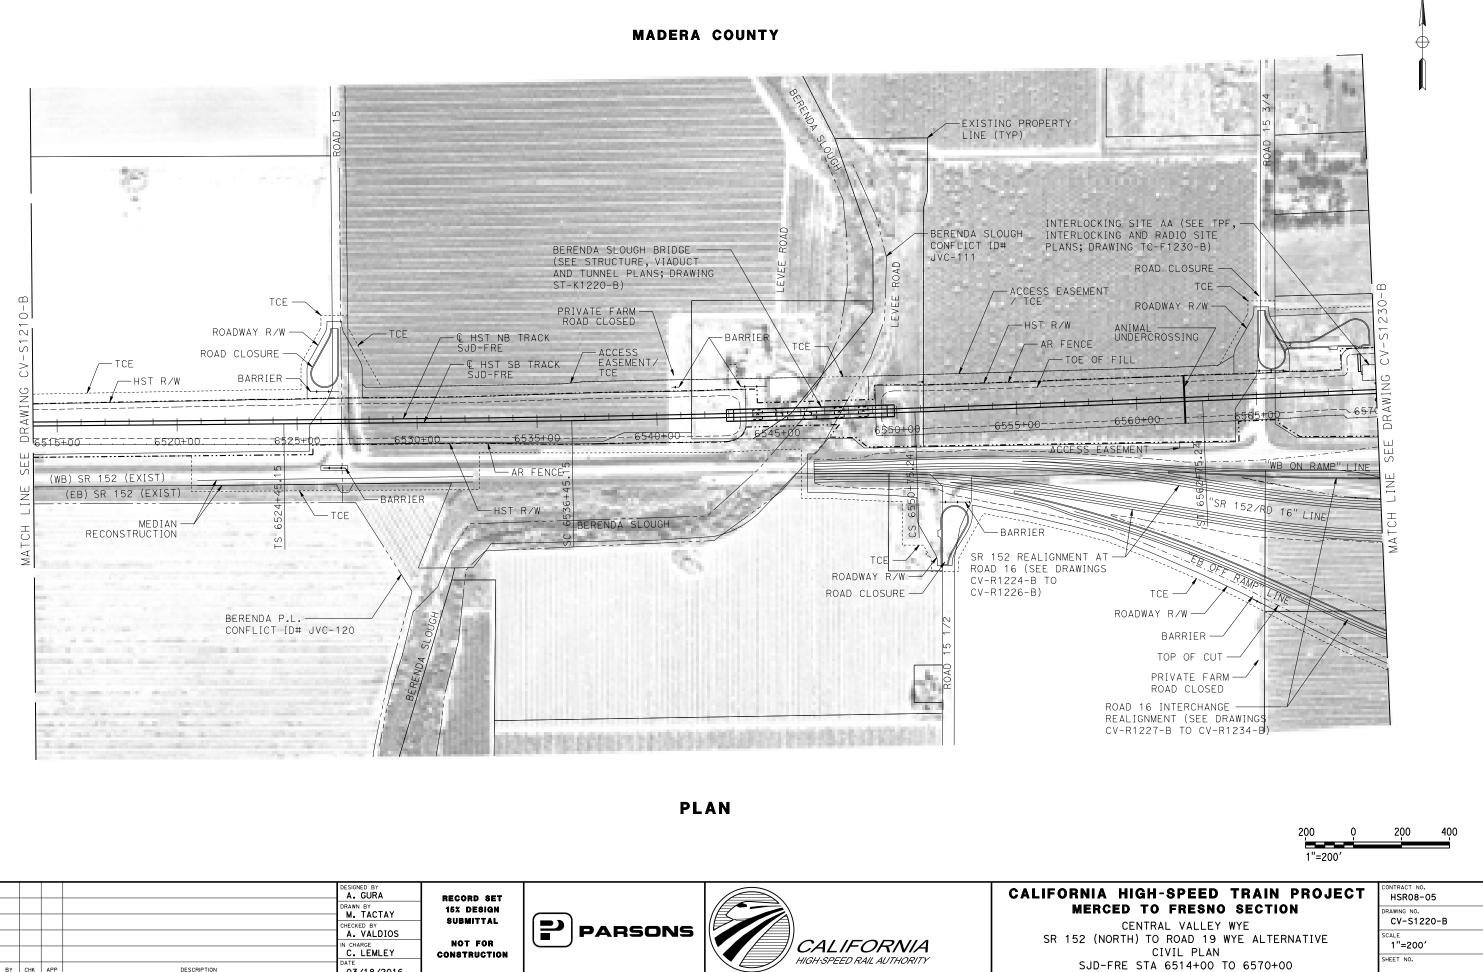

07-SEP-201610:23 MF-CV-S123

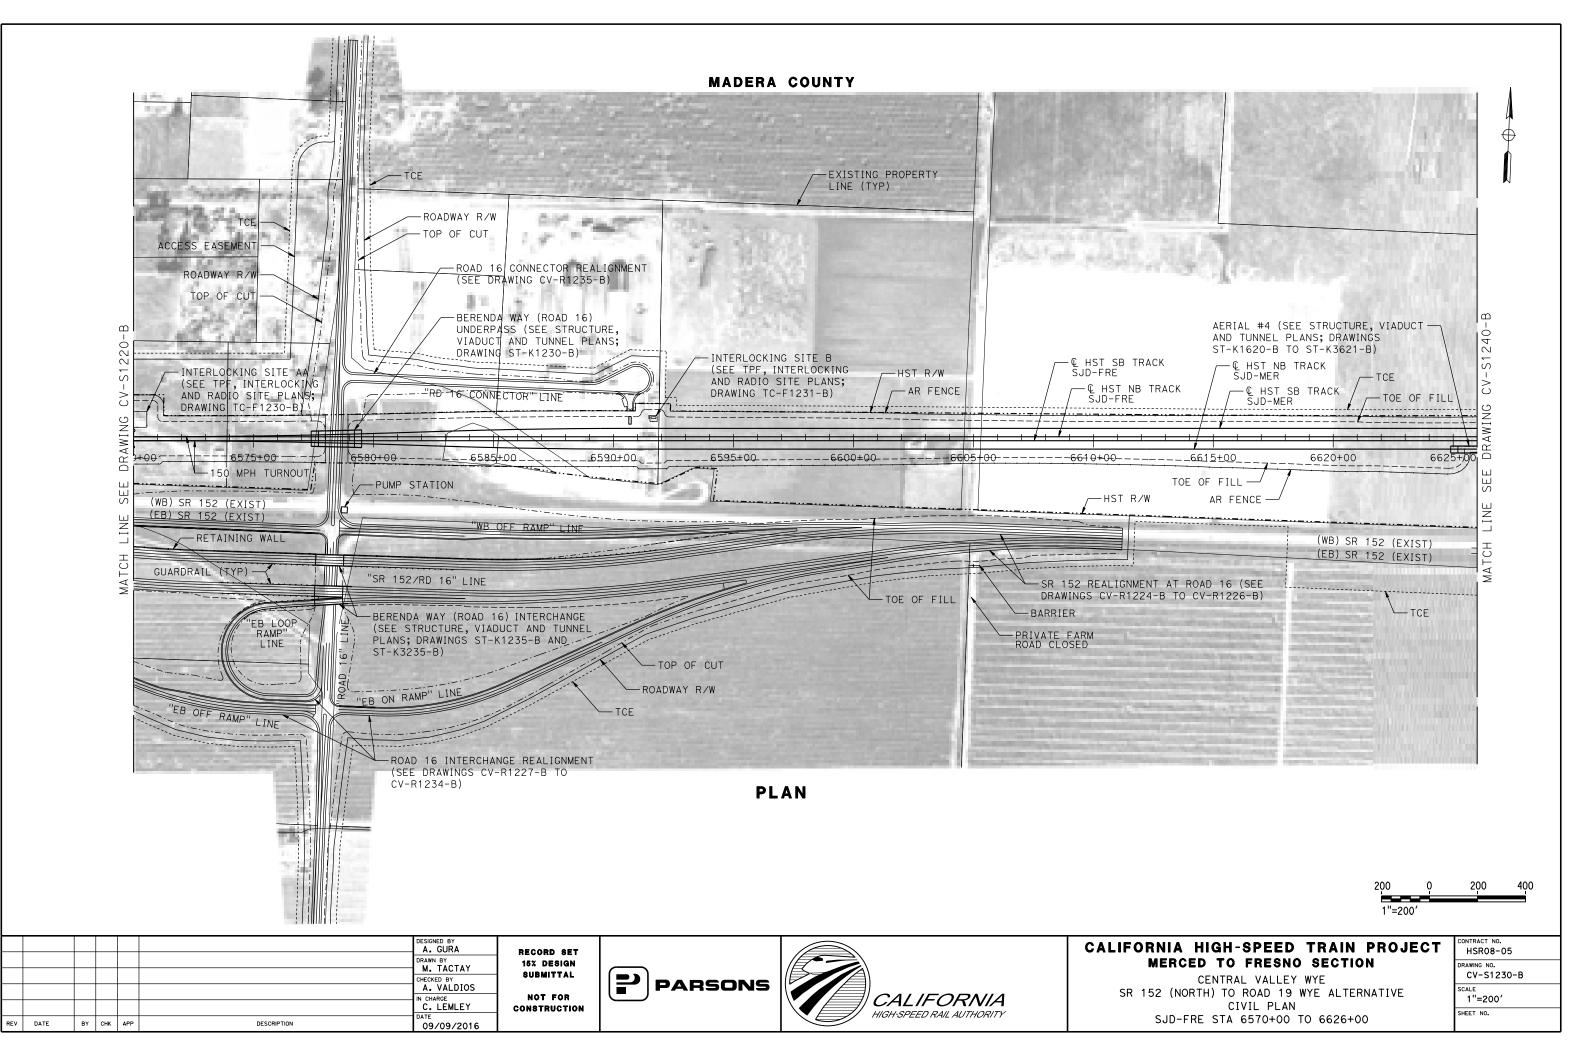


MADERA COUNTY

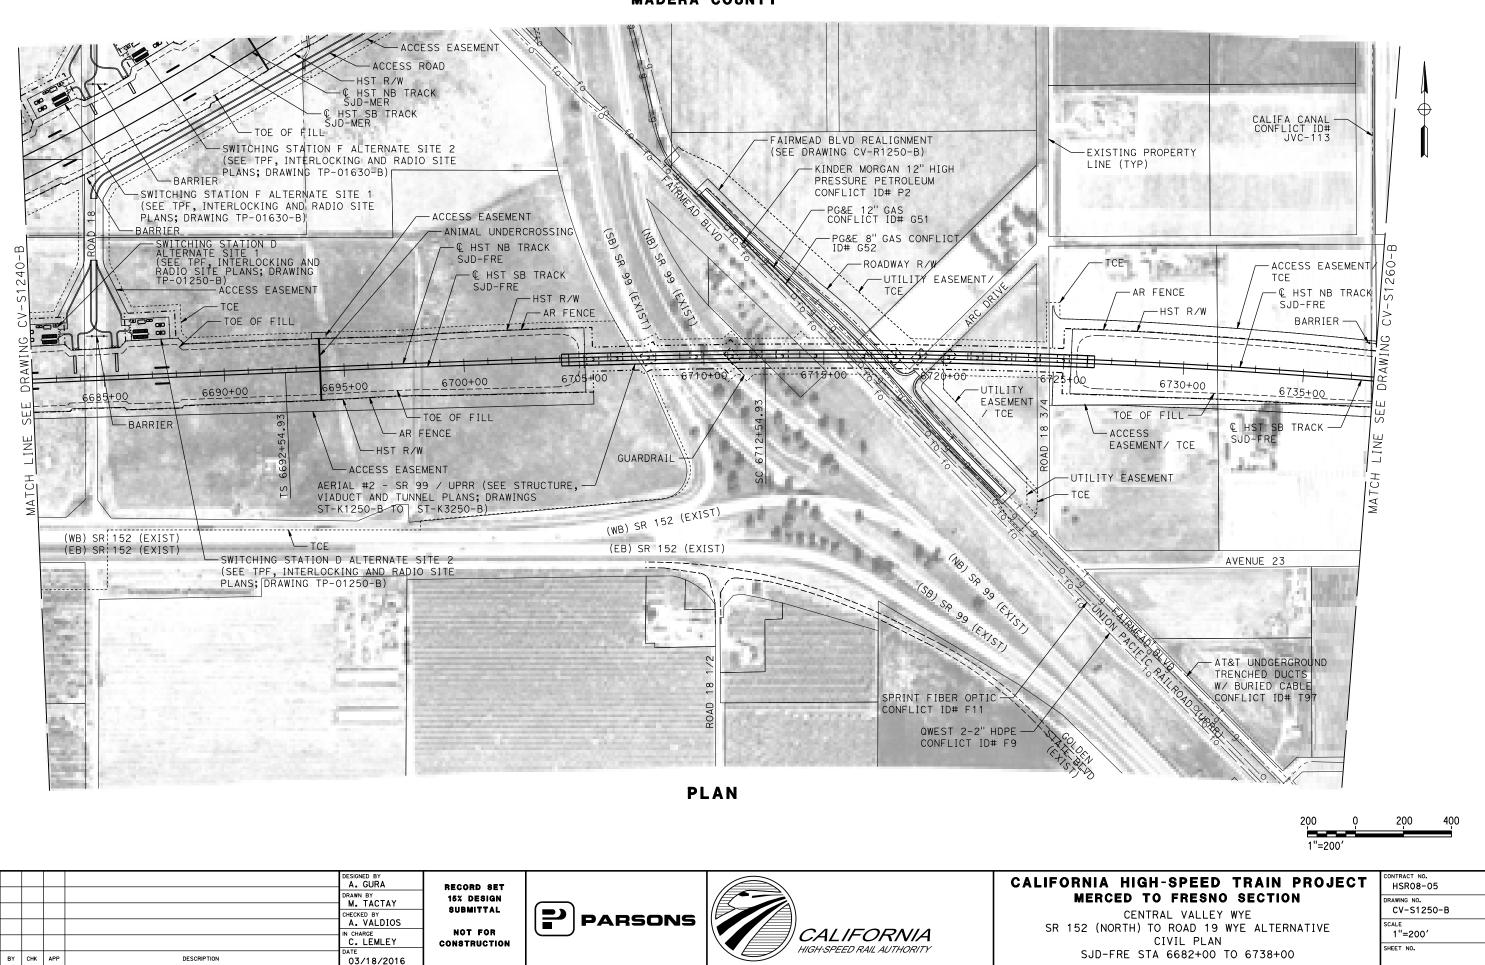


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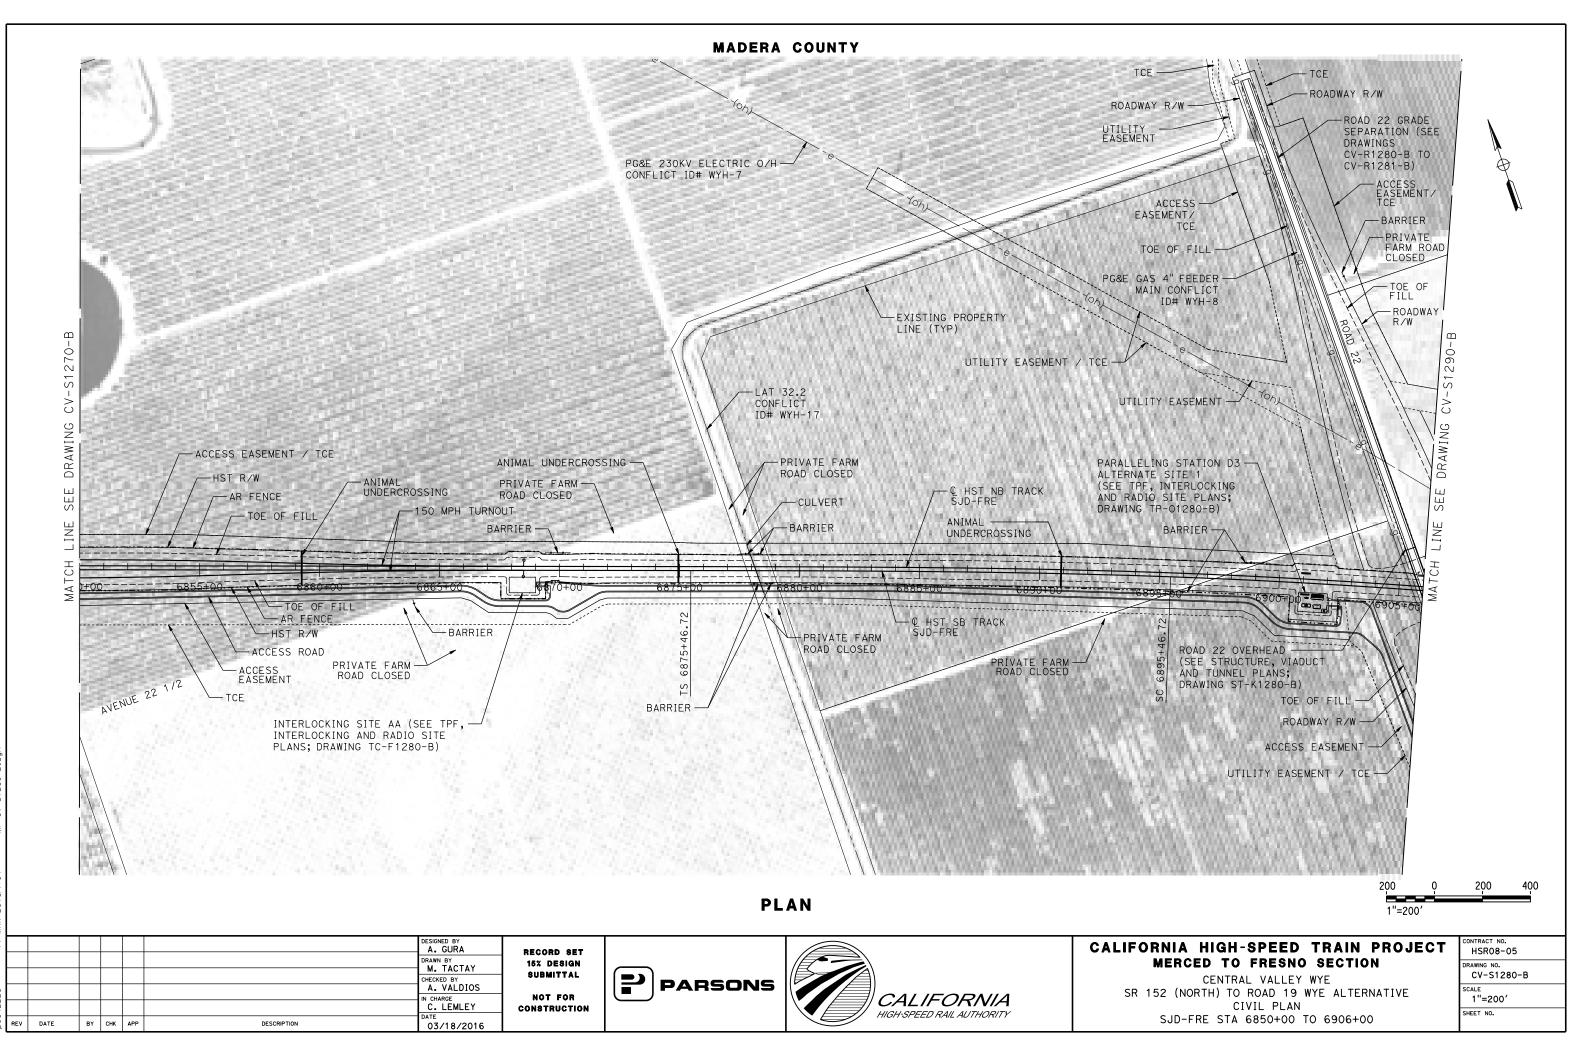
MADERA COUNTY

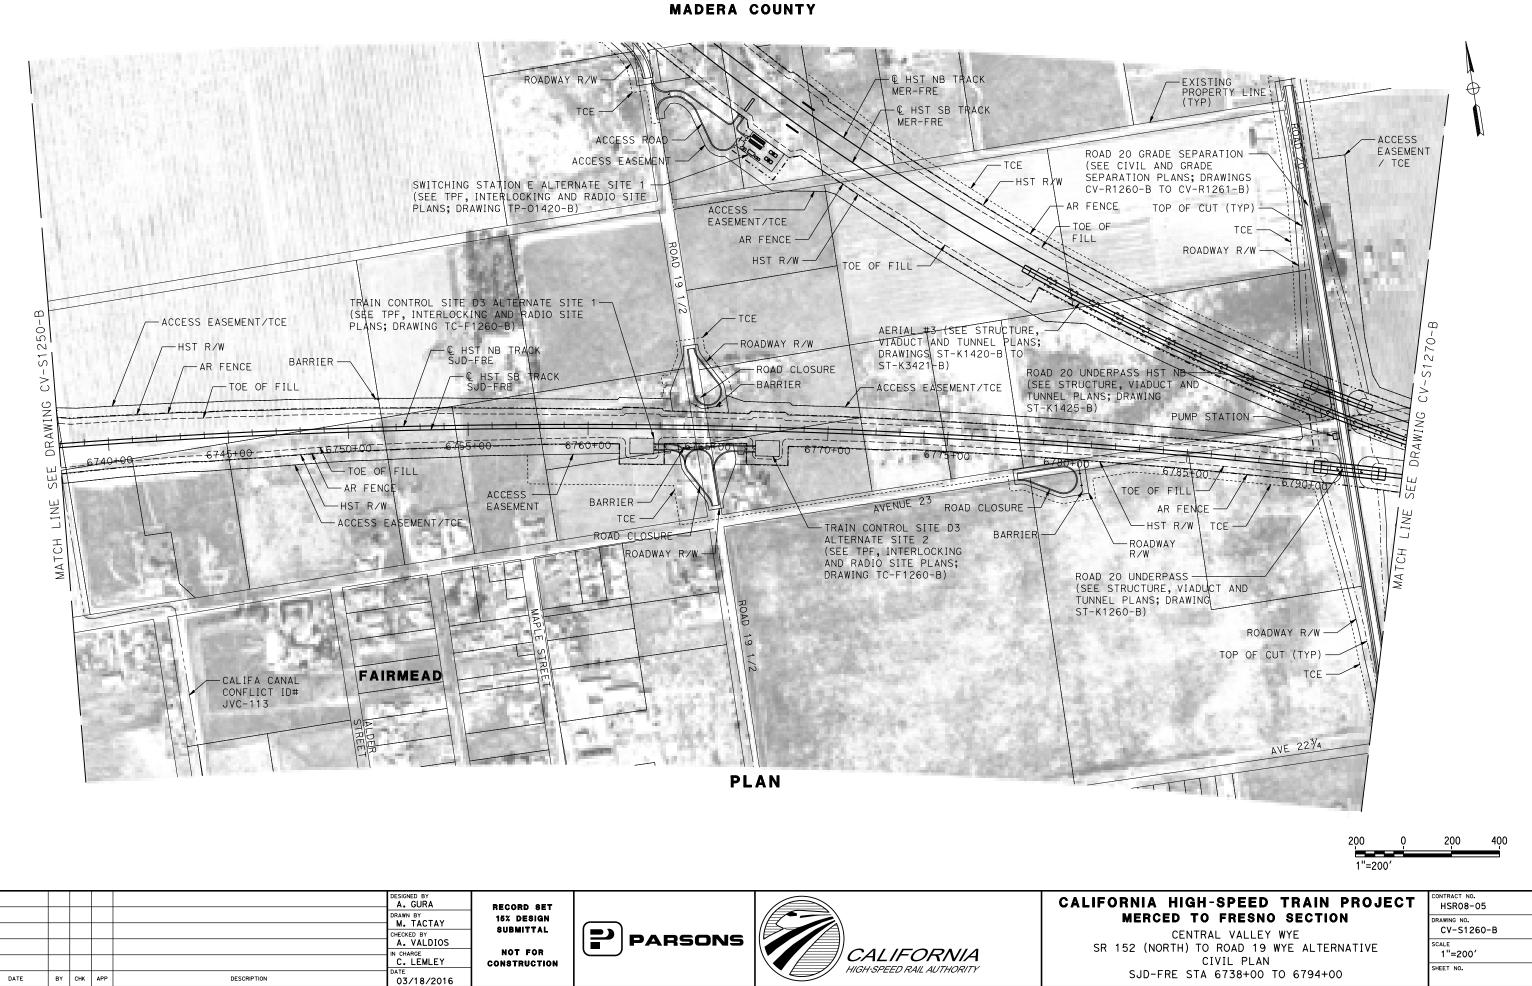

REV

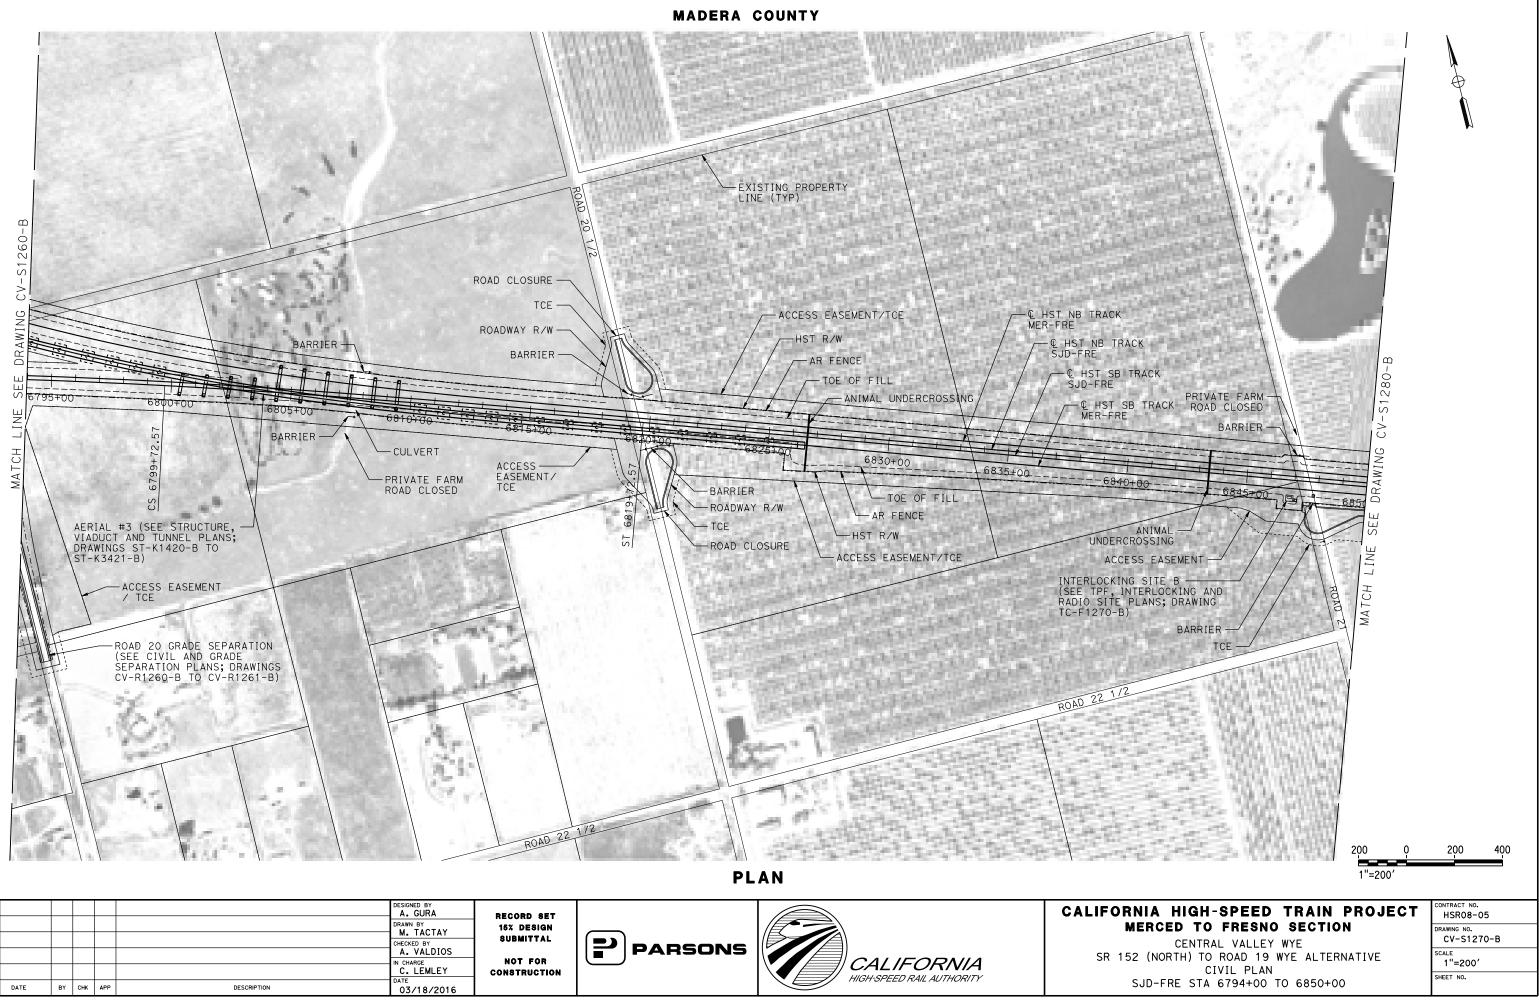


					 A. GURA	RECORD SET		CAL
					DRAWN BY M. TACTAY	15% DESIGN		
					 CHECKED BY A. VALDIOS	SUBMITTAL		
					IN CHARGE C. LEMLEY	NOT FOR Construction	CALIFORNIA HIGH-SPEED RAIL AUTHORITY	
REV	DATE	BY	снк	APP	DATE 03/18/2016		HIGH SPEED RAIL AUTHORITY	





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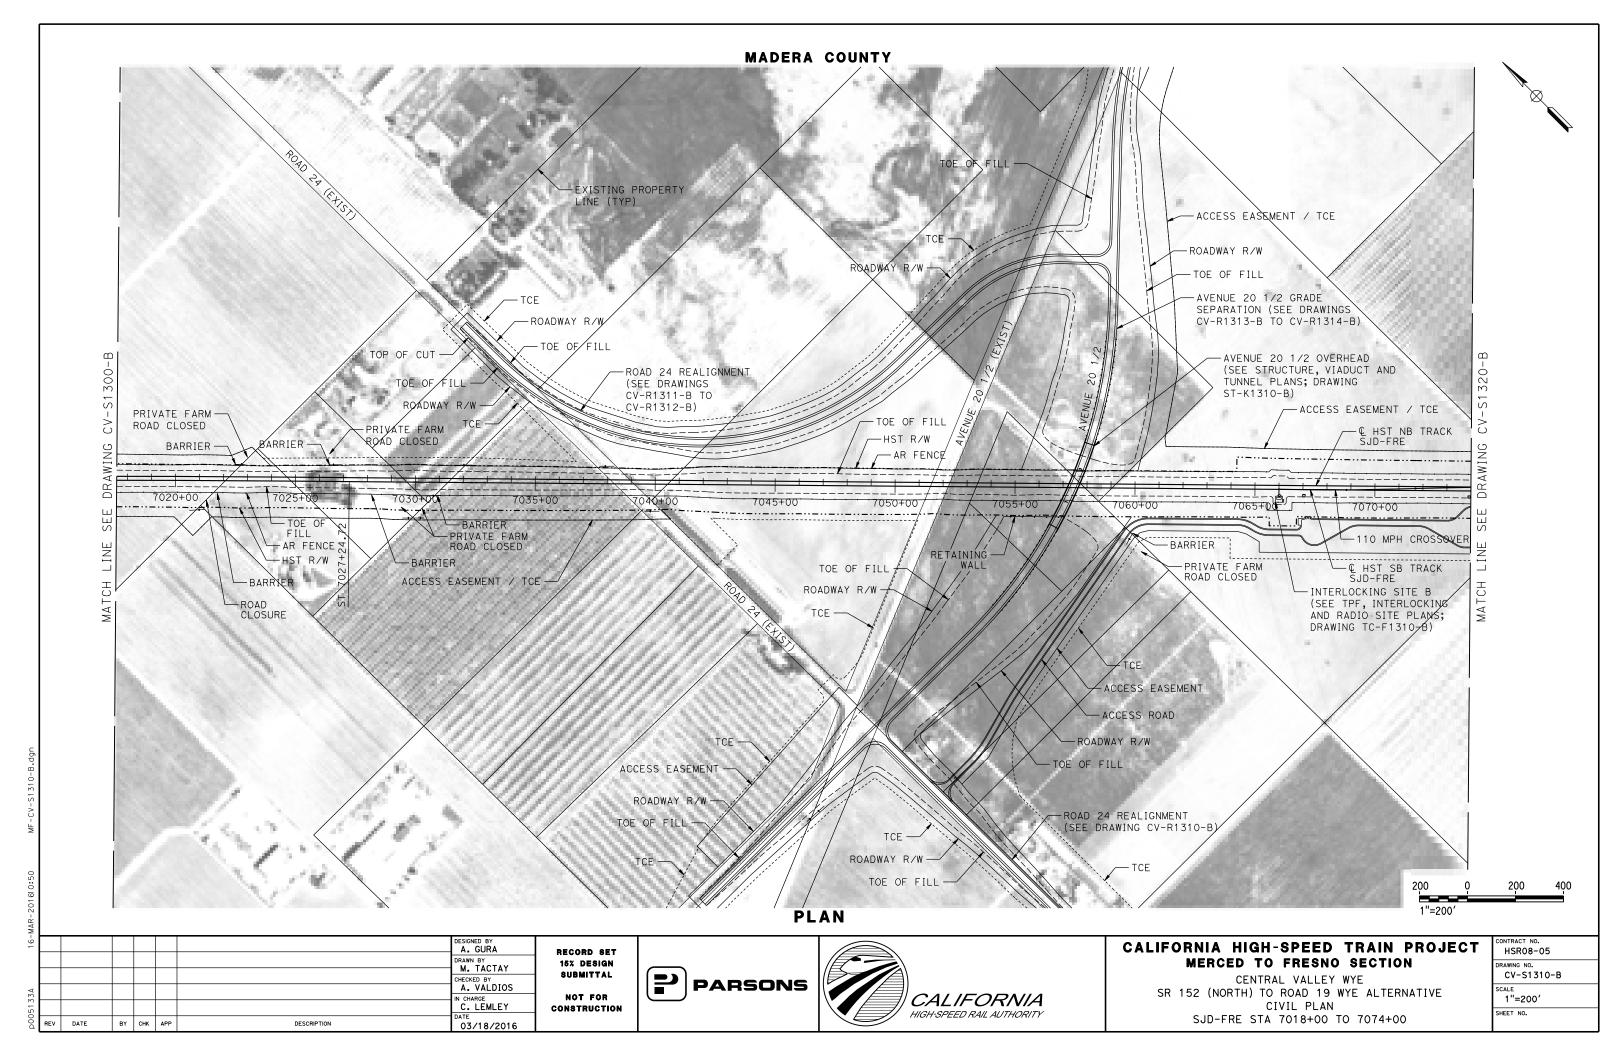
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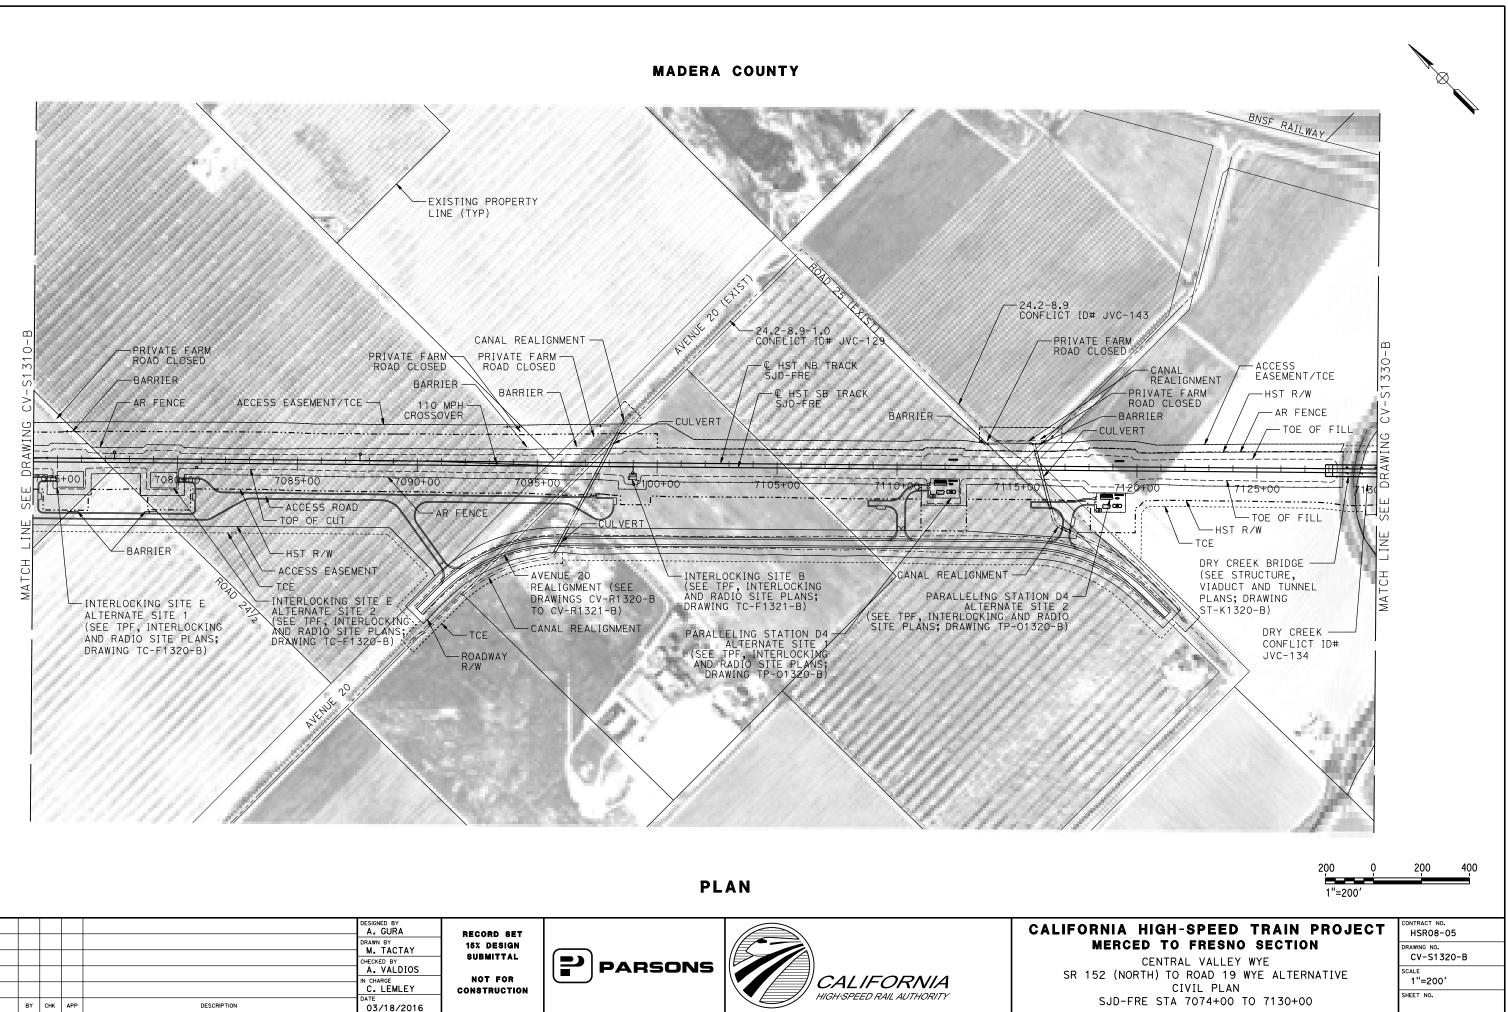


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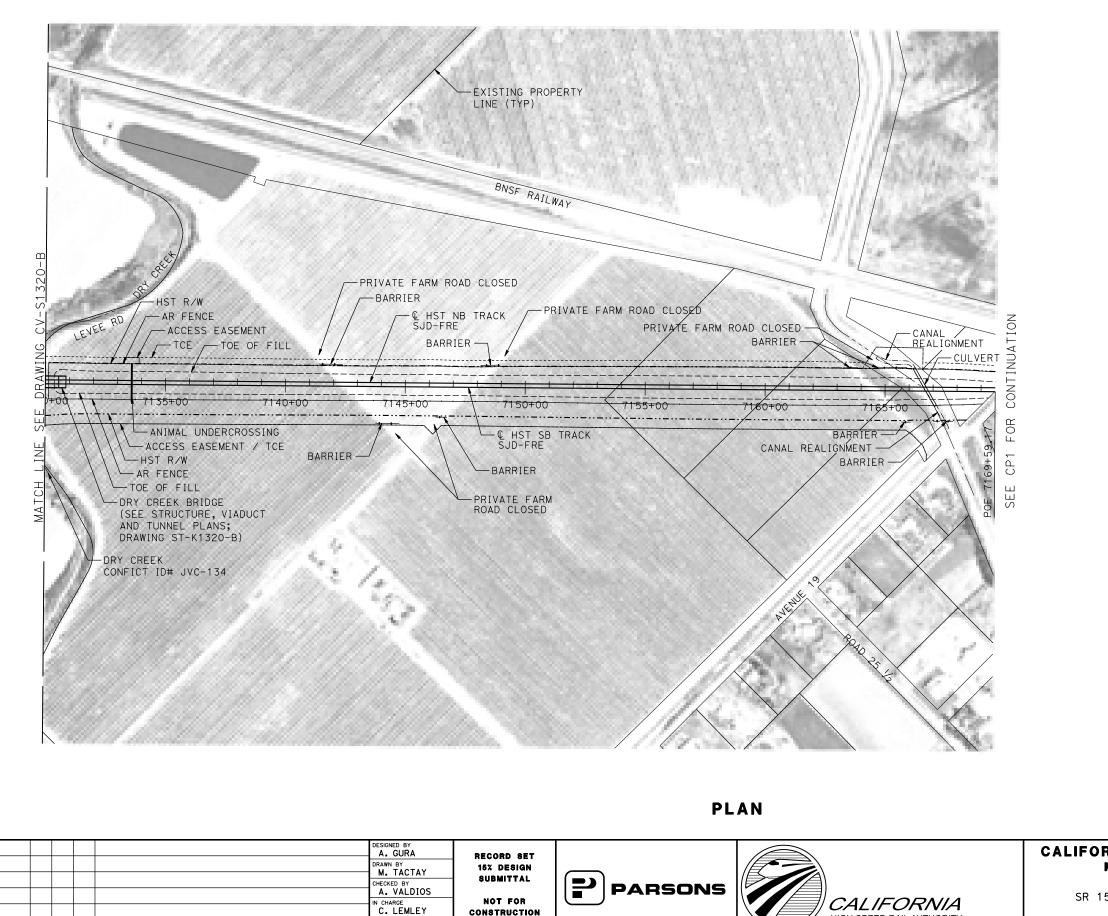


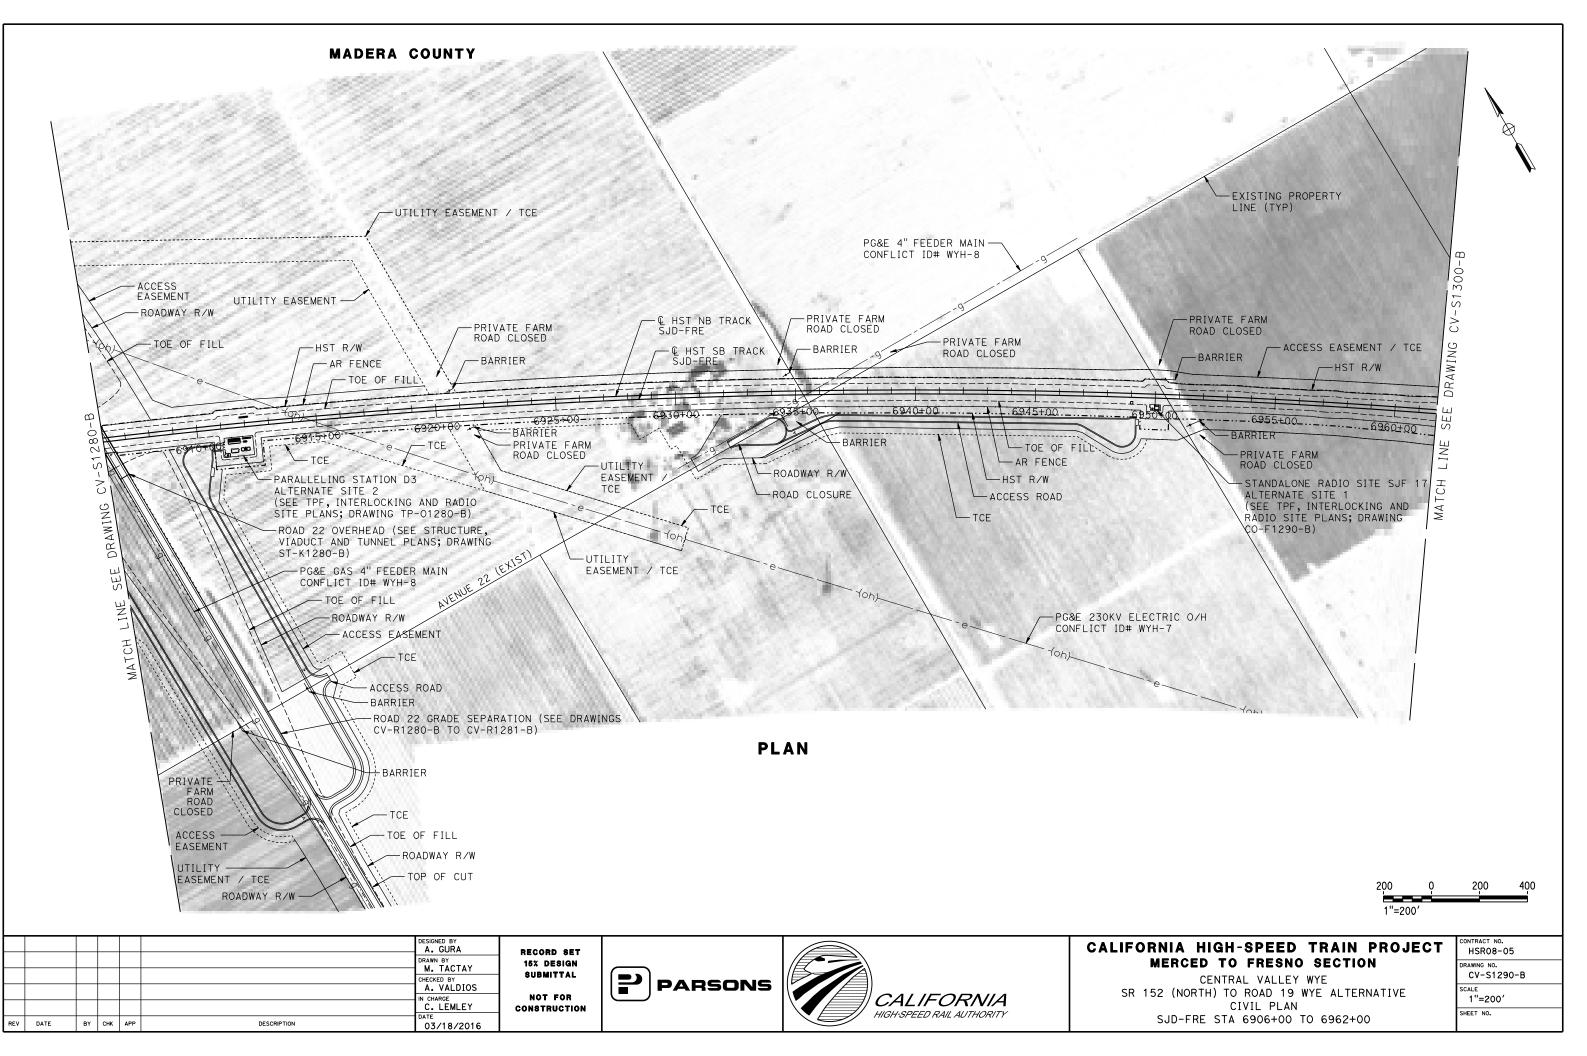



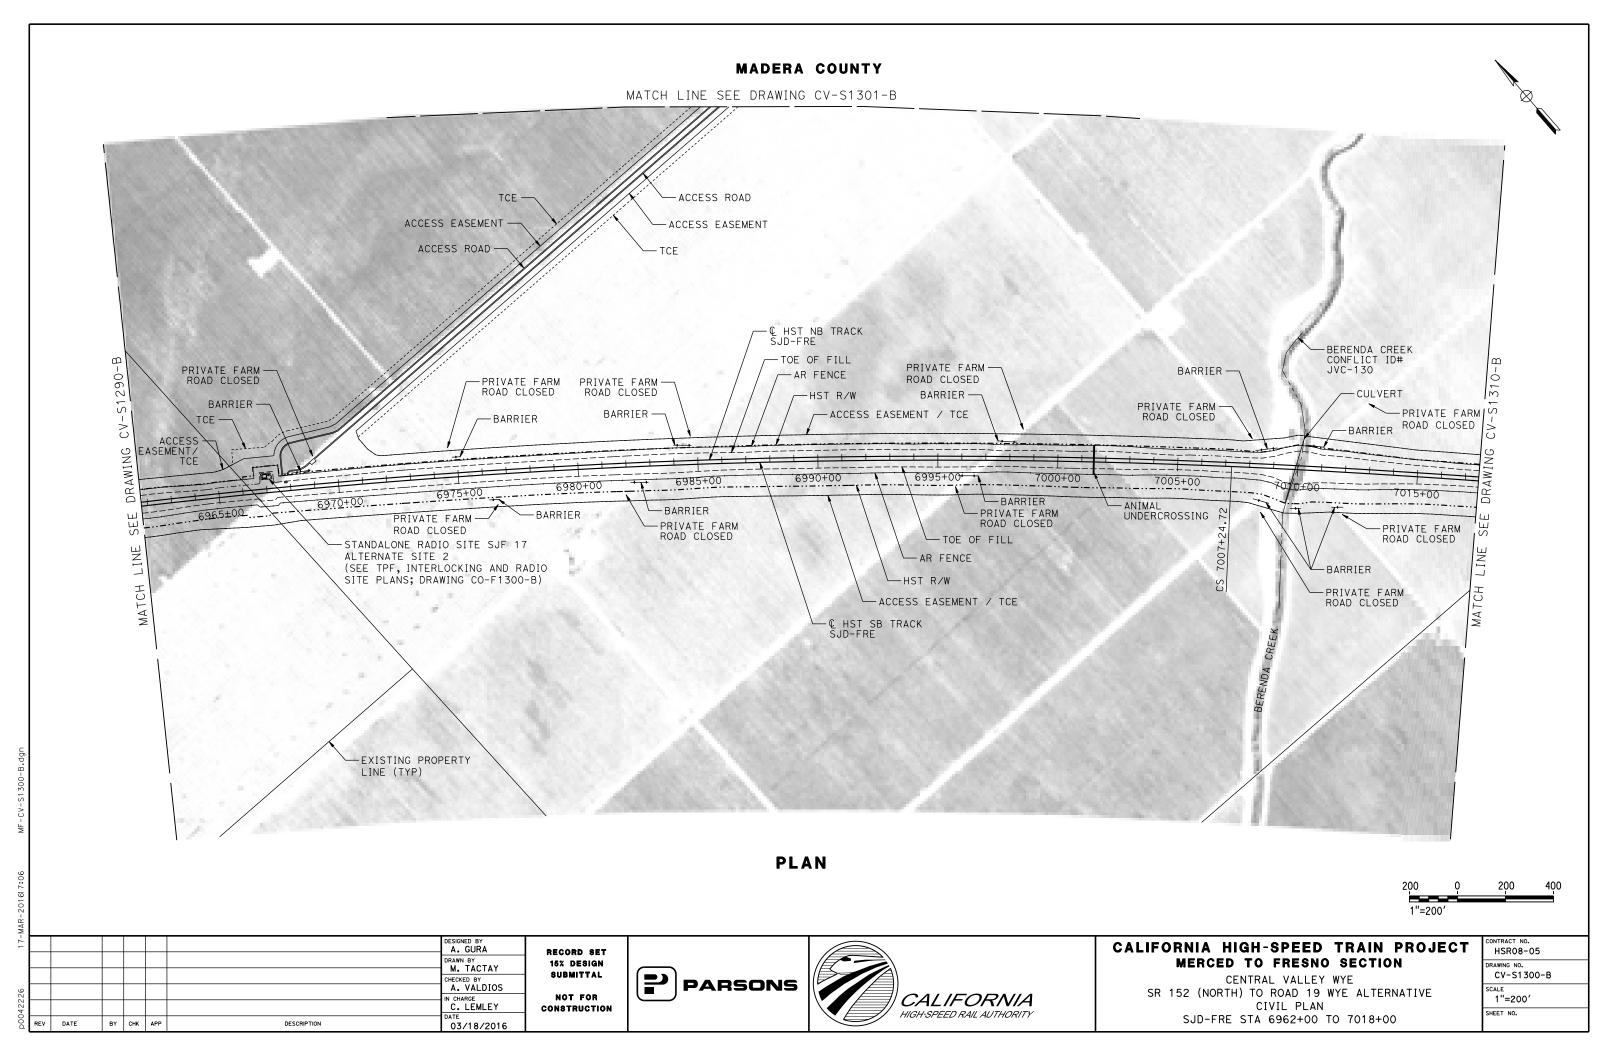

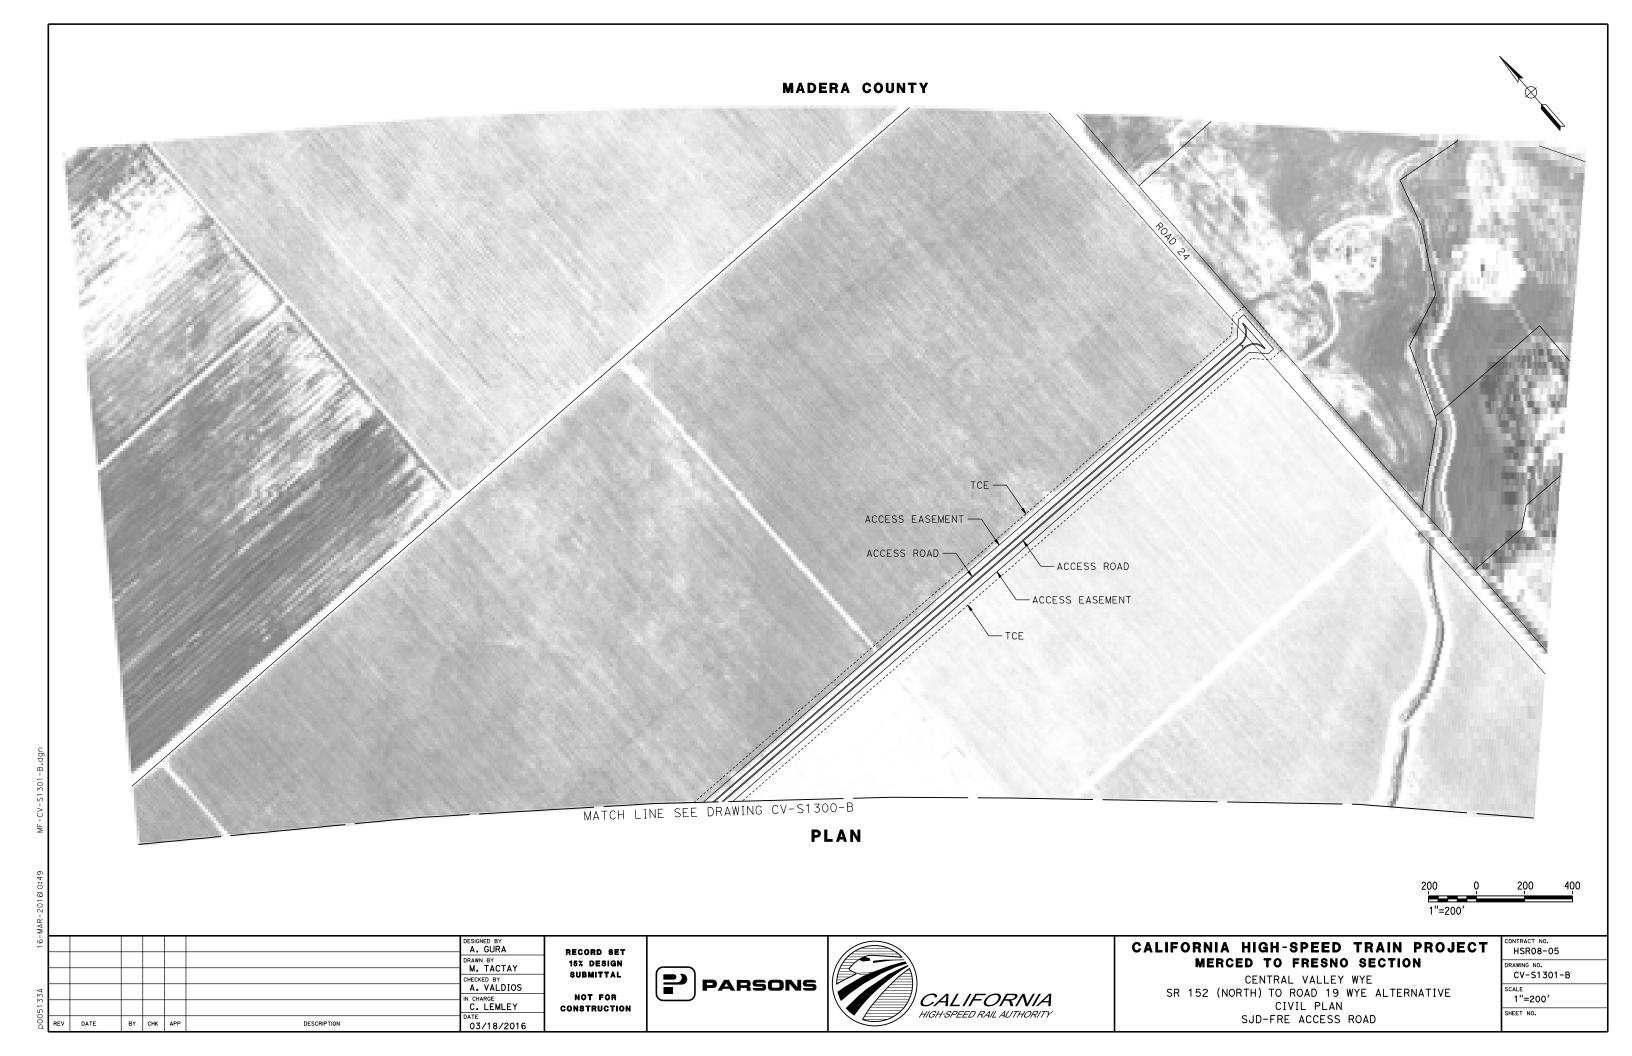REV DATE MADERA COUNTY



03/18/2016



REV DATE

ВҮ СНК АРР

DESCRIPTION

HIGH-SPEED RAIL AUTHORITY

1"=200'	
IFORNIA HIGH-SPEED TRAIN PROJECT MERCED TO FRESNO SECTION CENTRAL VALLEY WYE SR 152 (NORTH) TO ROAD 19 WYE ALTERNATIVE CIVIL PLAN SJD-FRE STA 7130+00 TO 7169+59.17	CONTRACT NO. HSR08-05 DRAWING NO. CV-S1330-B SCALE 1"=200' SHEET NO.


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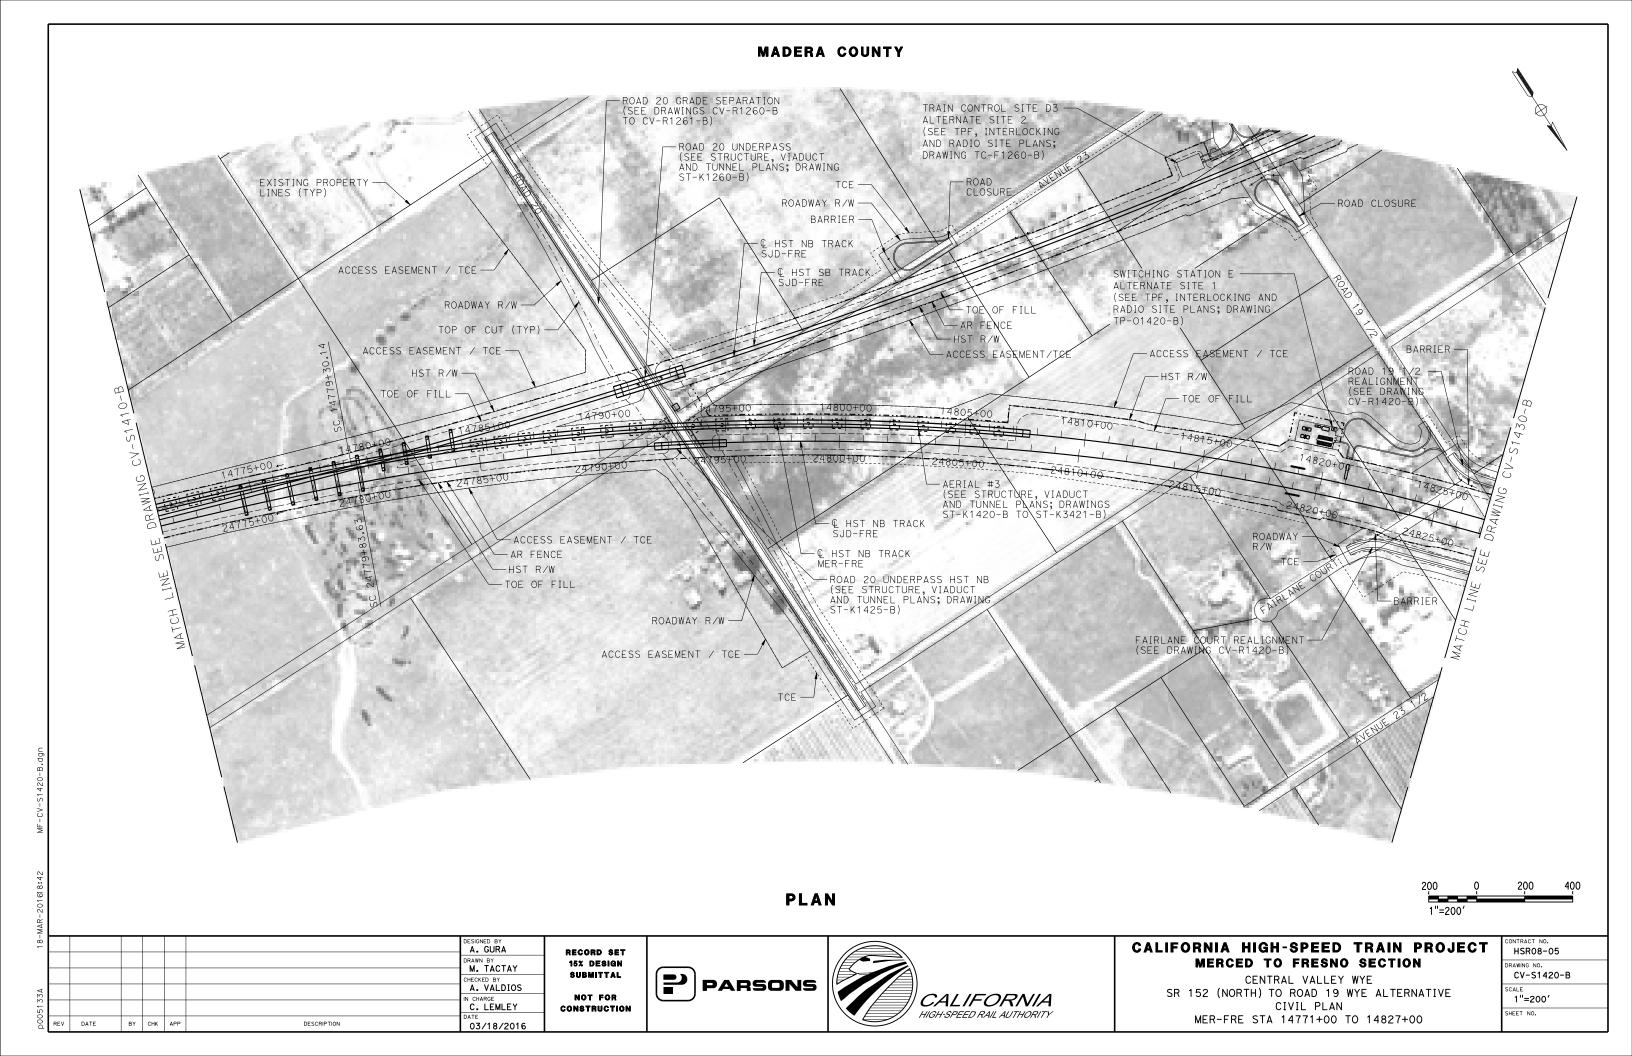
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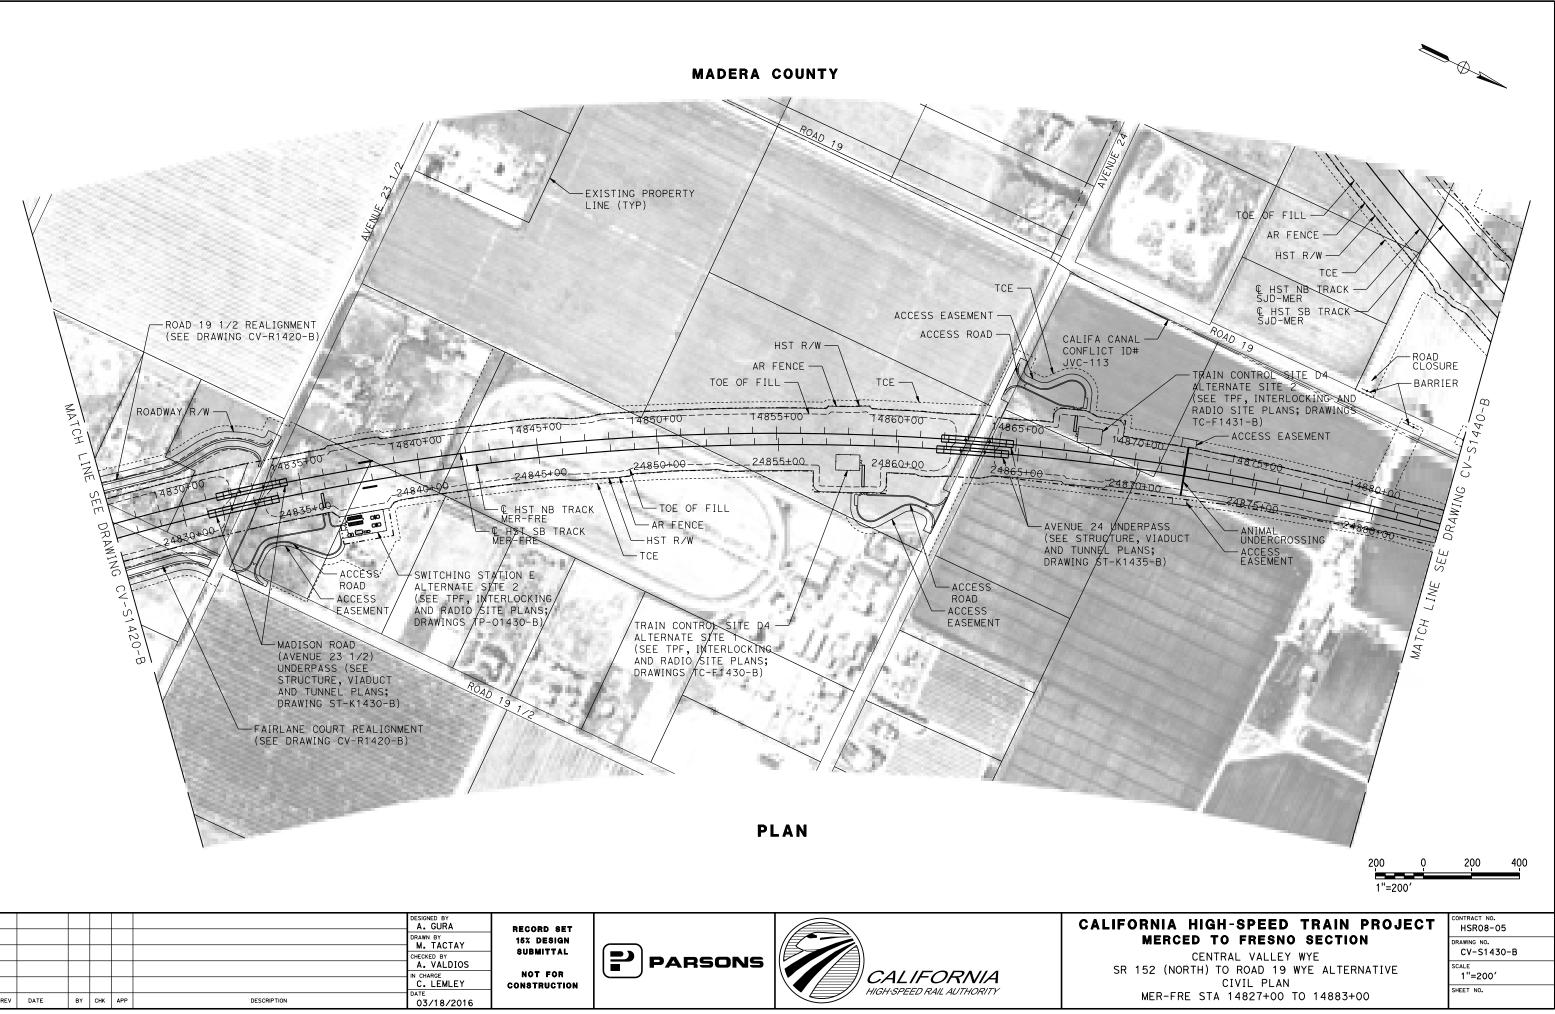






							A. GURA	RECORD SET			CALIFOF
							DRAWN BY M. TACTAY	15% DESIGN			''
\downarrow							CHECKED BY A. VALDIOS	SUBMITTAL	PARSONS		
ι ι							IN CHARGE C. LEMLEY	NOT FOR Construction		CALIFORNIA	SR 15
5 22 F	REV DATE	E	BY	снк	APP	DESCRIPTION	DATE 03/18/2016			HIGH-SPEED RAIL AUTHORITY	ME




MADERA COUNTY

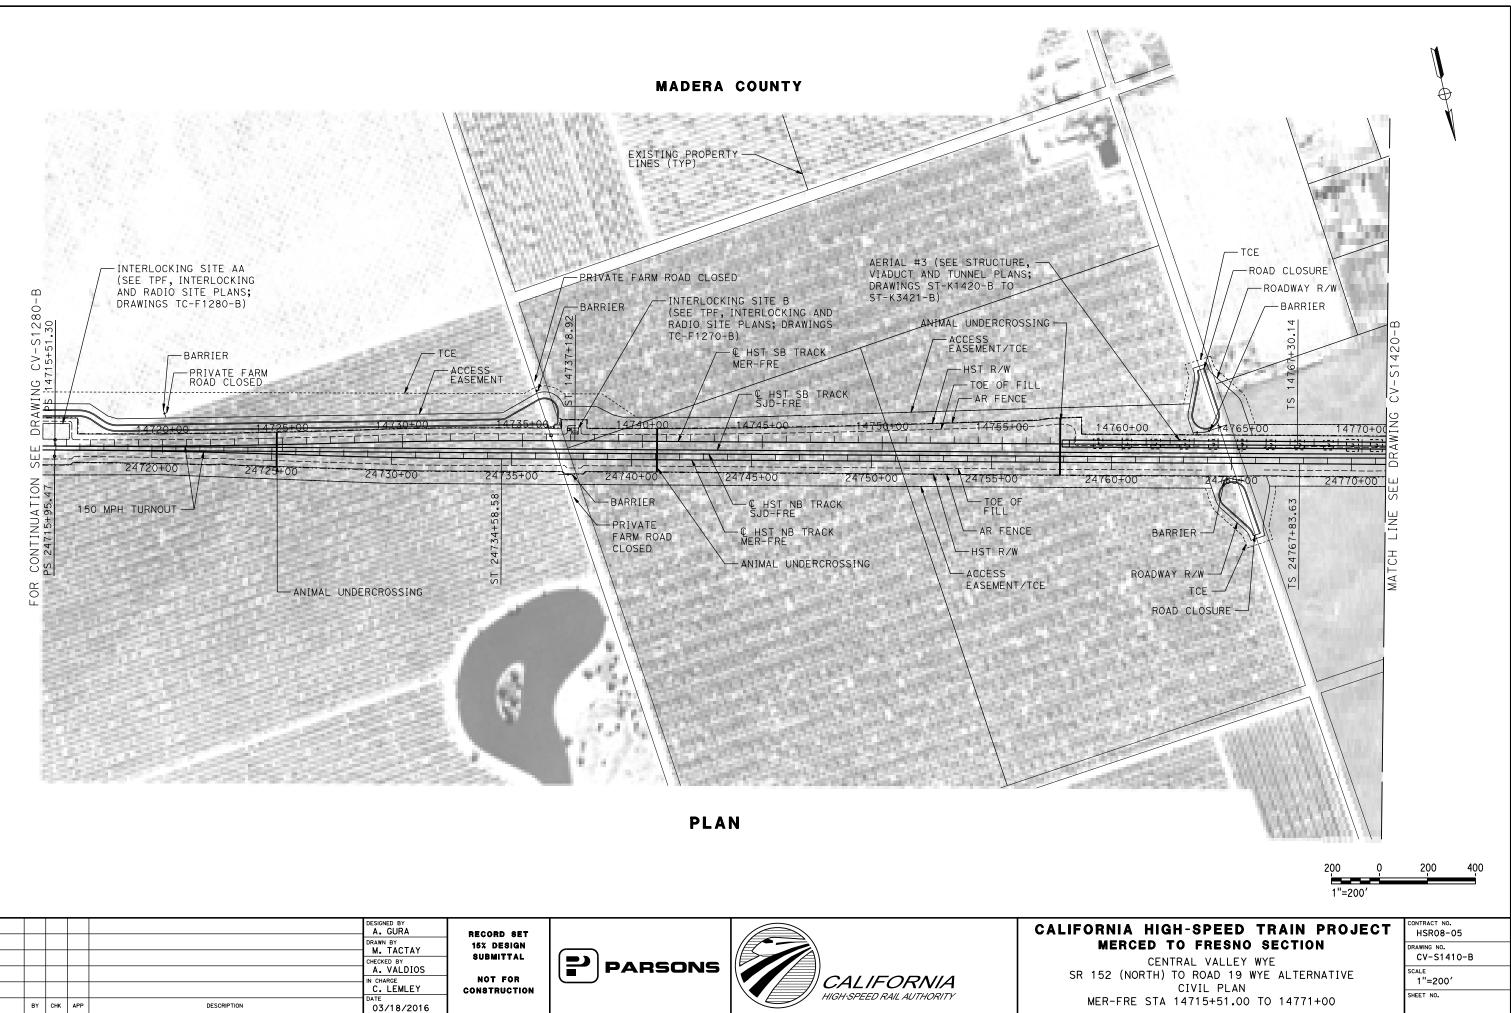


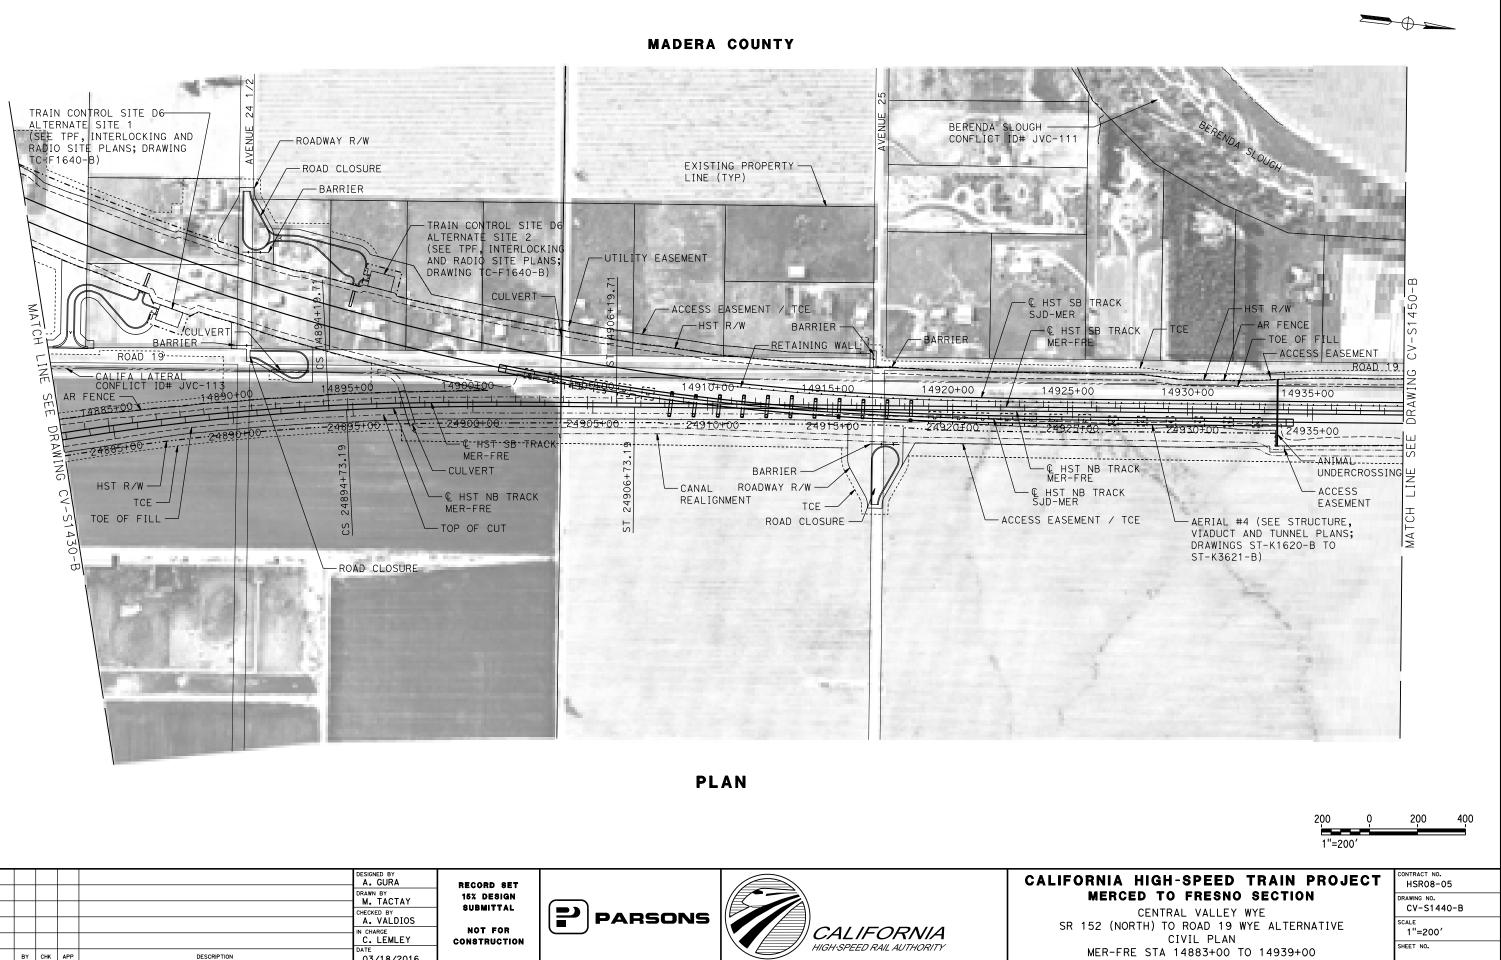

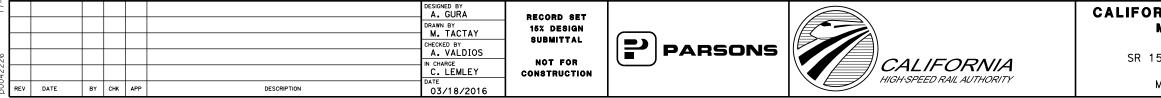


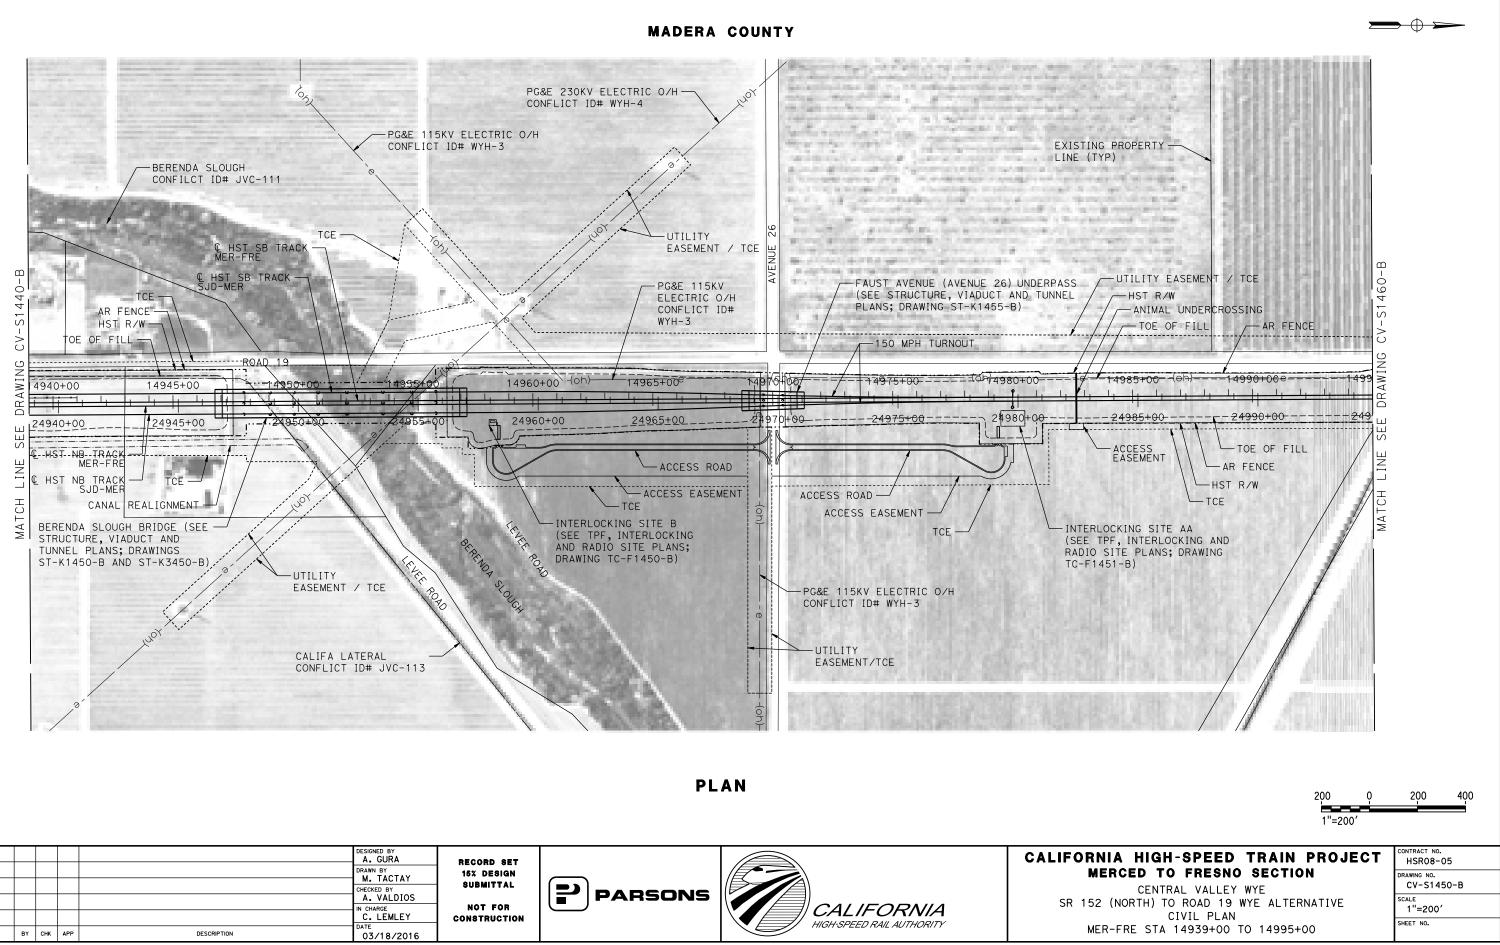


REV DATE

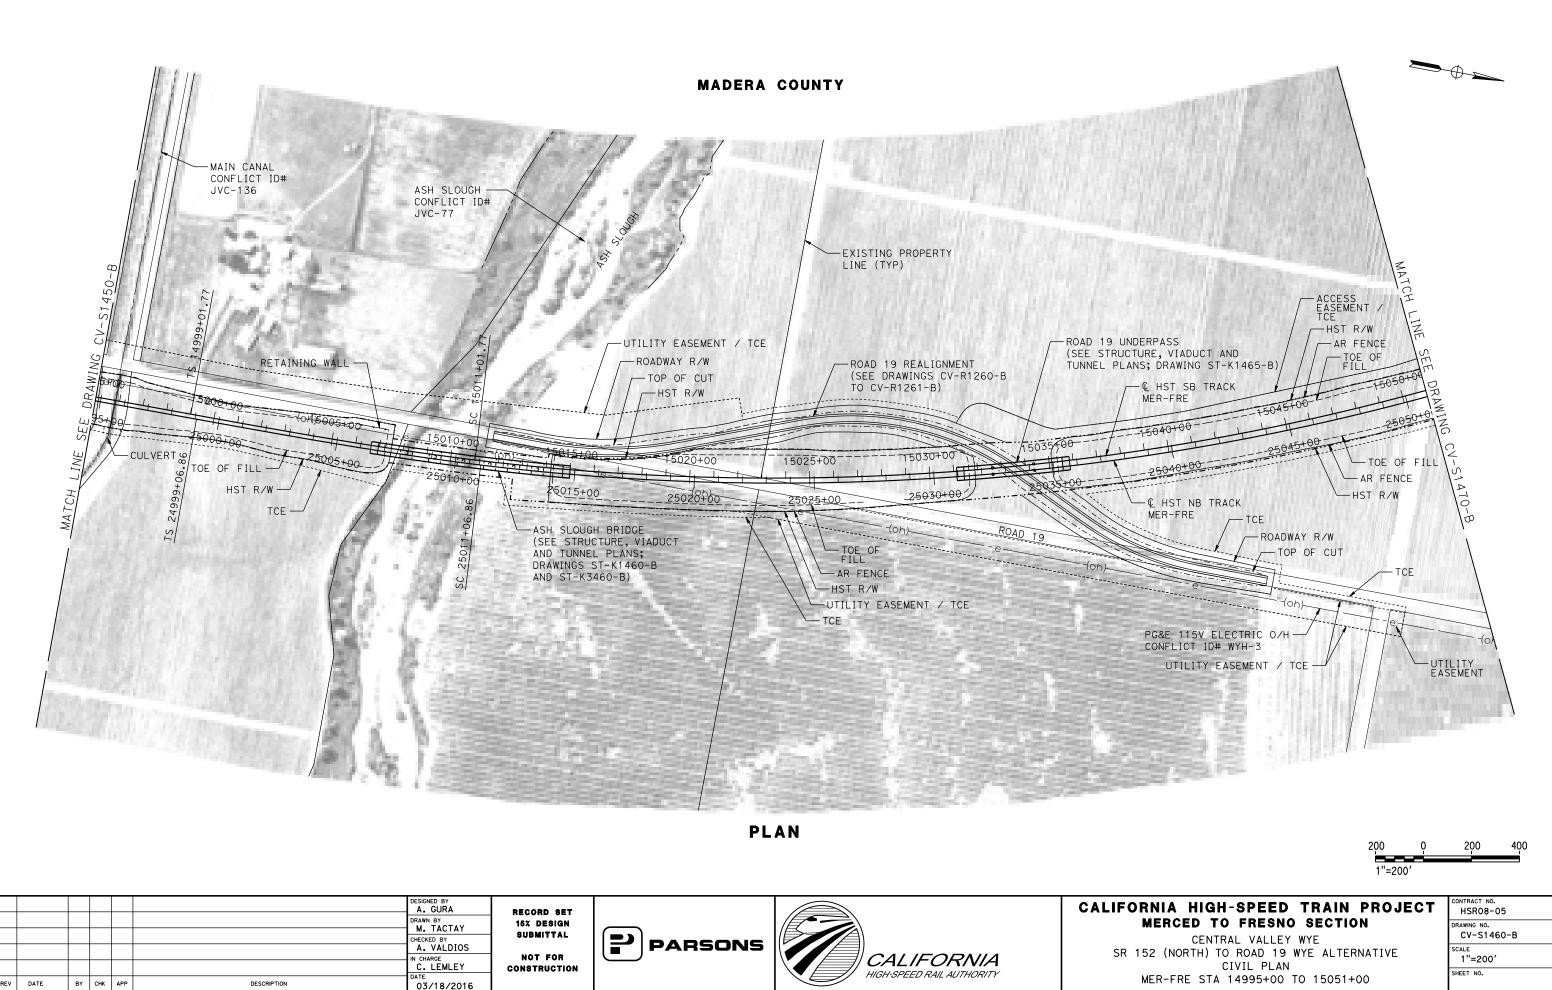


SR	15
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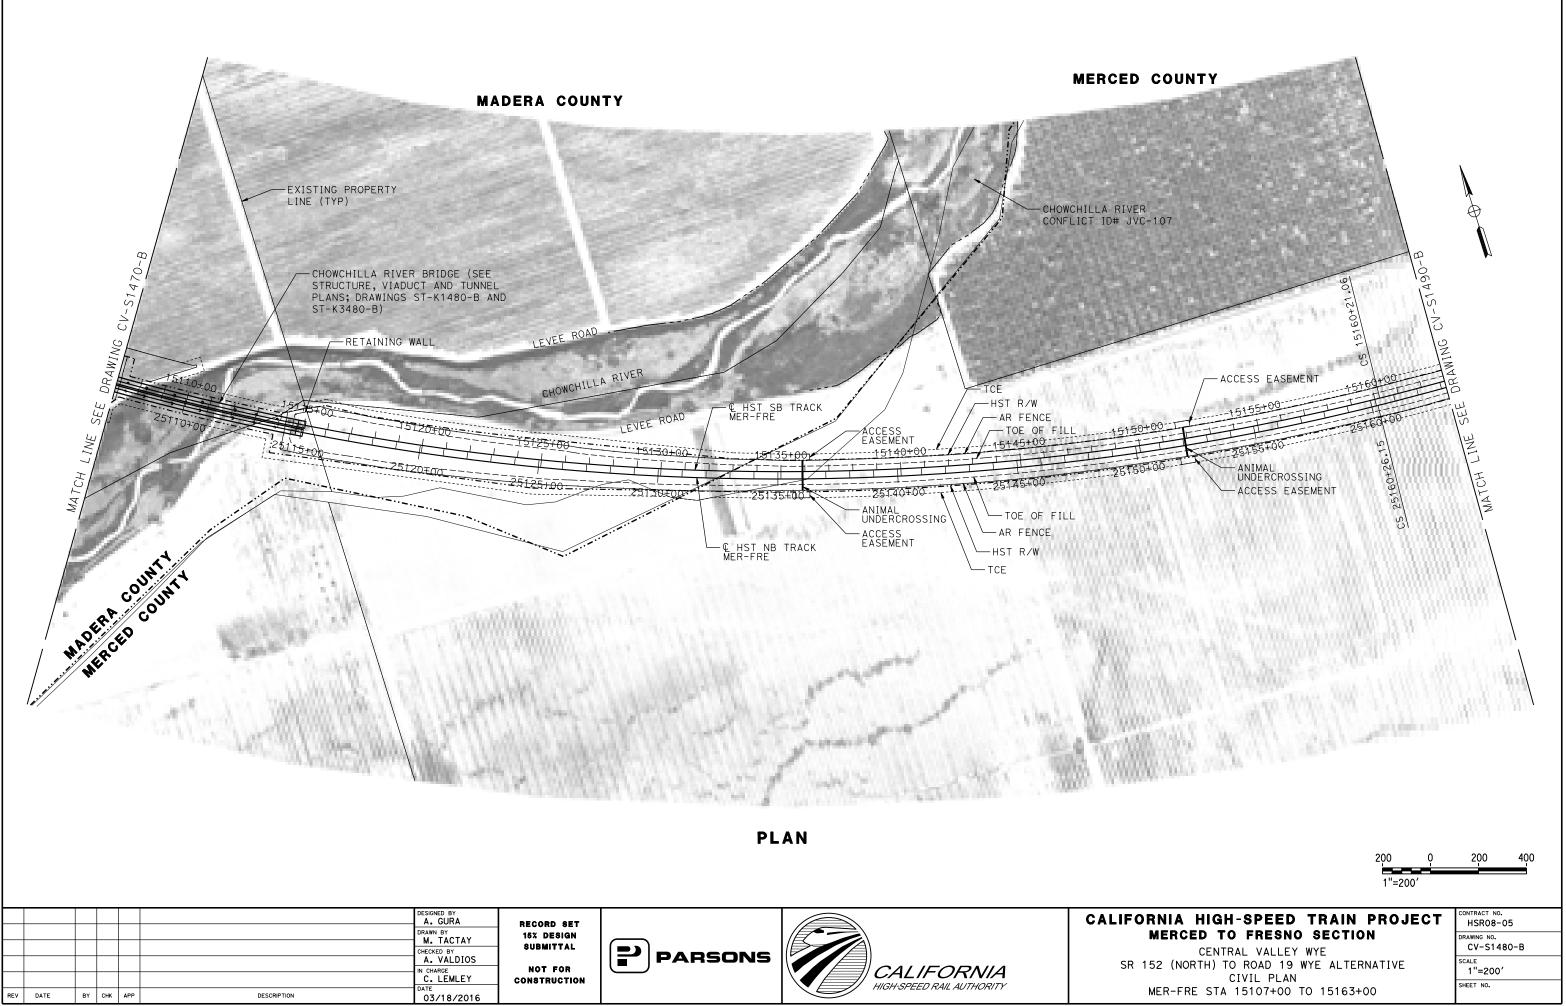


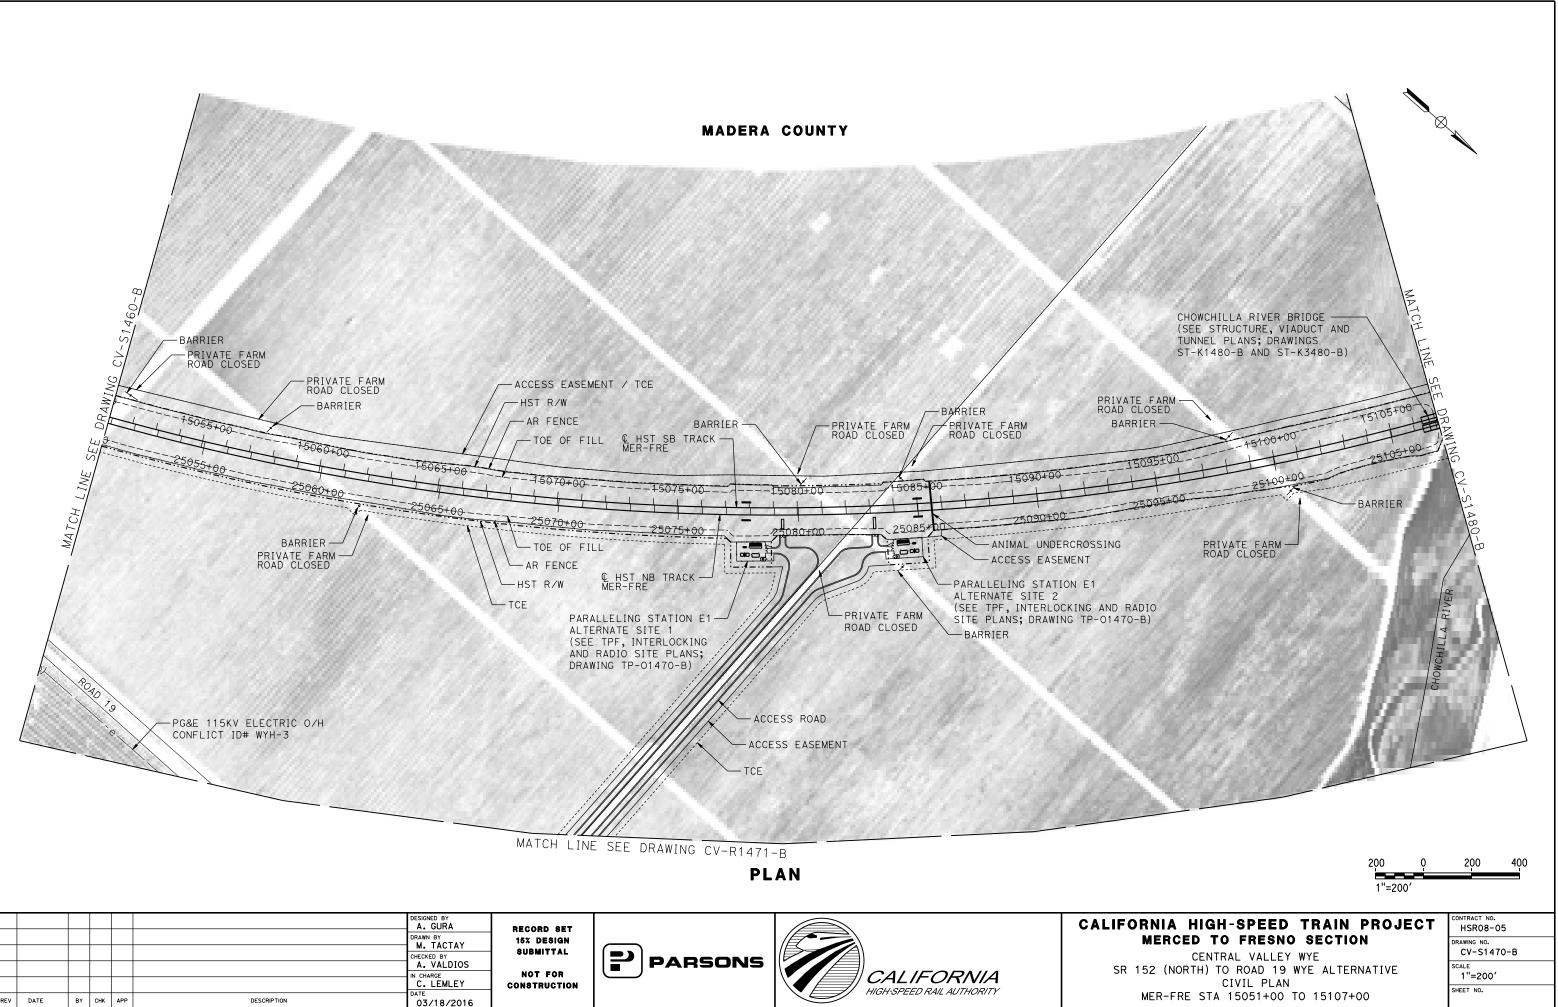





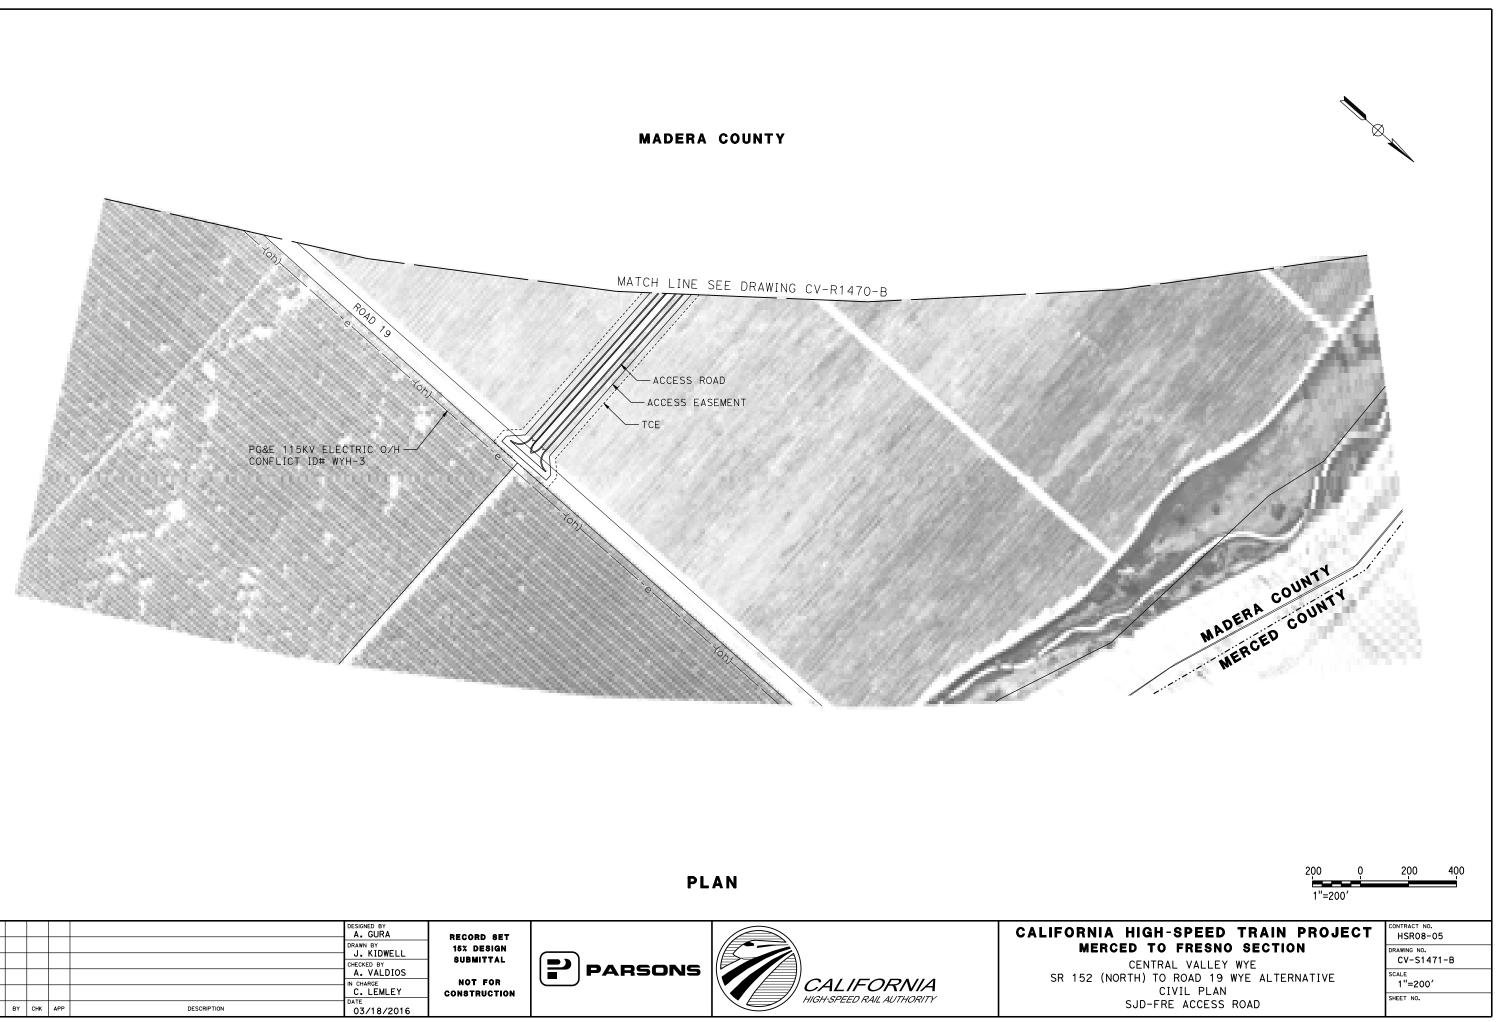




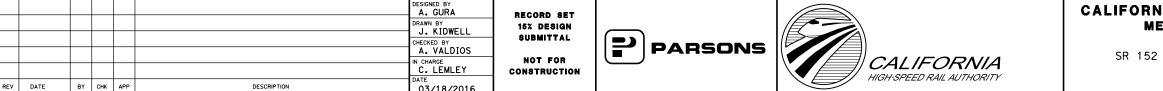


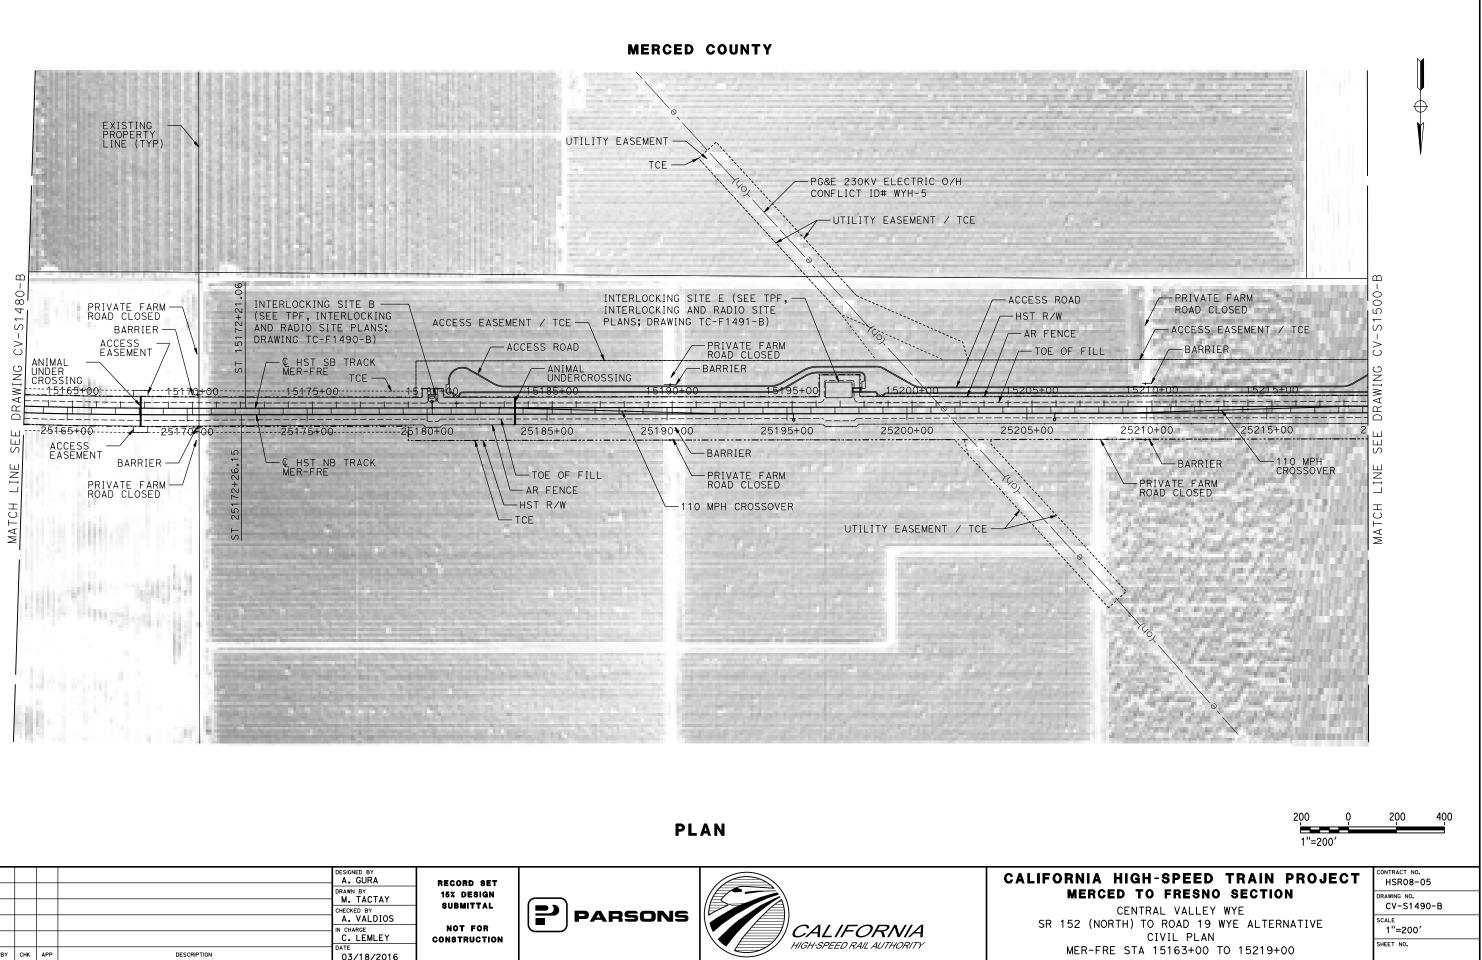


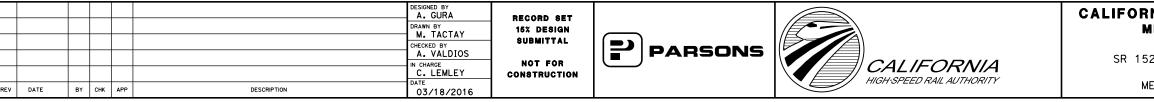


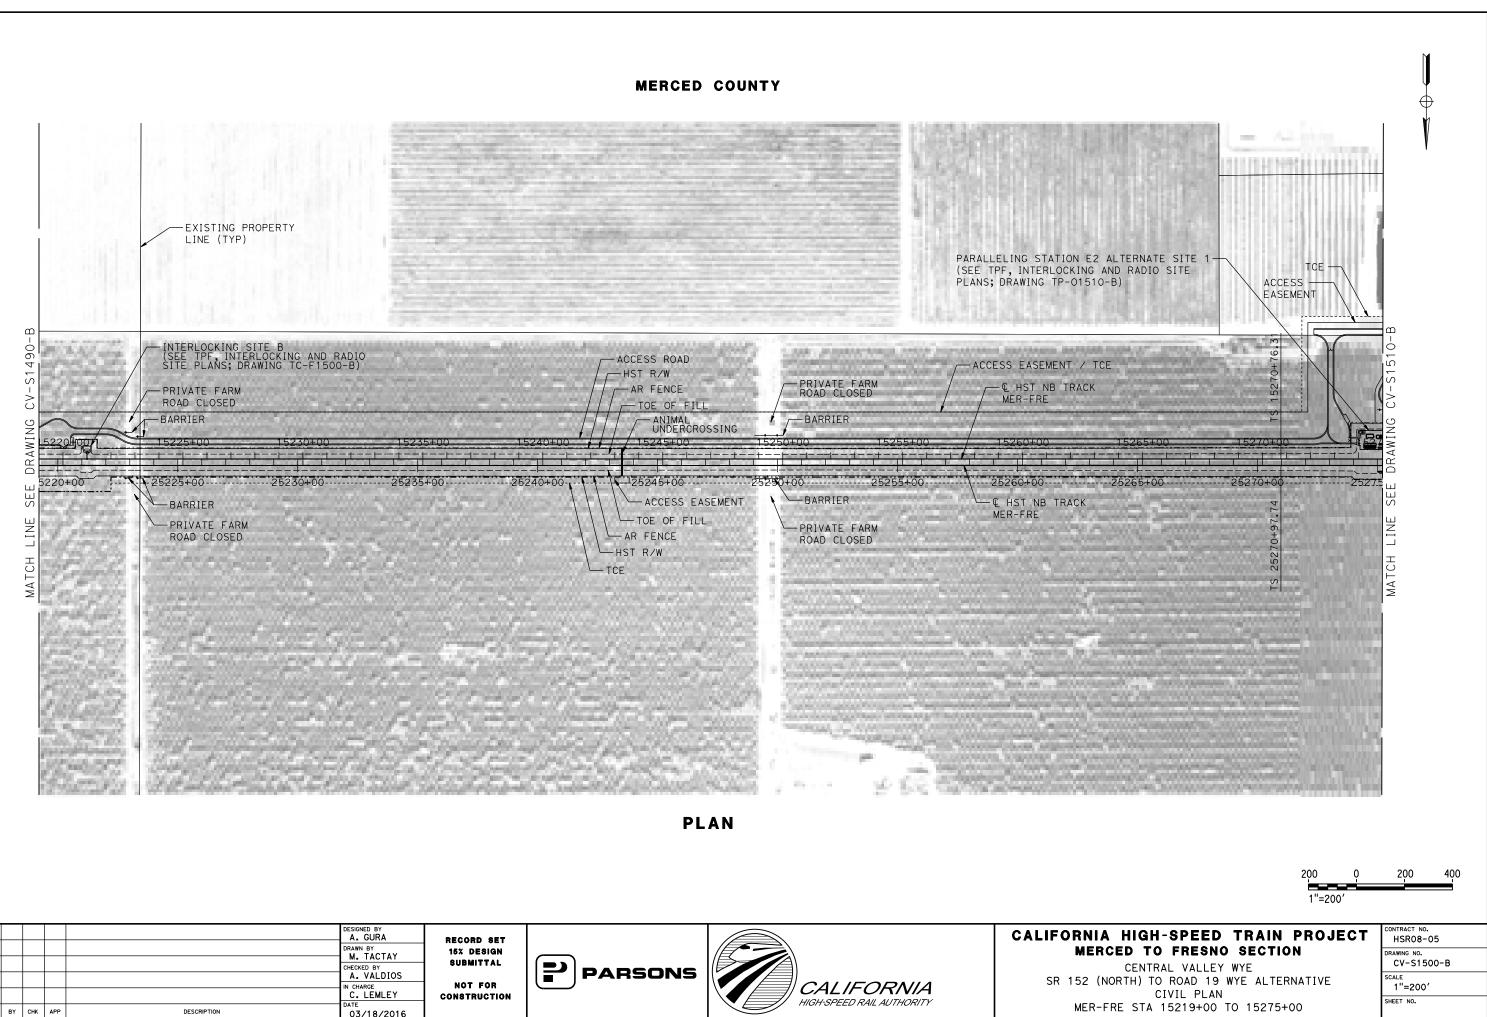


					DESIGNED BY A. GURA DRAWN BY M. TACTAY CHECKED BY	RECORD SET 15% design Submittal			CALIFOR
					A. VALDIOS IN CHARGE C. LEMLEY DATE	NOT FOR Construction	PARSONS	CALIFORNIA HIGH-SPEED RAIL AUTHORITY	SR 15 M
í	REV DATE	ВҮ СНК	APP	DESCRIPTION	03/18/2016				

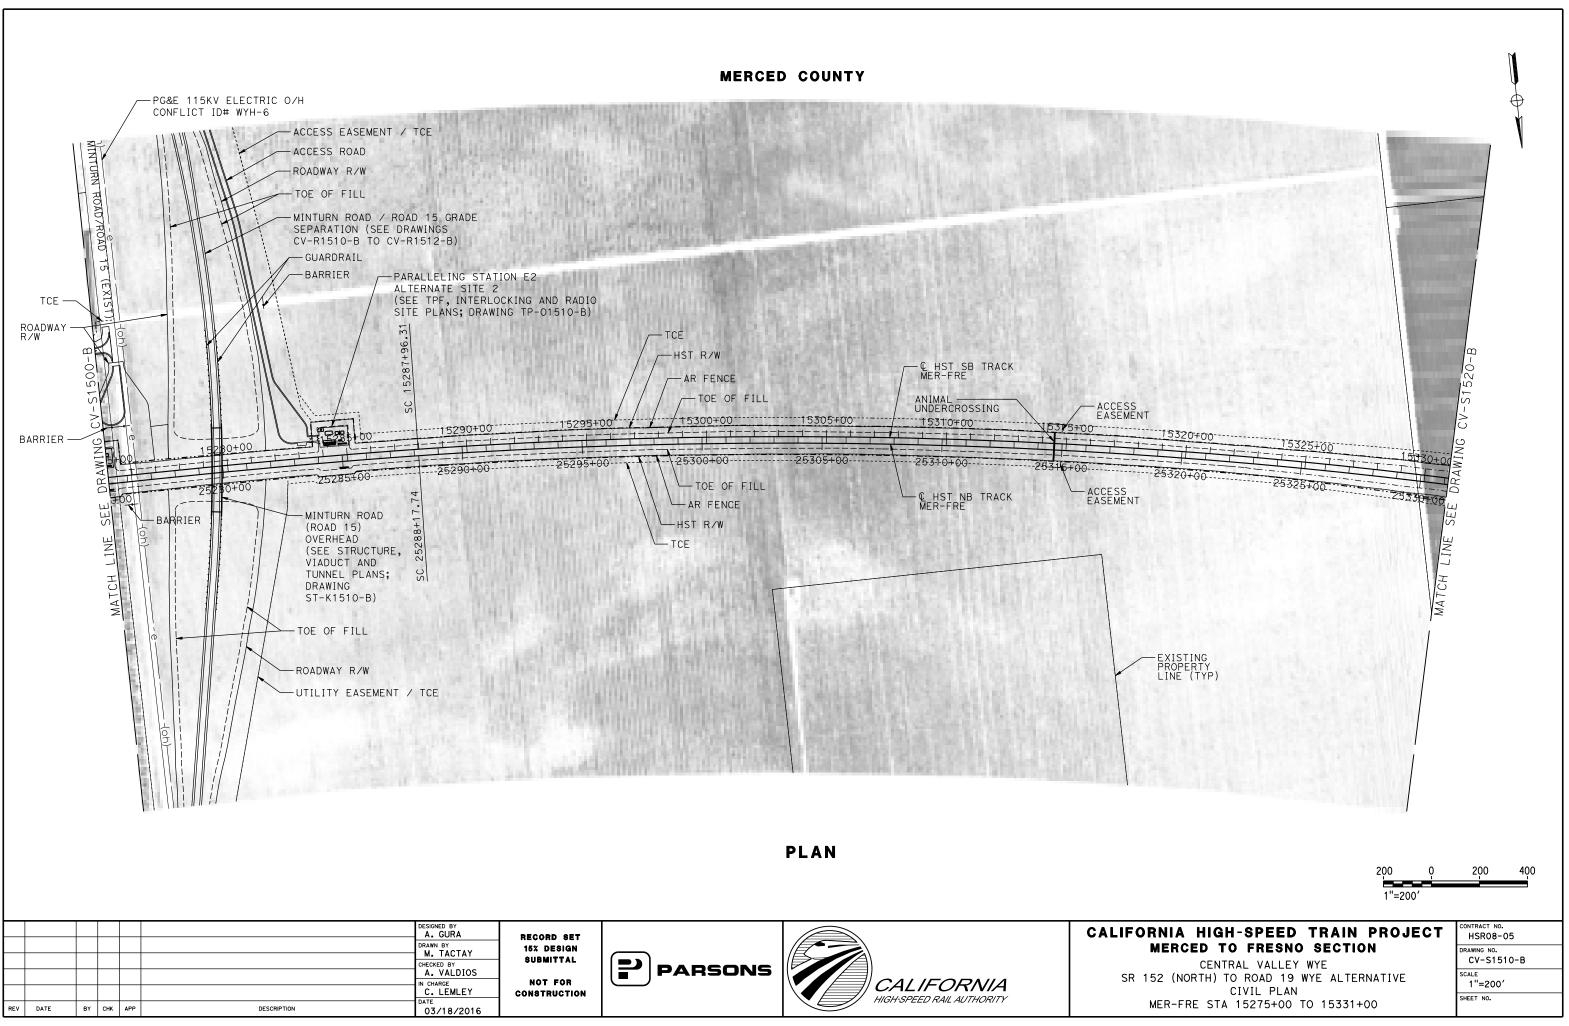

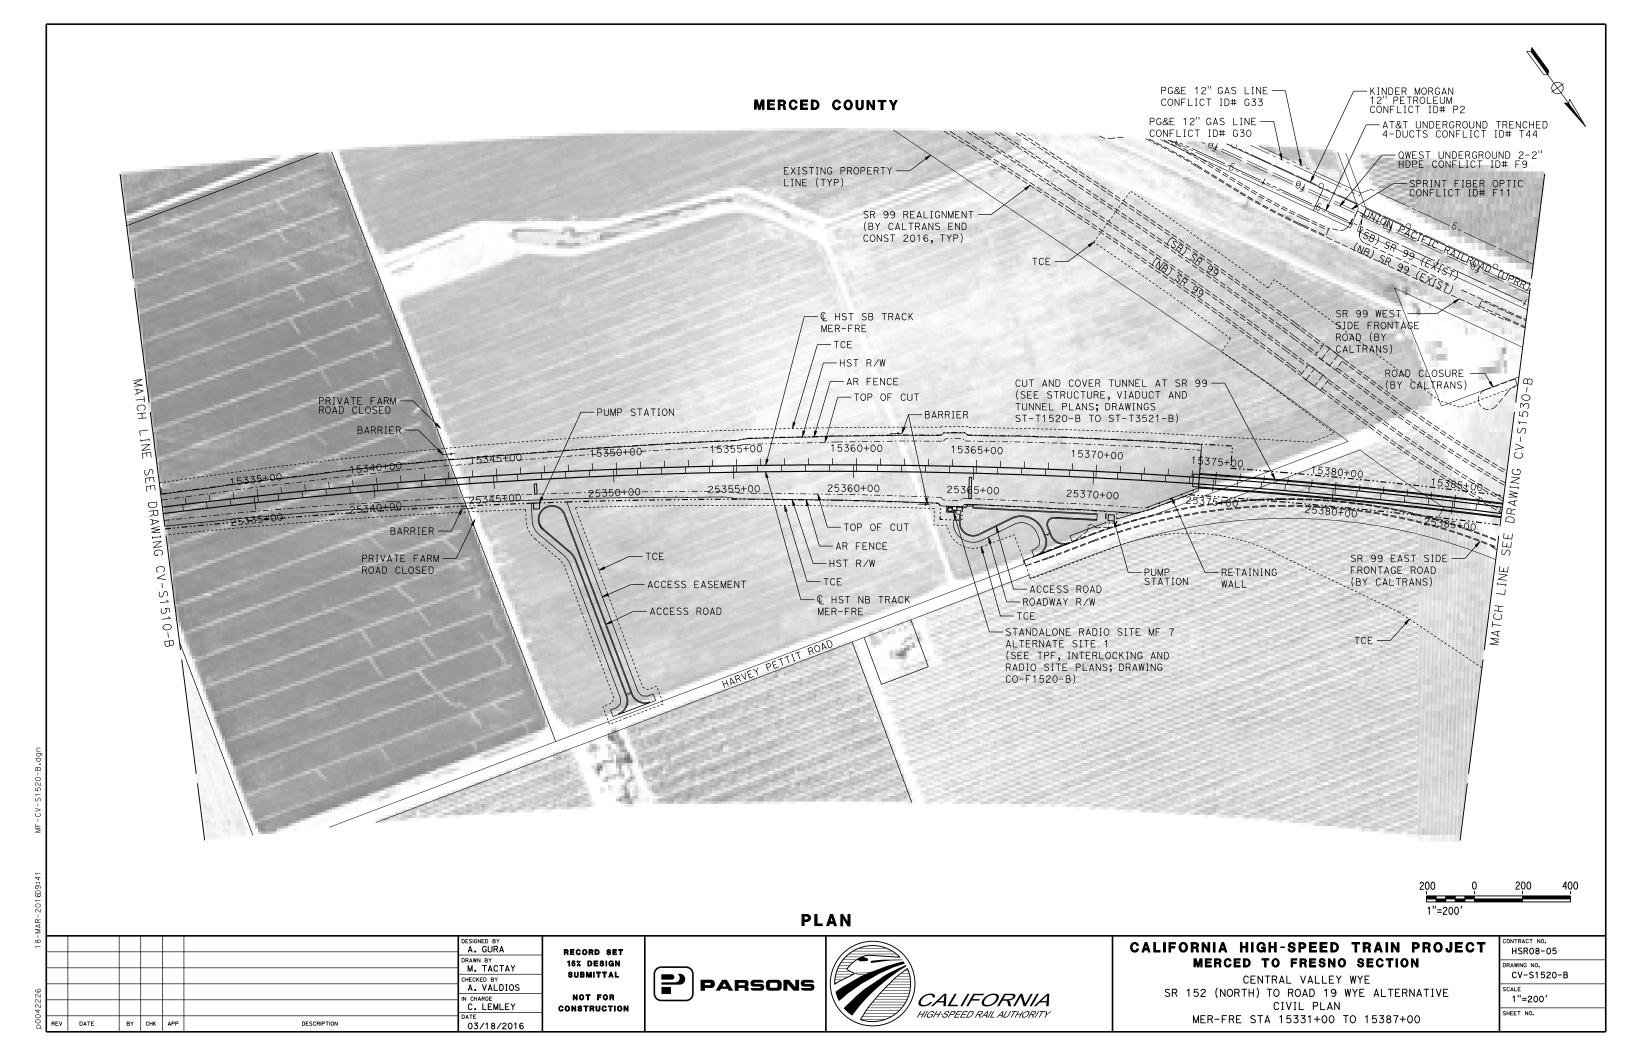

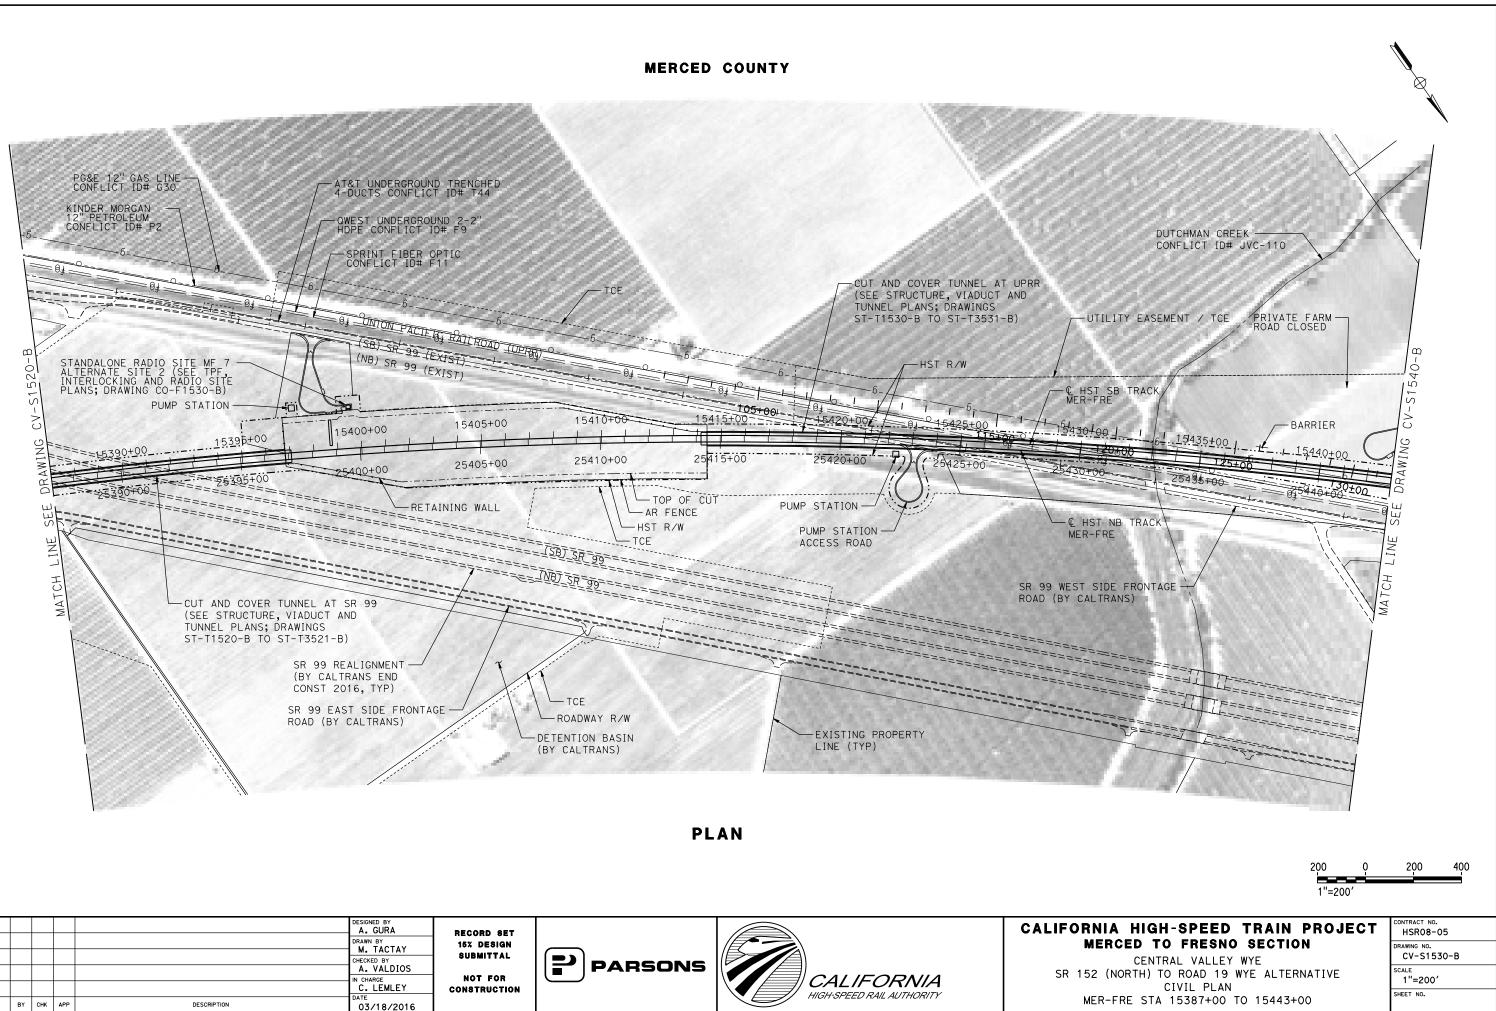

REV DATE

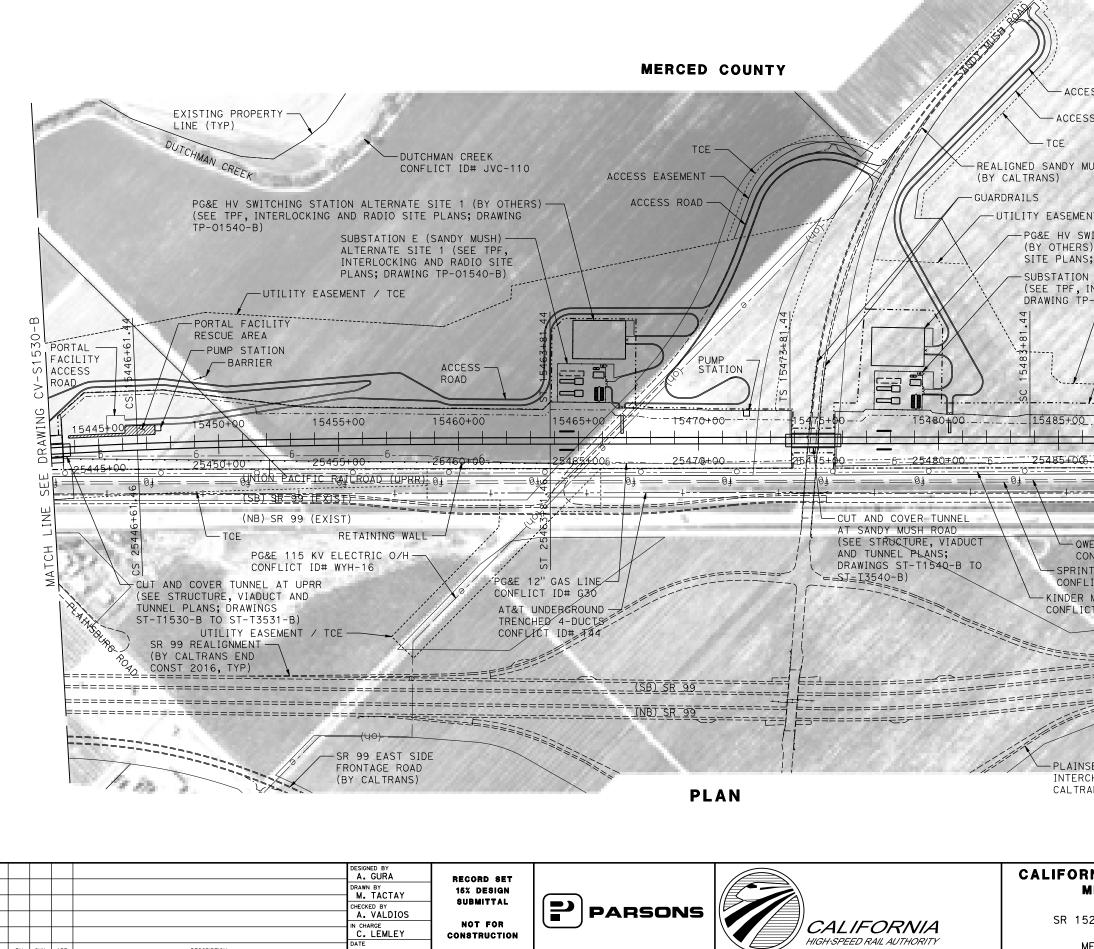

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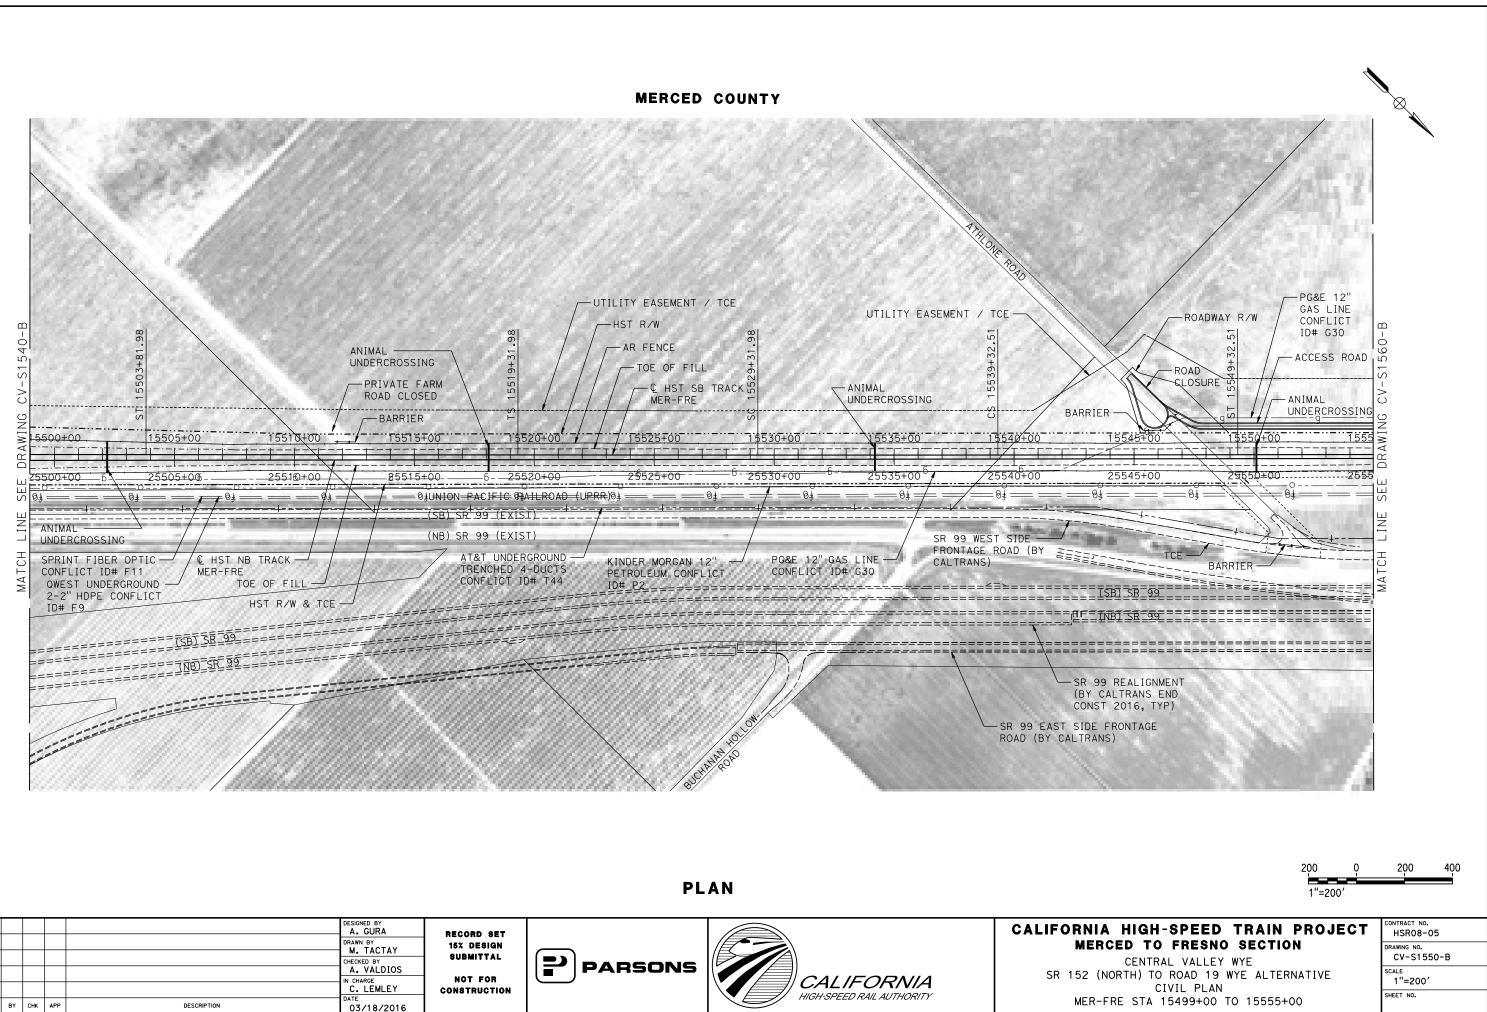
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ВҮ СНК АРР


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N E (SANDY MUSH) ALTERNATE SITE 2 INTERLOCKING AND RADIO SITE PLANS; 2-01541-B)		m
UTILITY EASEMENT / TCE 6		50-1
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SR 99 EAST SIDE FRONT ROAD (BY CALTRANS)	AGE	
SBURG ROAD		
CHANGE (BY ANS)		
	2 <u>00 0</u>	200 400
	1"=200'	
NIA HIGH-SPEED TRAIN P	DO IECT	CONTRACT NO.
MERCED TO FRESNO SECTION		HSR08-05 DRAWING NO.
CENTRAL VALLEY WYE 52 (NORTH) TO ROAD 19 WYE ALTERN	ATIVE	CV-S1540-B
CIVIL PLAN MER-FRE STA 15443+00 TO 15499+00		1"=200' SHEET NO.
ILIN THE STA 19449700 TO 19499700	'	





RFV DATE



DATE
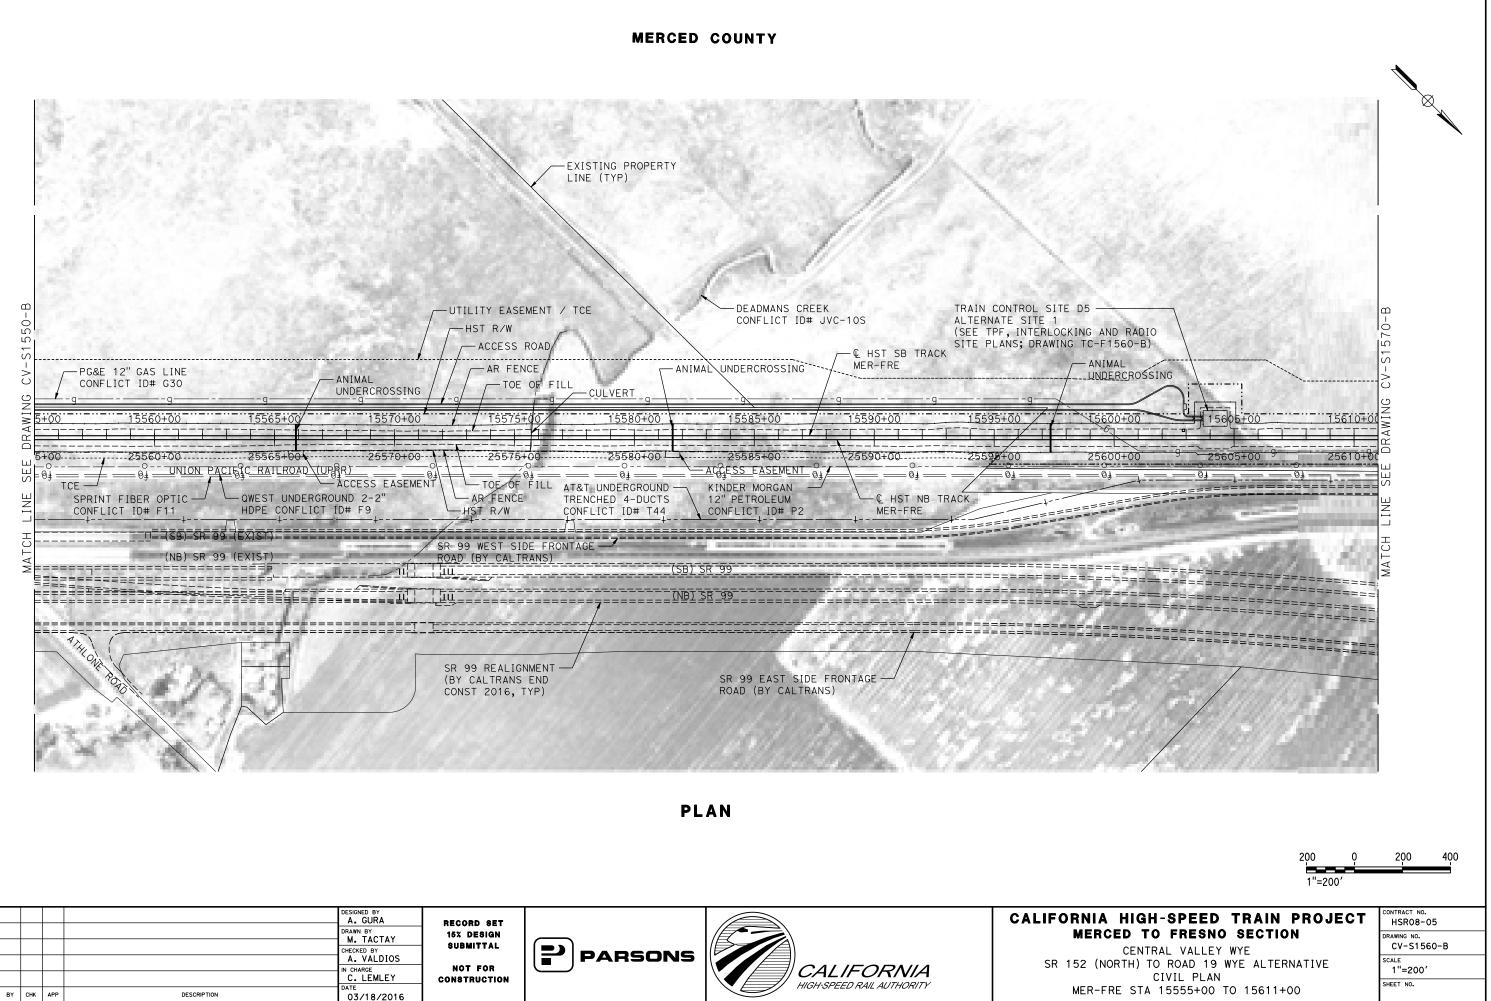
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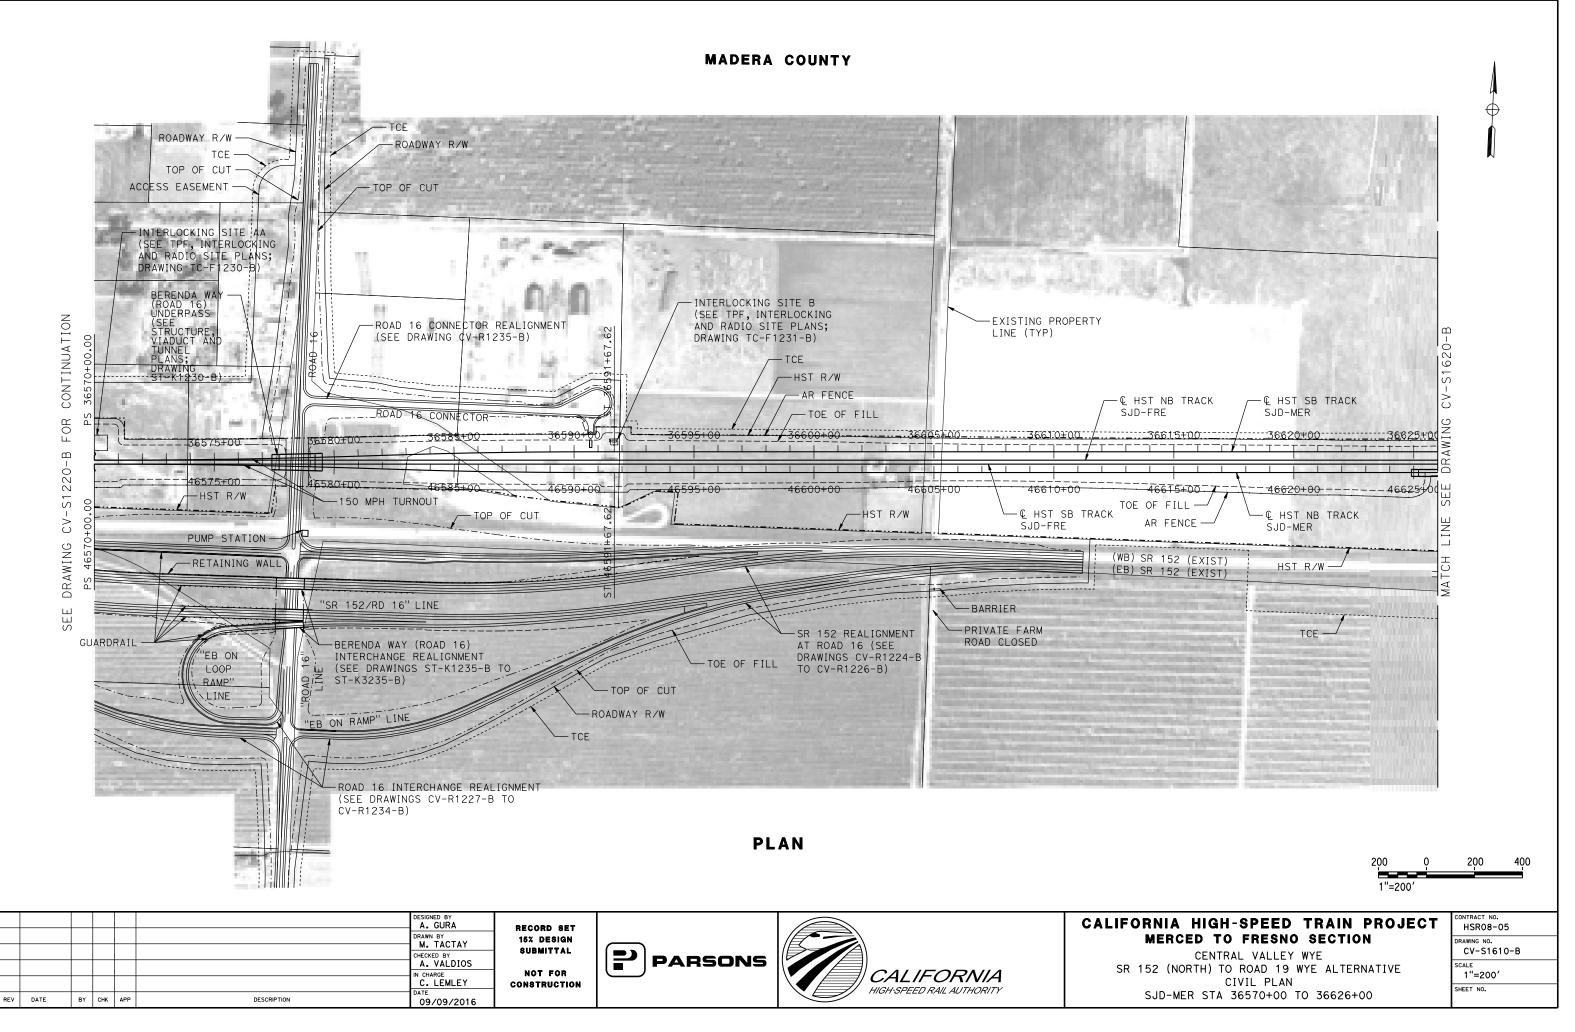


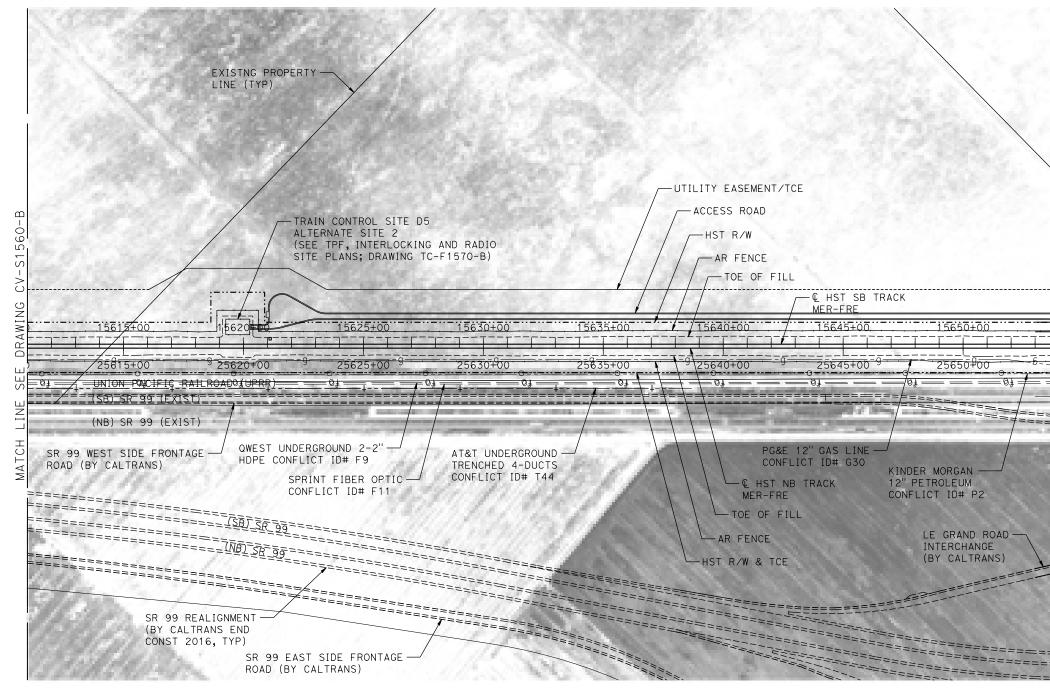

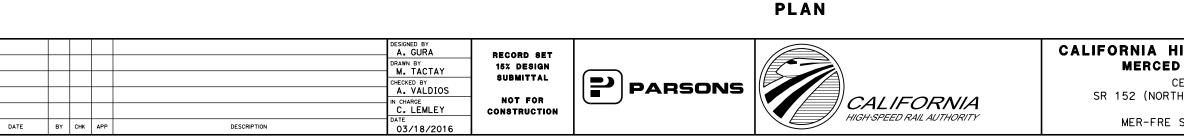
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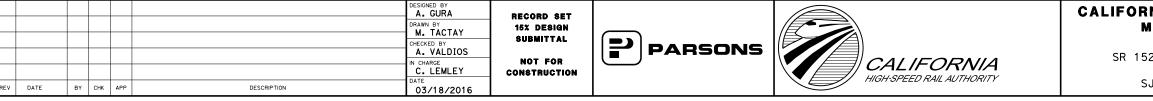
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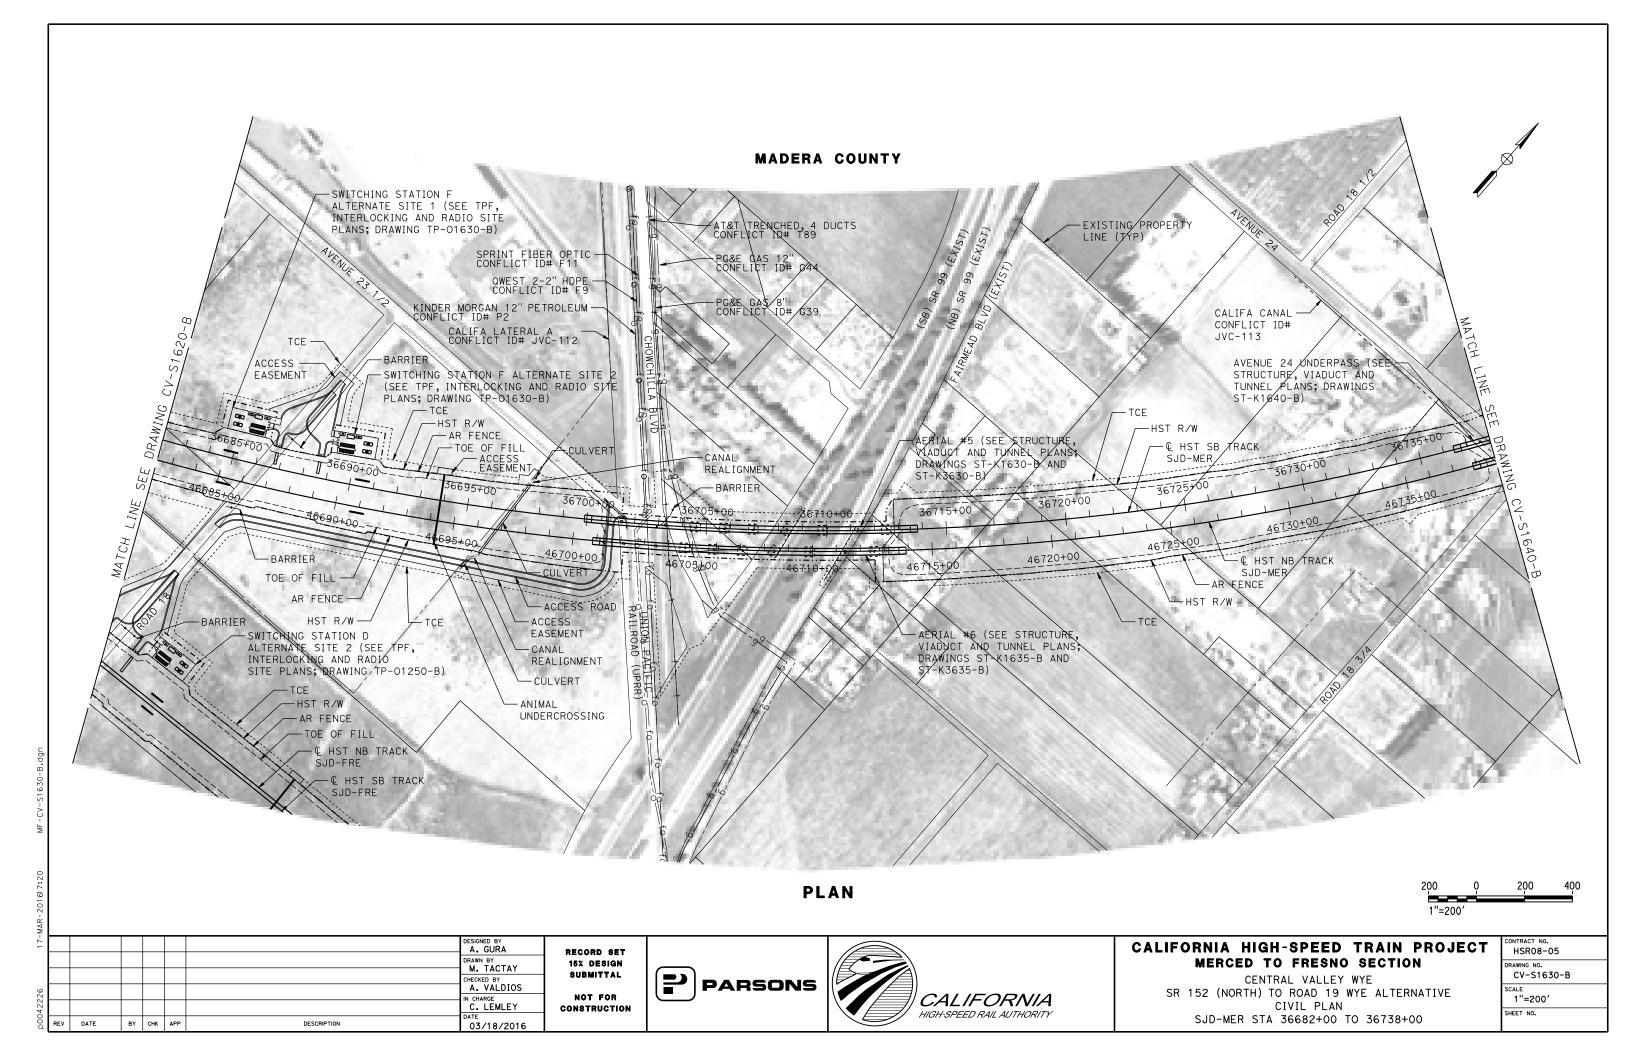
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POE 25649+00.00 19		
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Z 2564 RID		
SEE HYB		
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	200 0	200 400
	1"=200'	
NIA HIGH-SPEED TRAIN	PROJECT	CONTRACT NO. HSR08-05
ERCED TO FRESNO SECTIO CENTRAL VALLEY WYE		DRAWING NO. CV-S1570-B
2 (NORTH) TO ROAD 19 WYE ALTER CIVIL PLAN	NATIVE	SCALE 1"=200'
ER-FRE STA 15611+00 TO 15655+0	00	SHEET NO.





07-SEP-201610:24 MF-CV-S1610-E






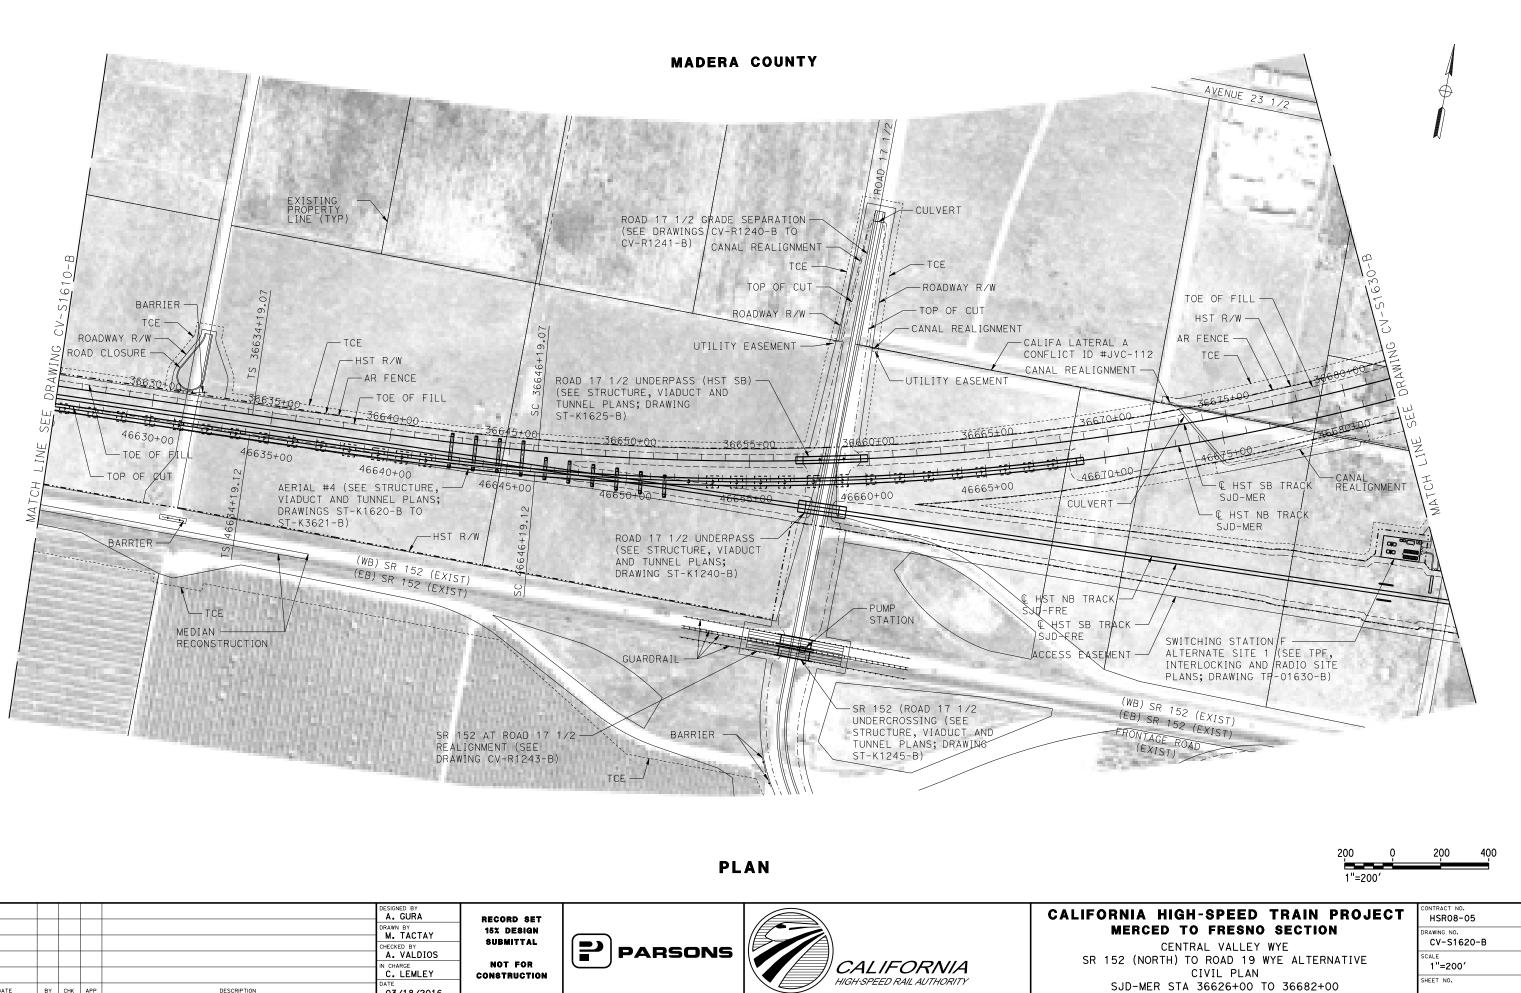


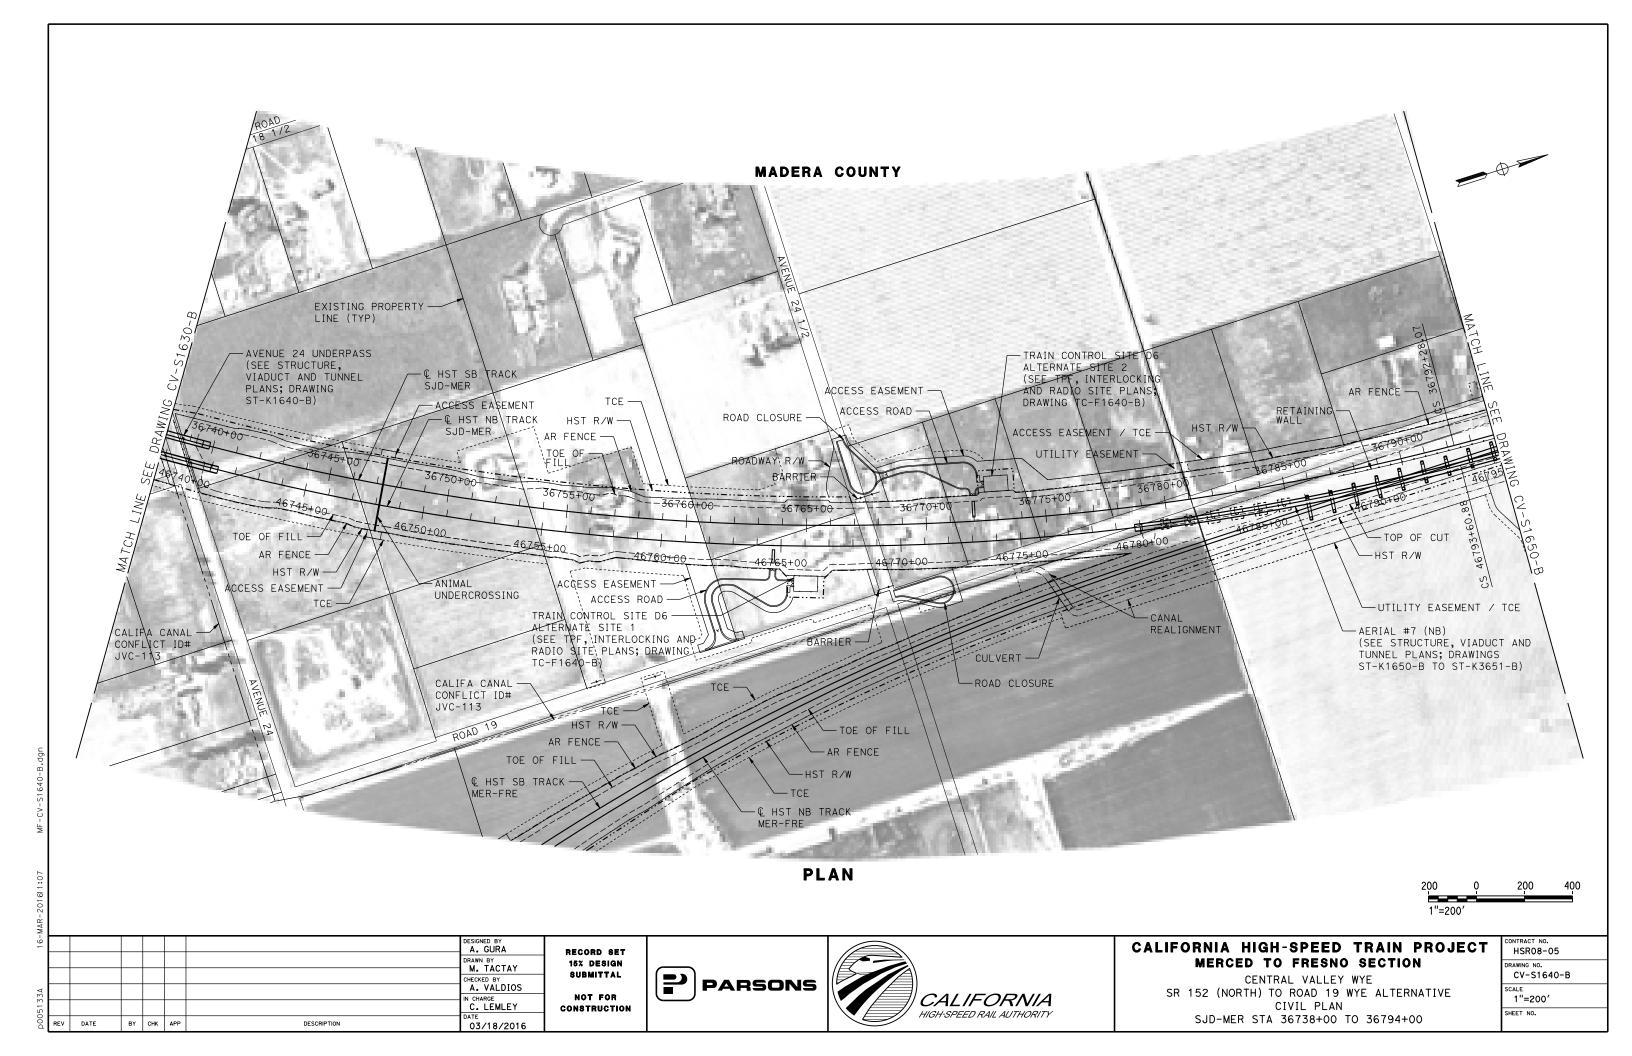

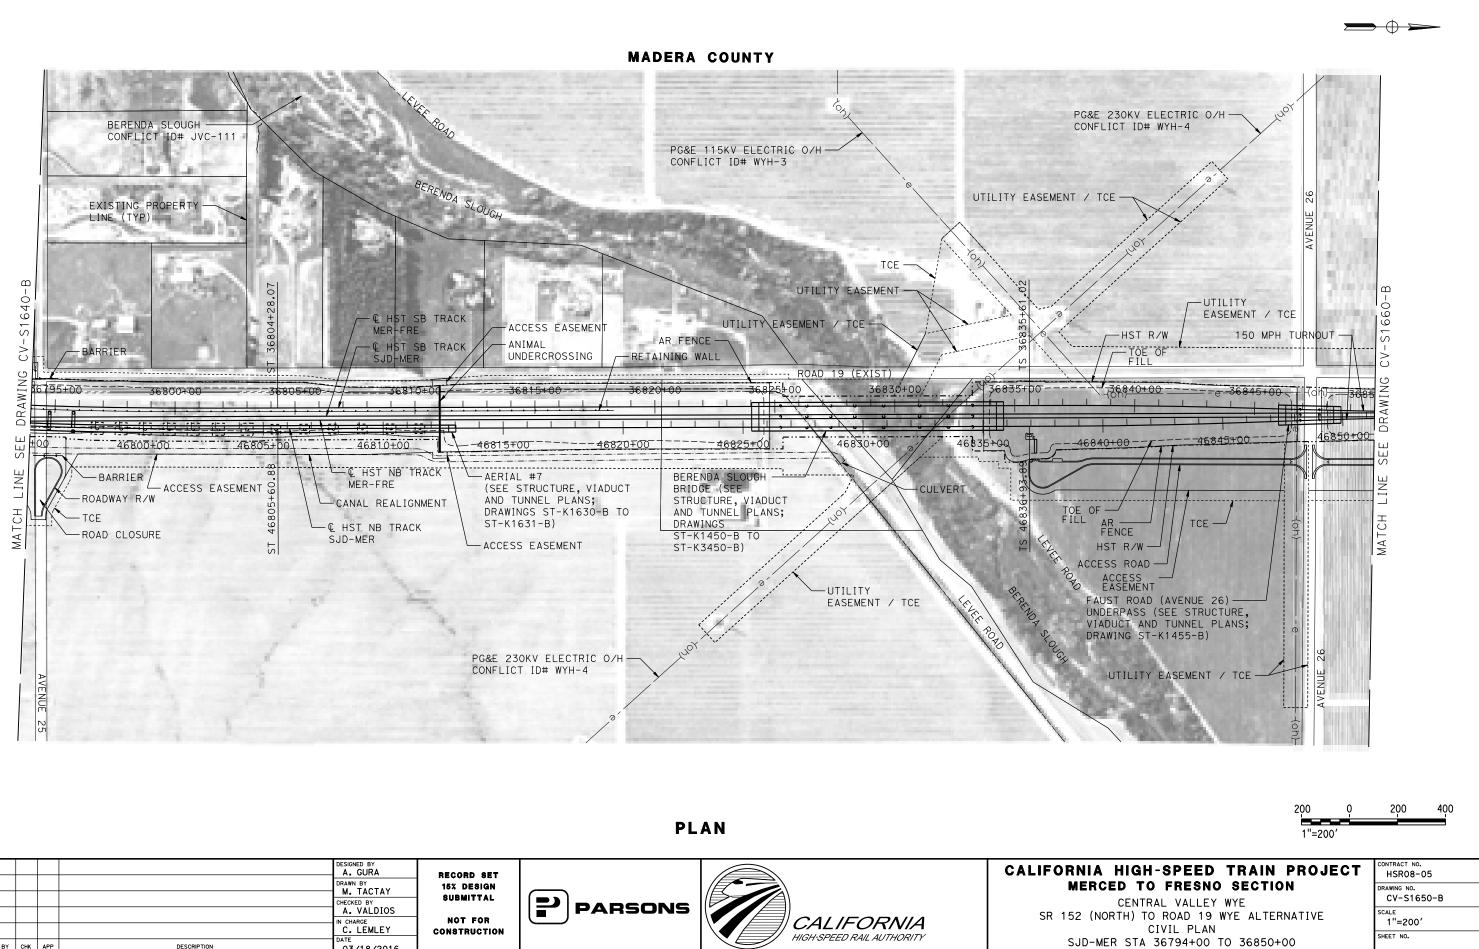


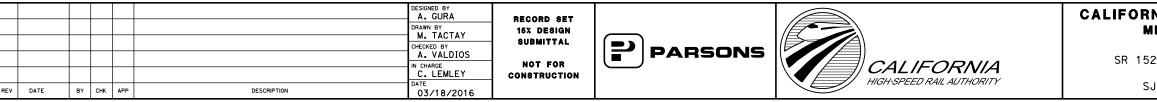

MADERA COUNTY

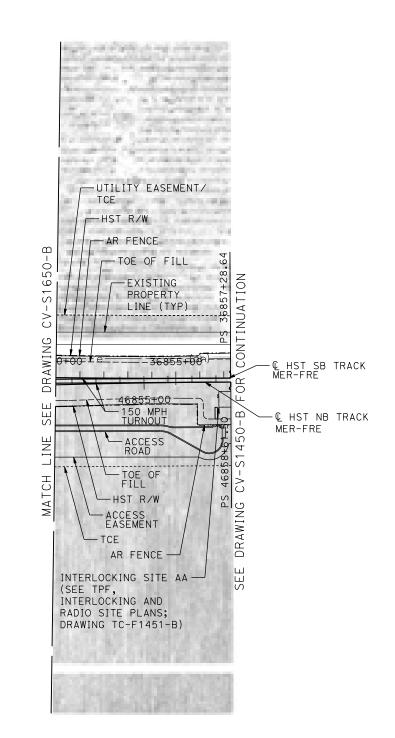




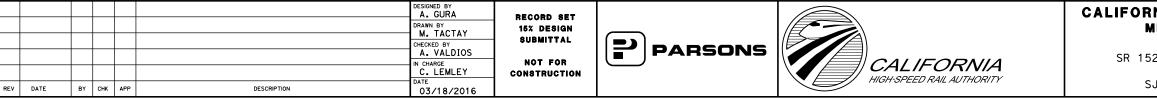


17-MAR-201617:23 MF-CV-S1660-B.

200 0 1"=200'	200 400
RNIA HIGH-SPEED TRAIN PROJECT MERCED TO FRESNO SECTION CENTRAL VALLEY WYE 52 (NORTH) TO ROAD 19 WYE ALTERNATIVE	CONTRACT NO. HSR08-05 DRAWING NO. CV-S1660-B SCALE
CIVIL PLAN SJD-MER STA 36850+00 TO 36857+29	1"=200' SHEET NO.


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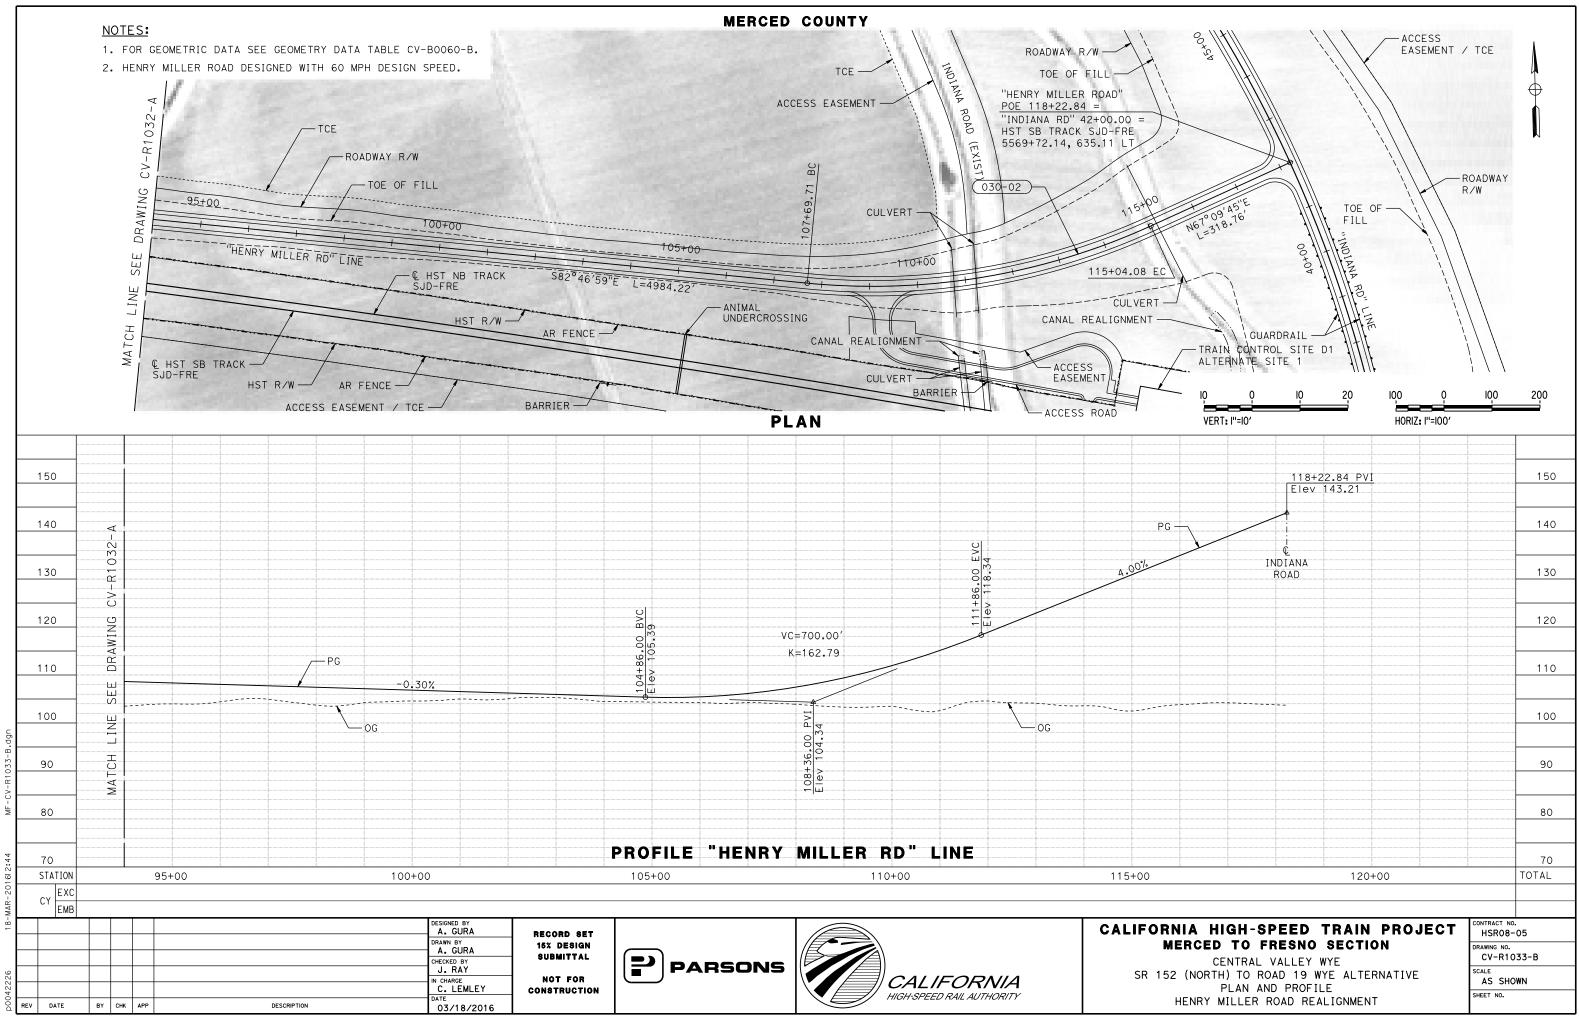


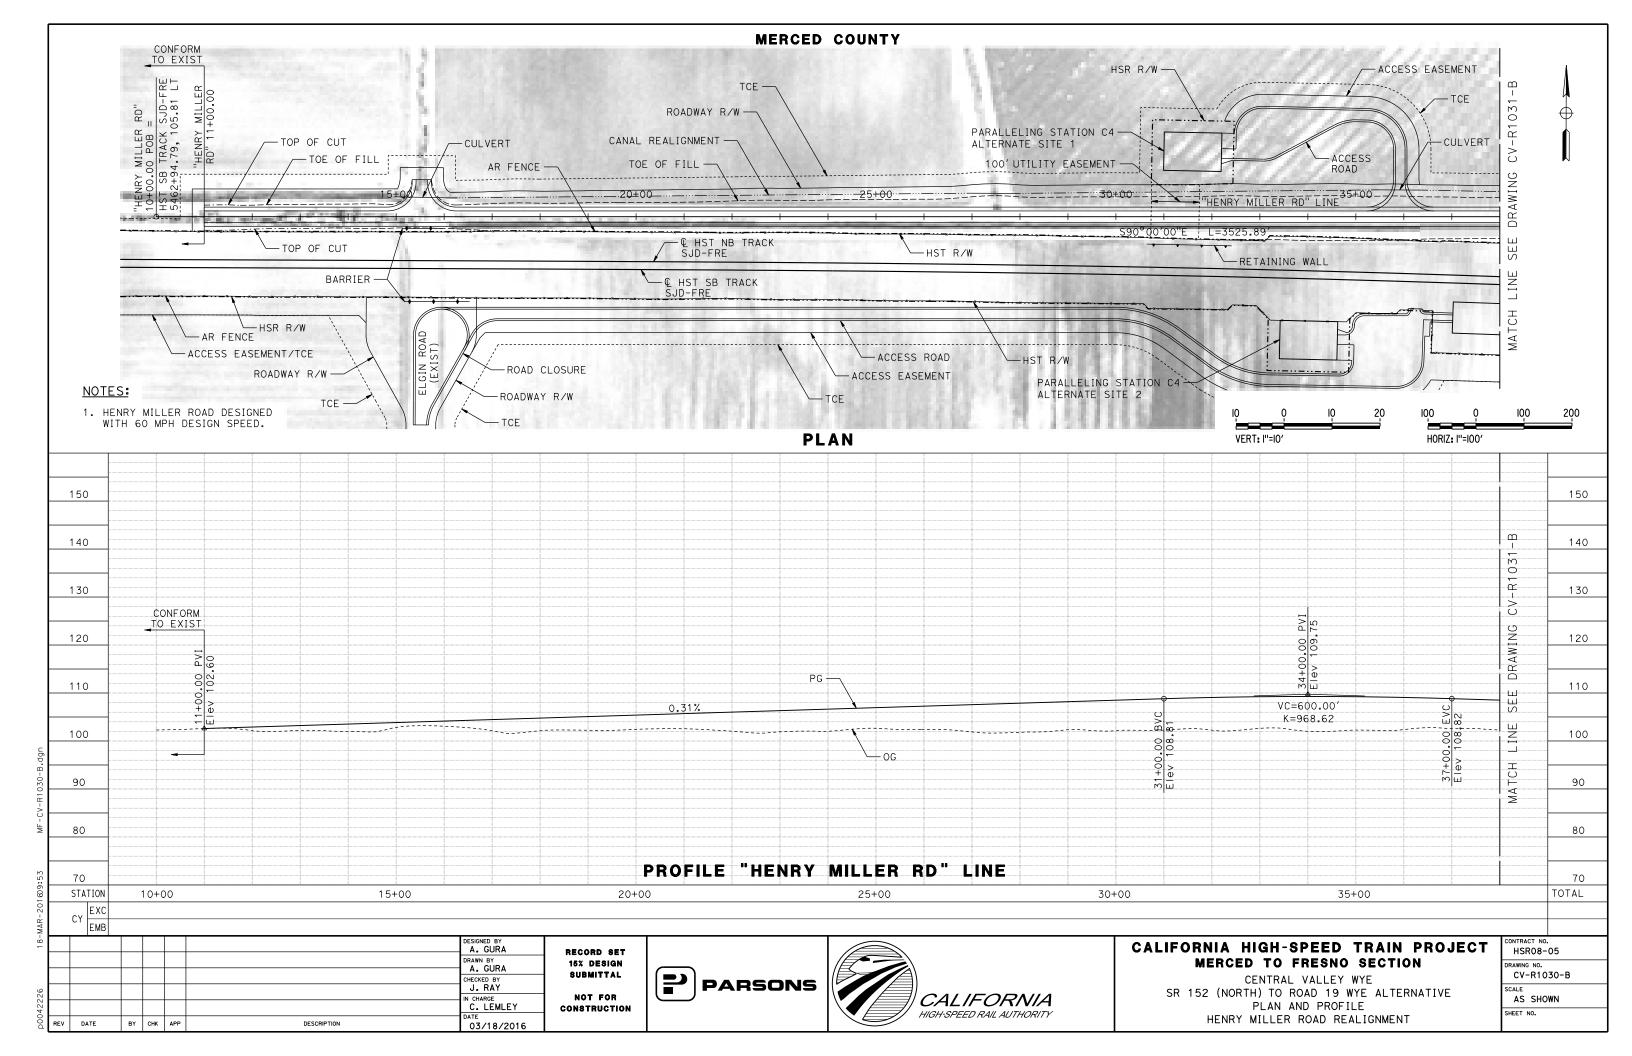


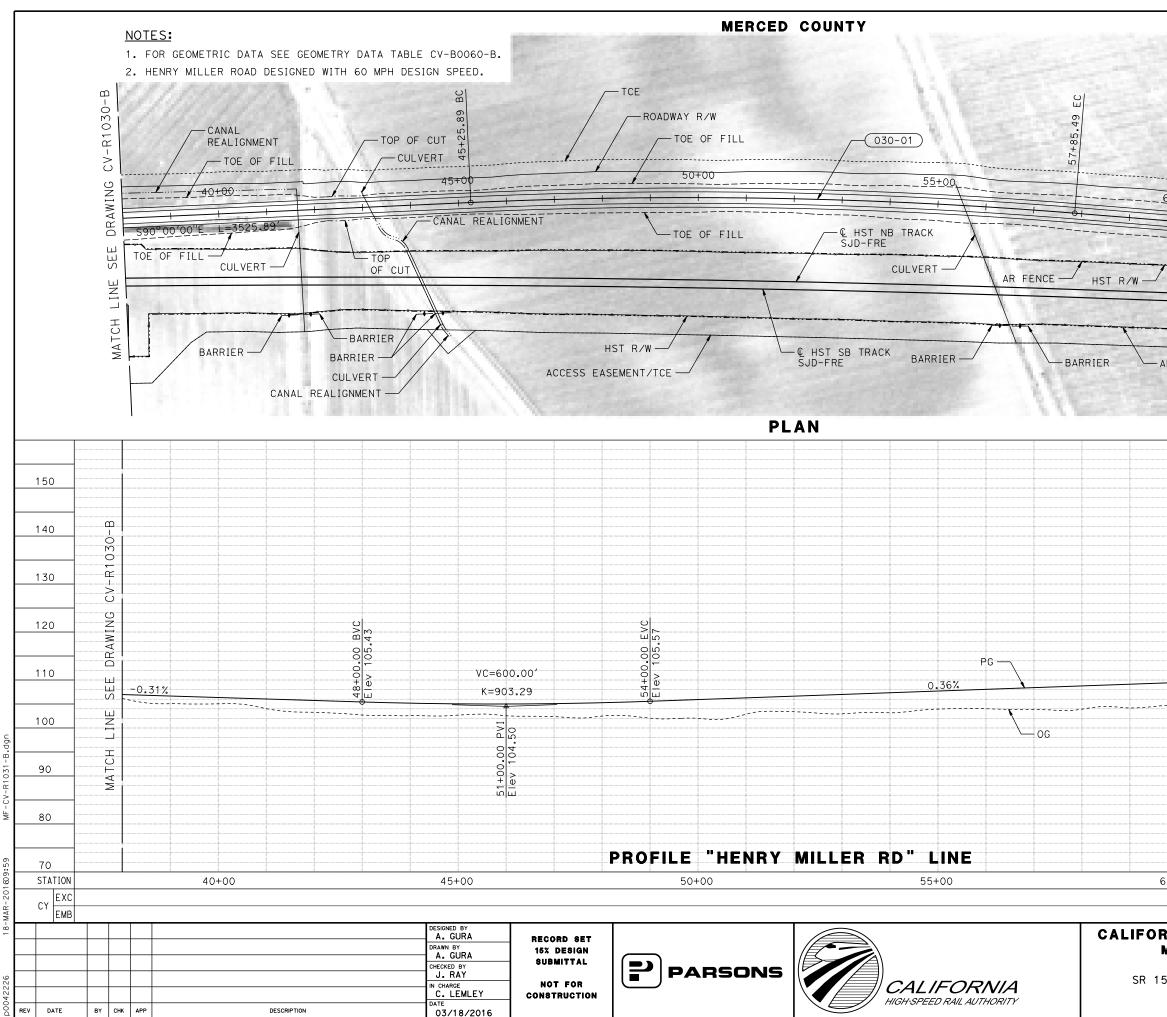
SR 15


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	GH-SP To Fr				ECT	CONTRACT NO HSR08- DRAWING NO.	-05
	NTRAL V					CV-R1031-B SCALE AS SHOWN	




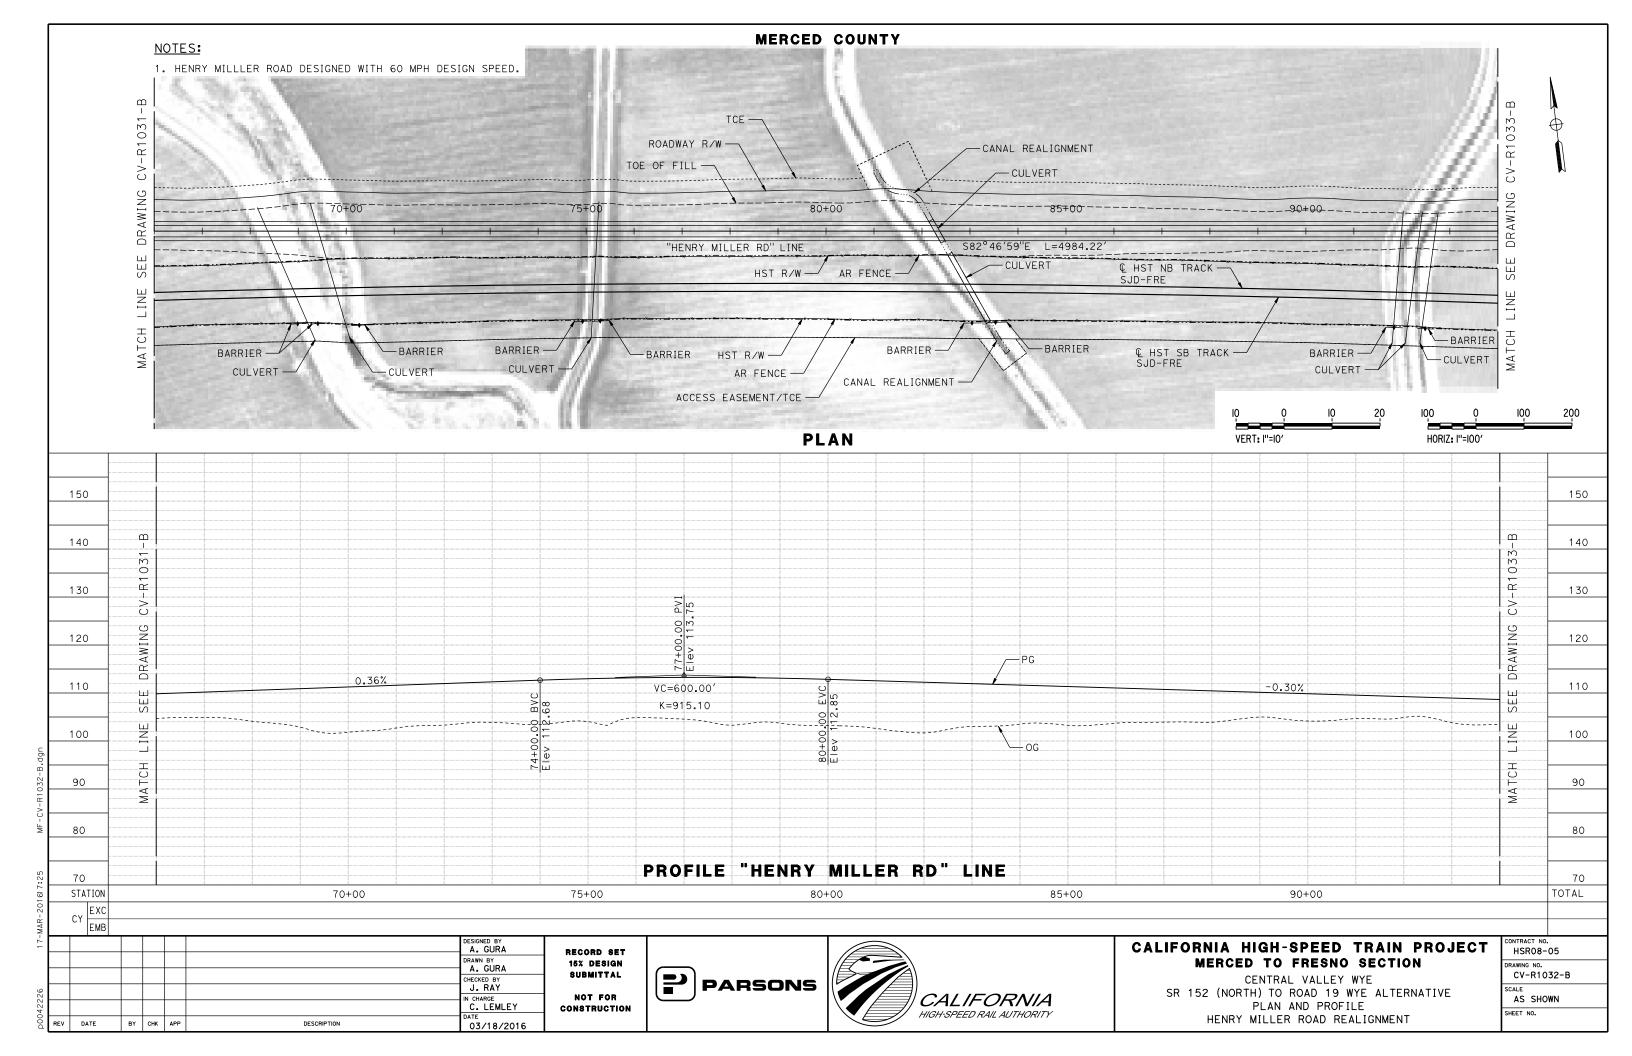


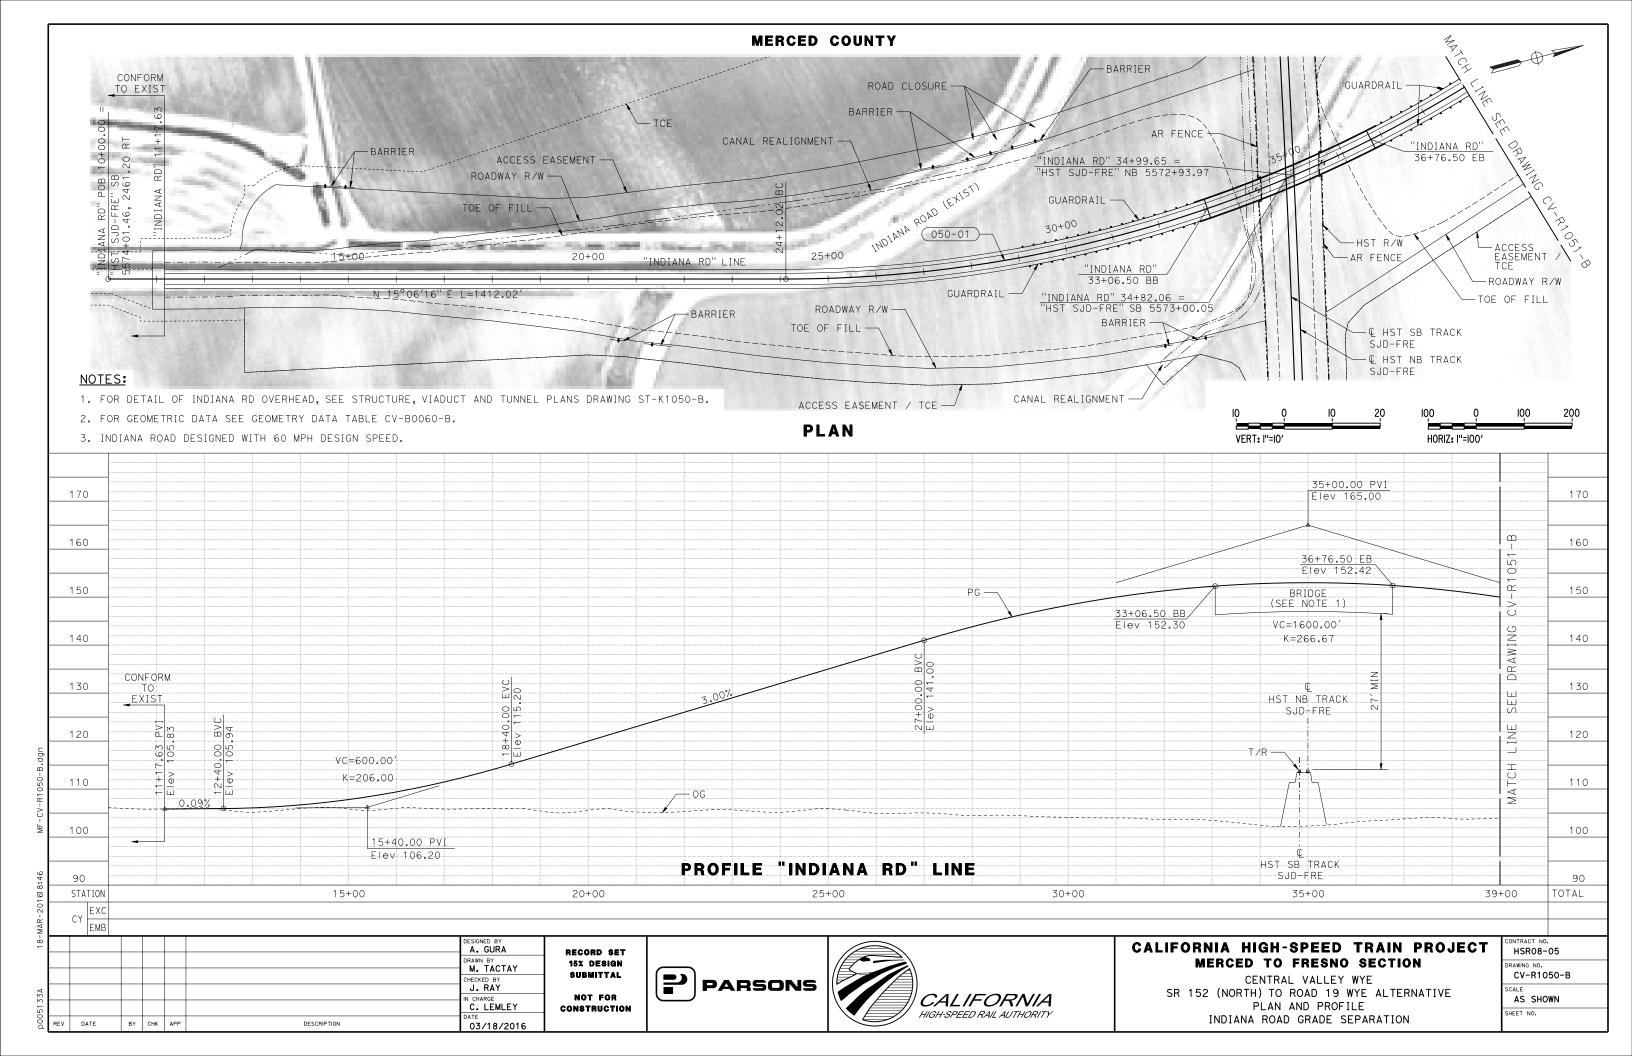


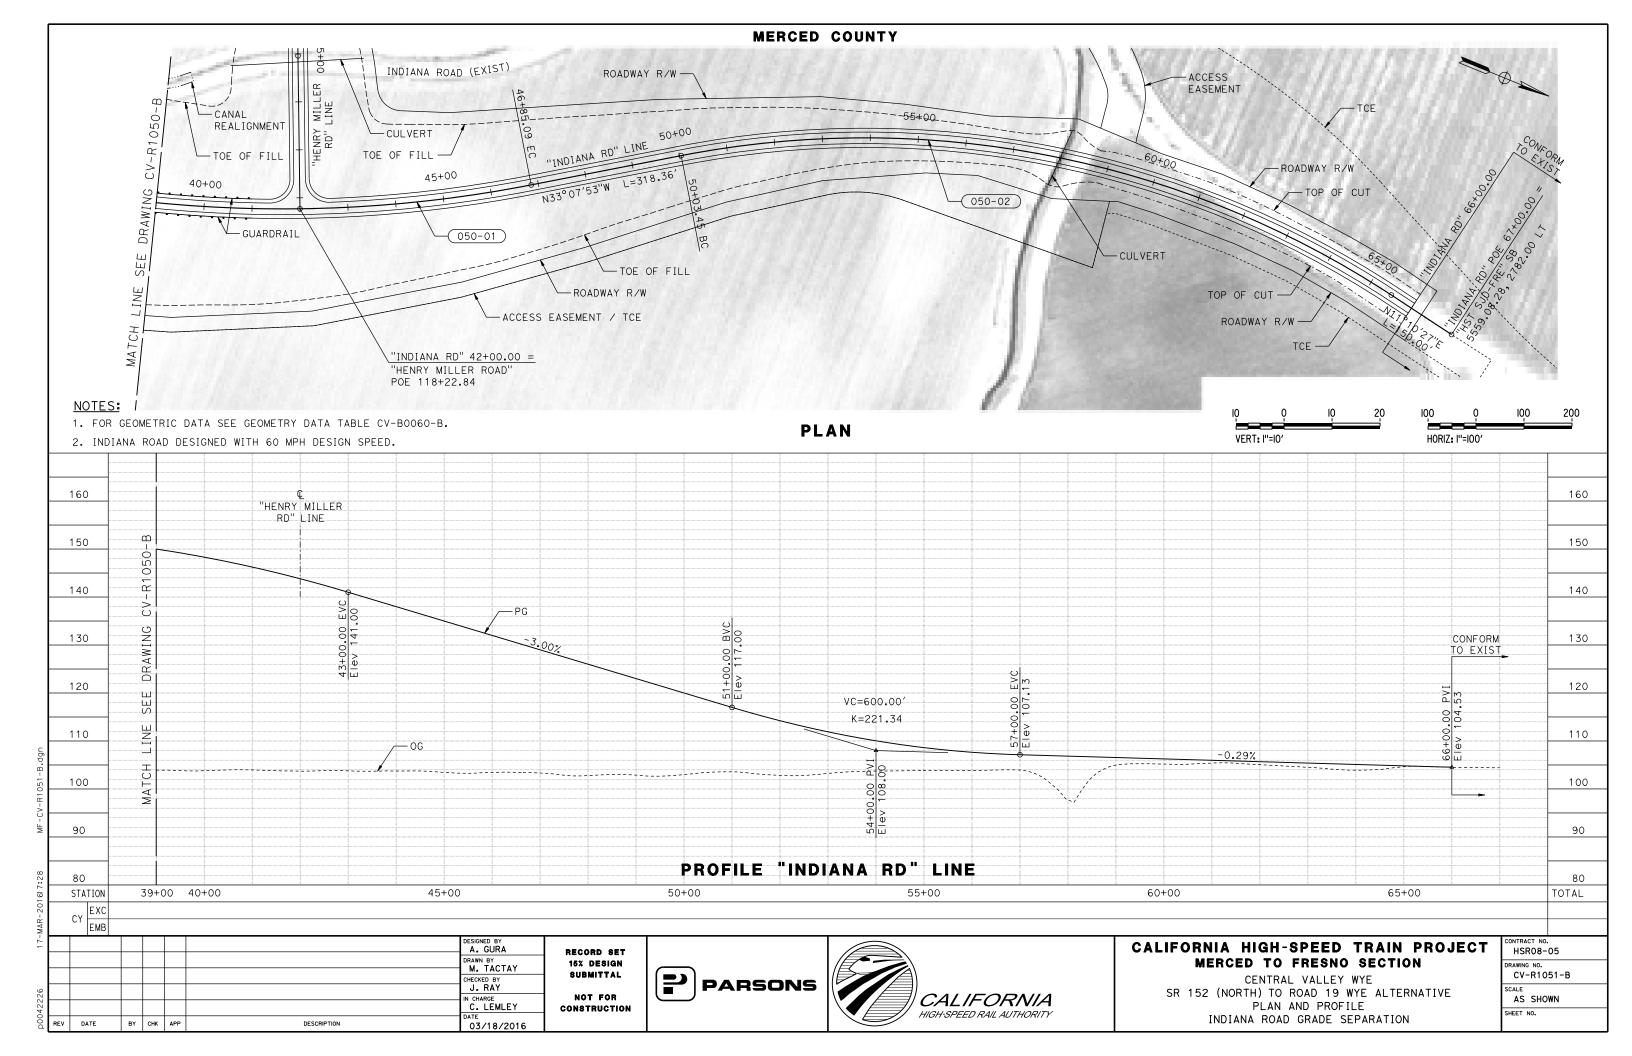

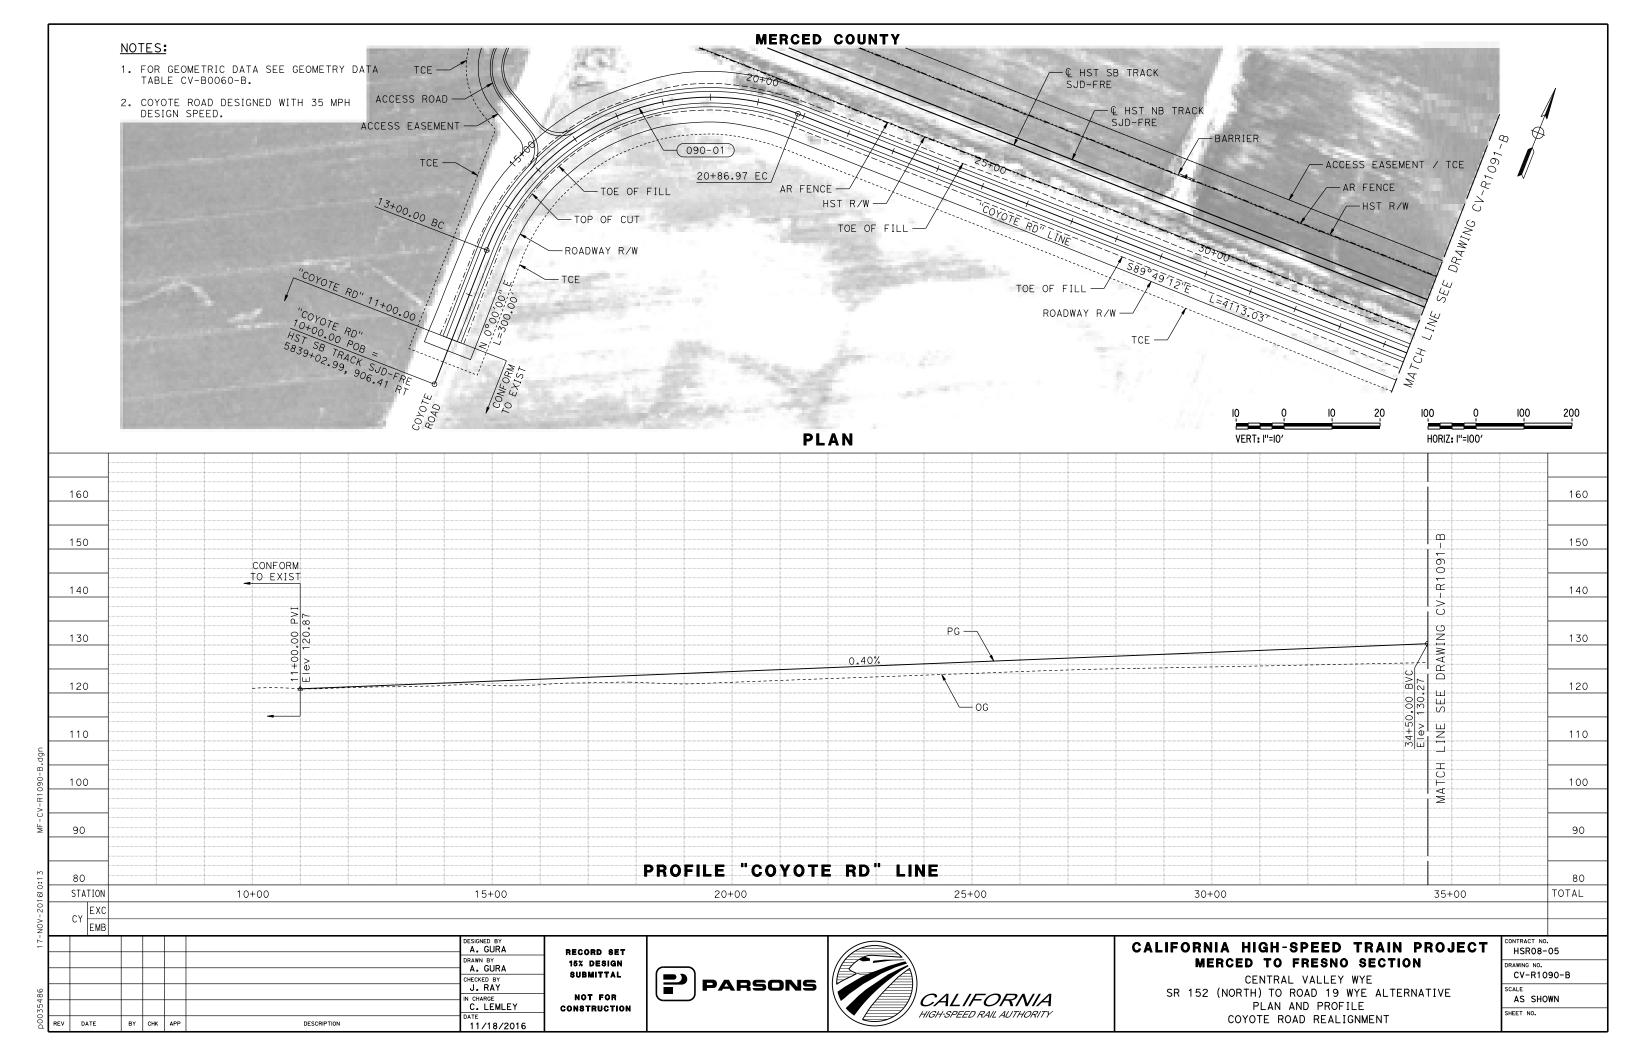


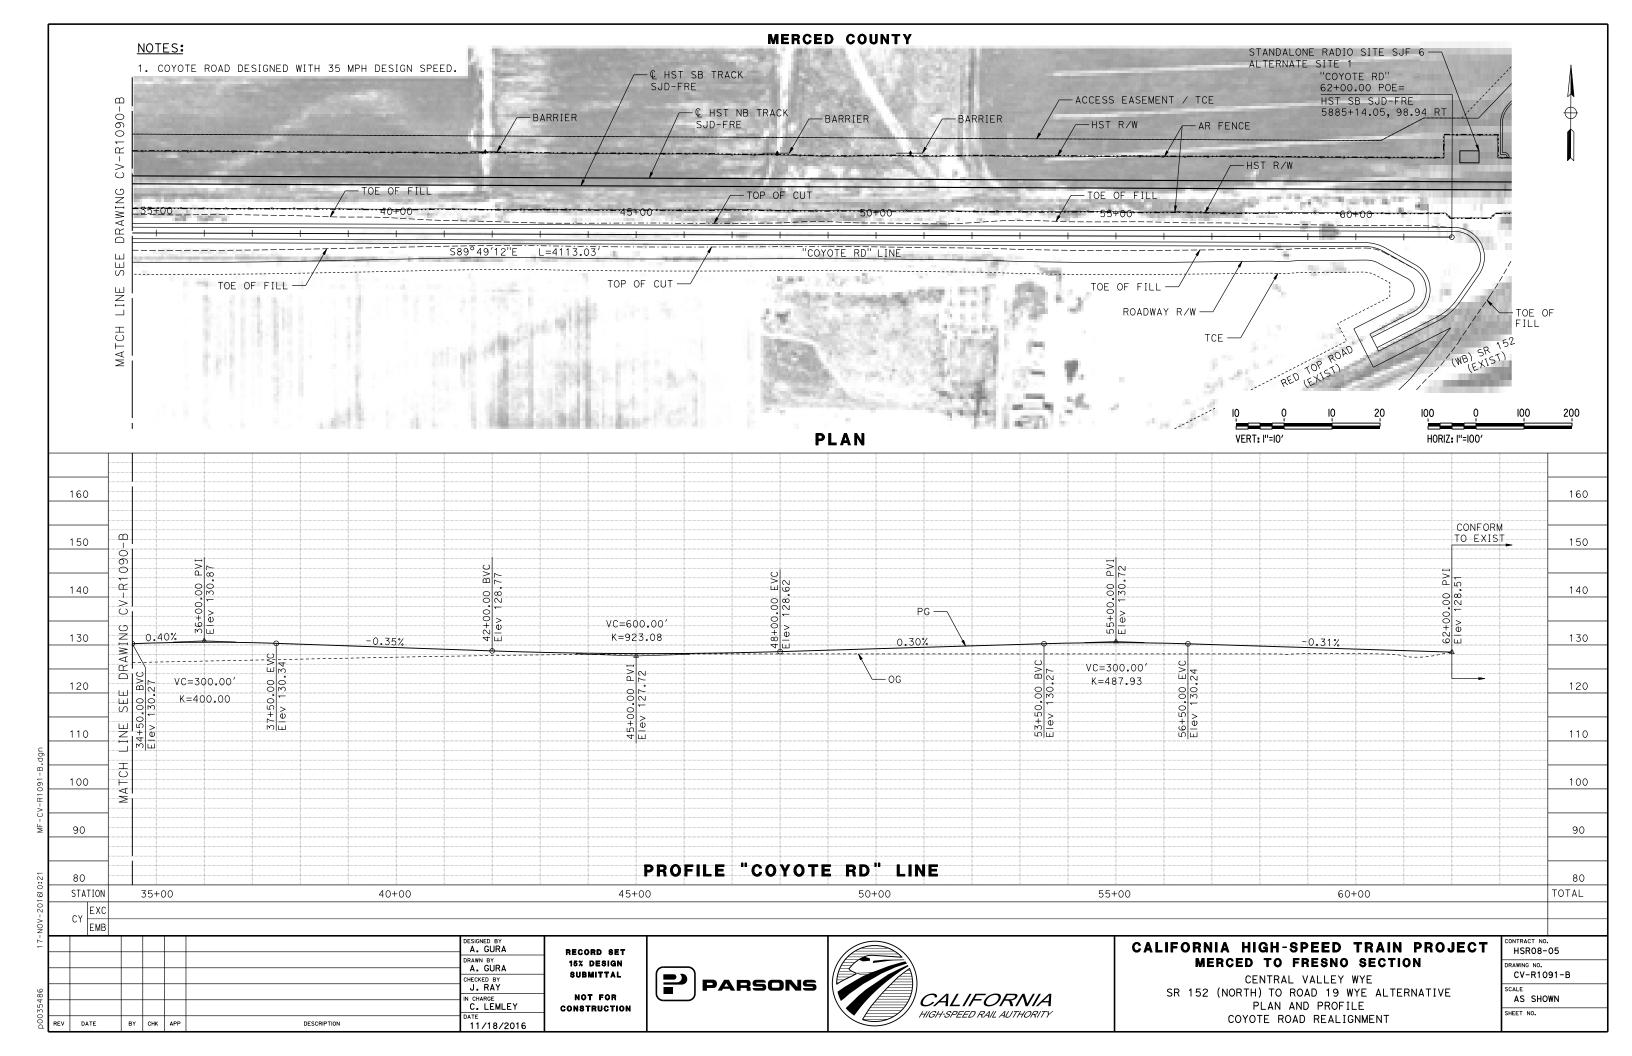


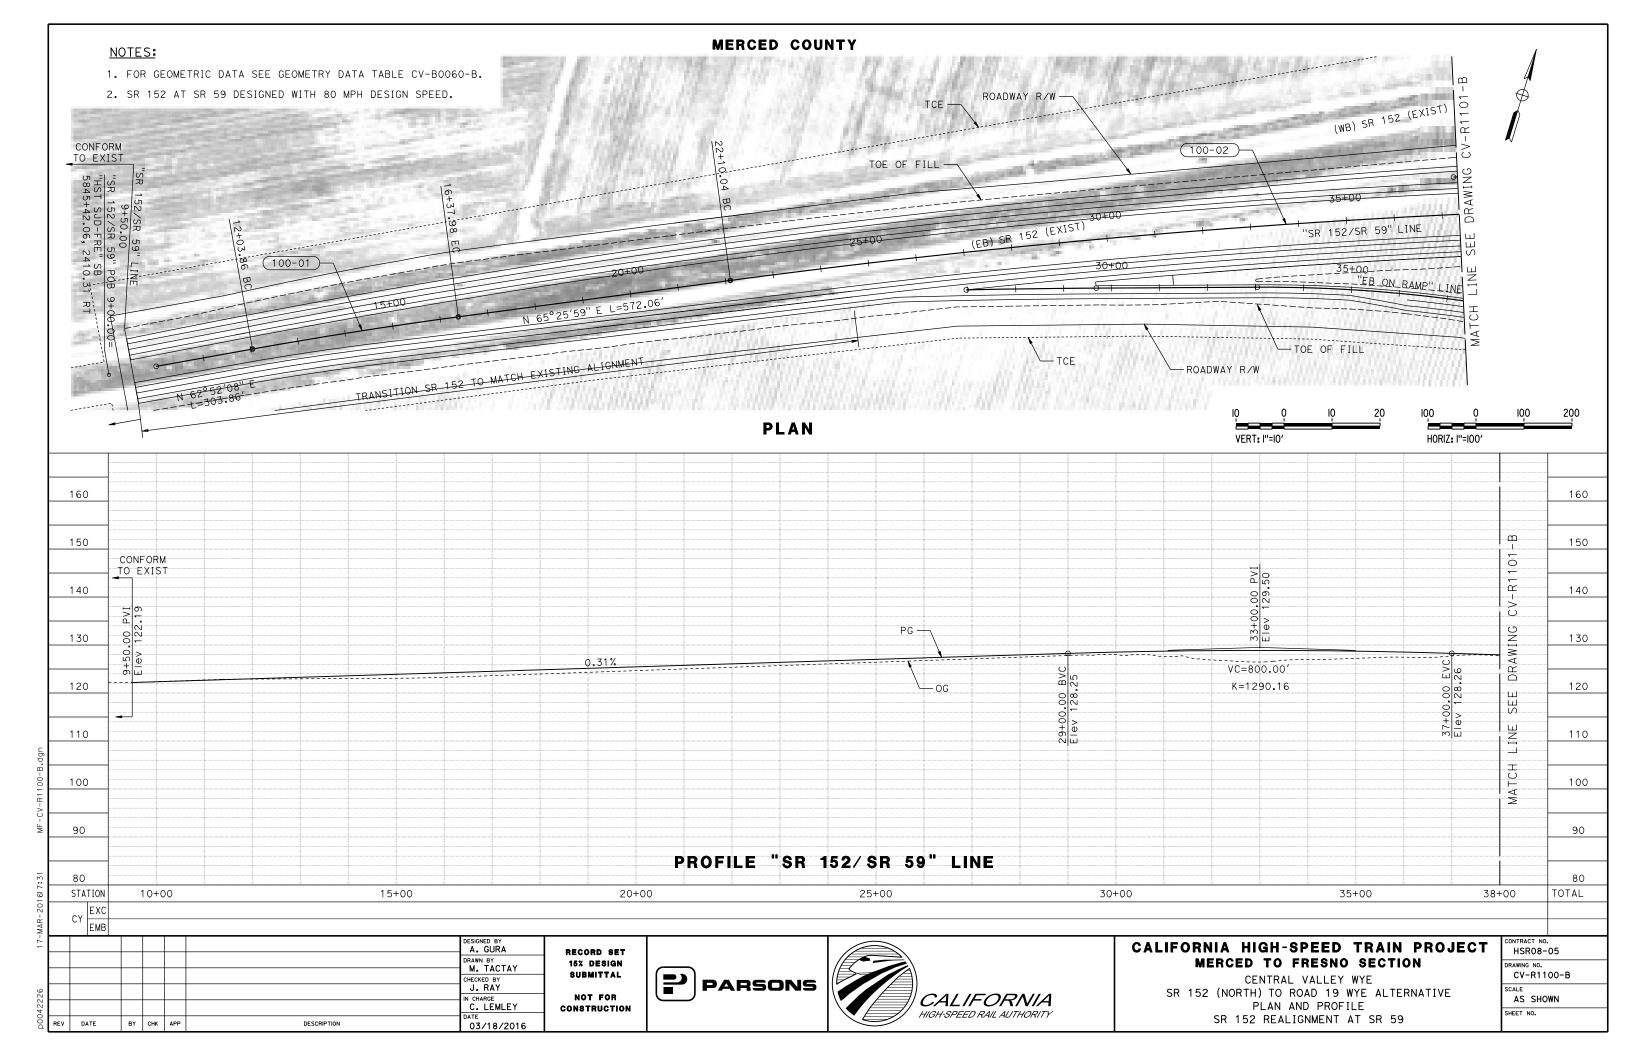

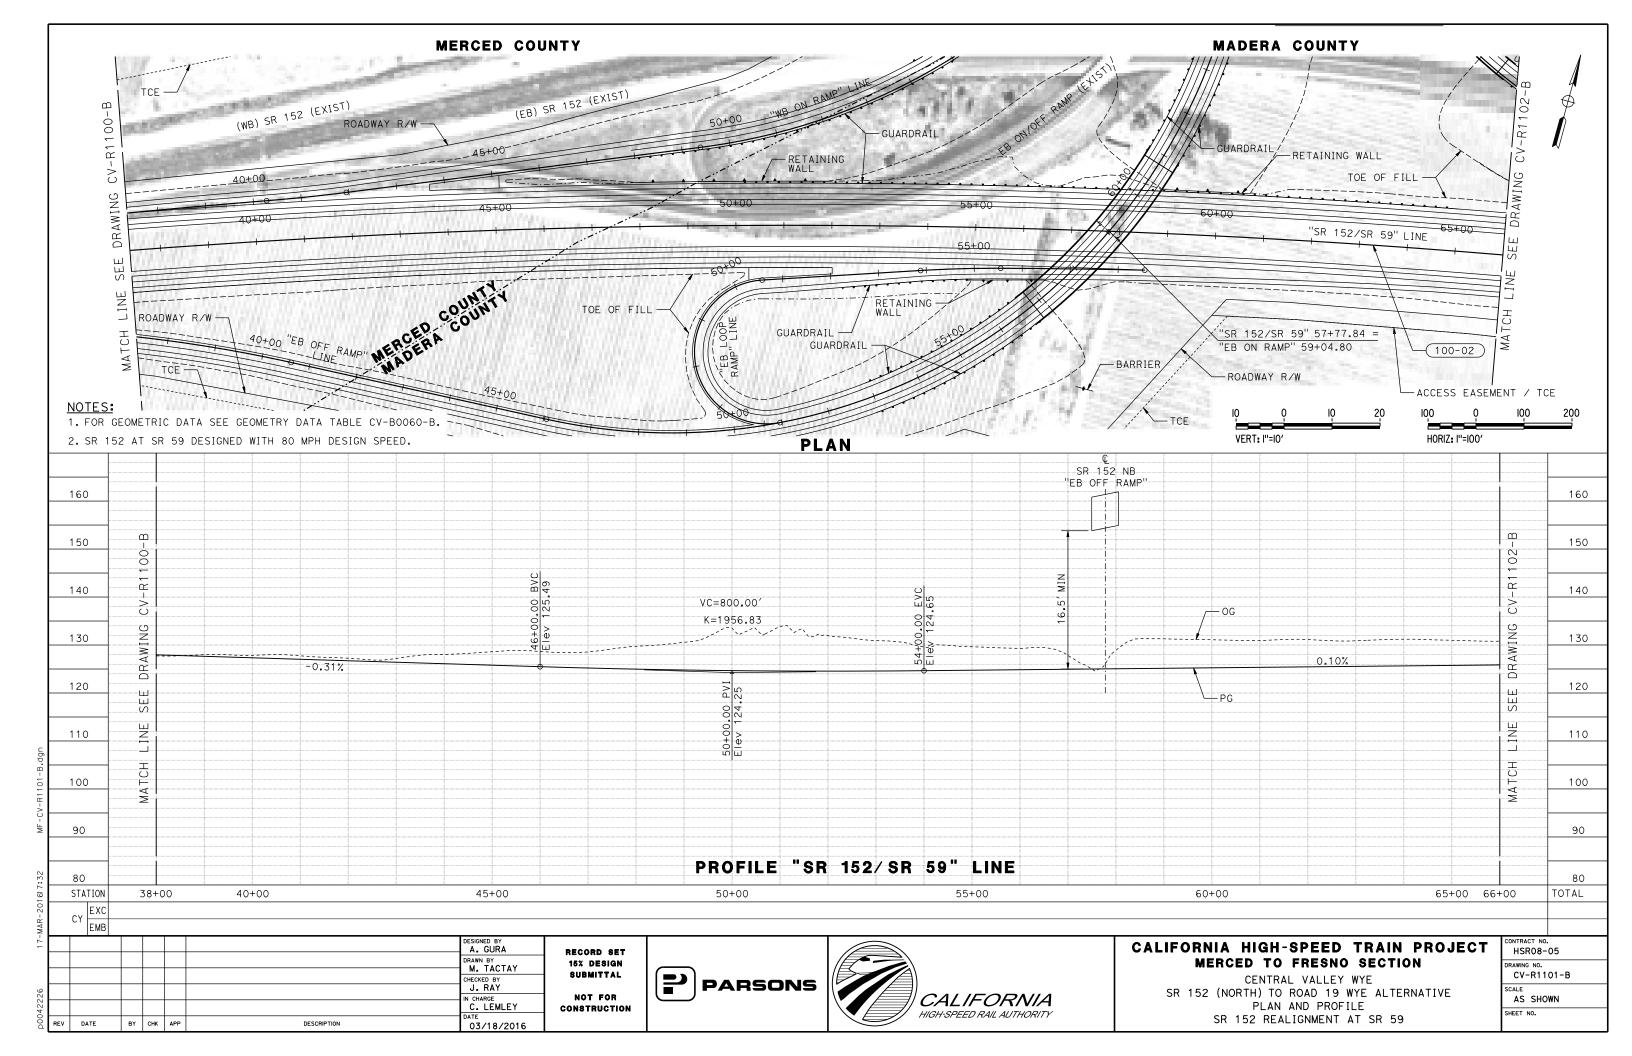



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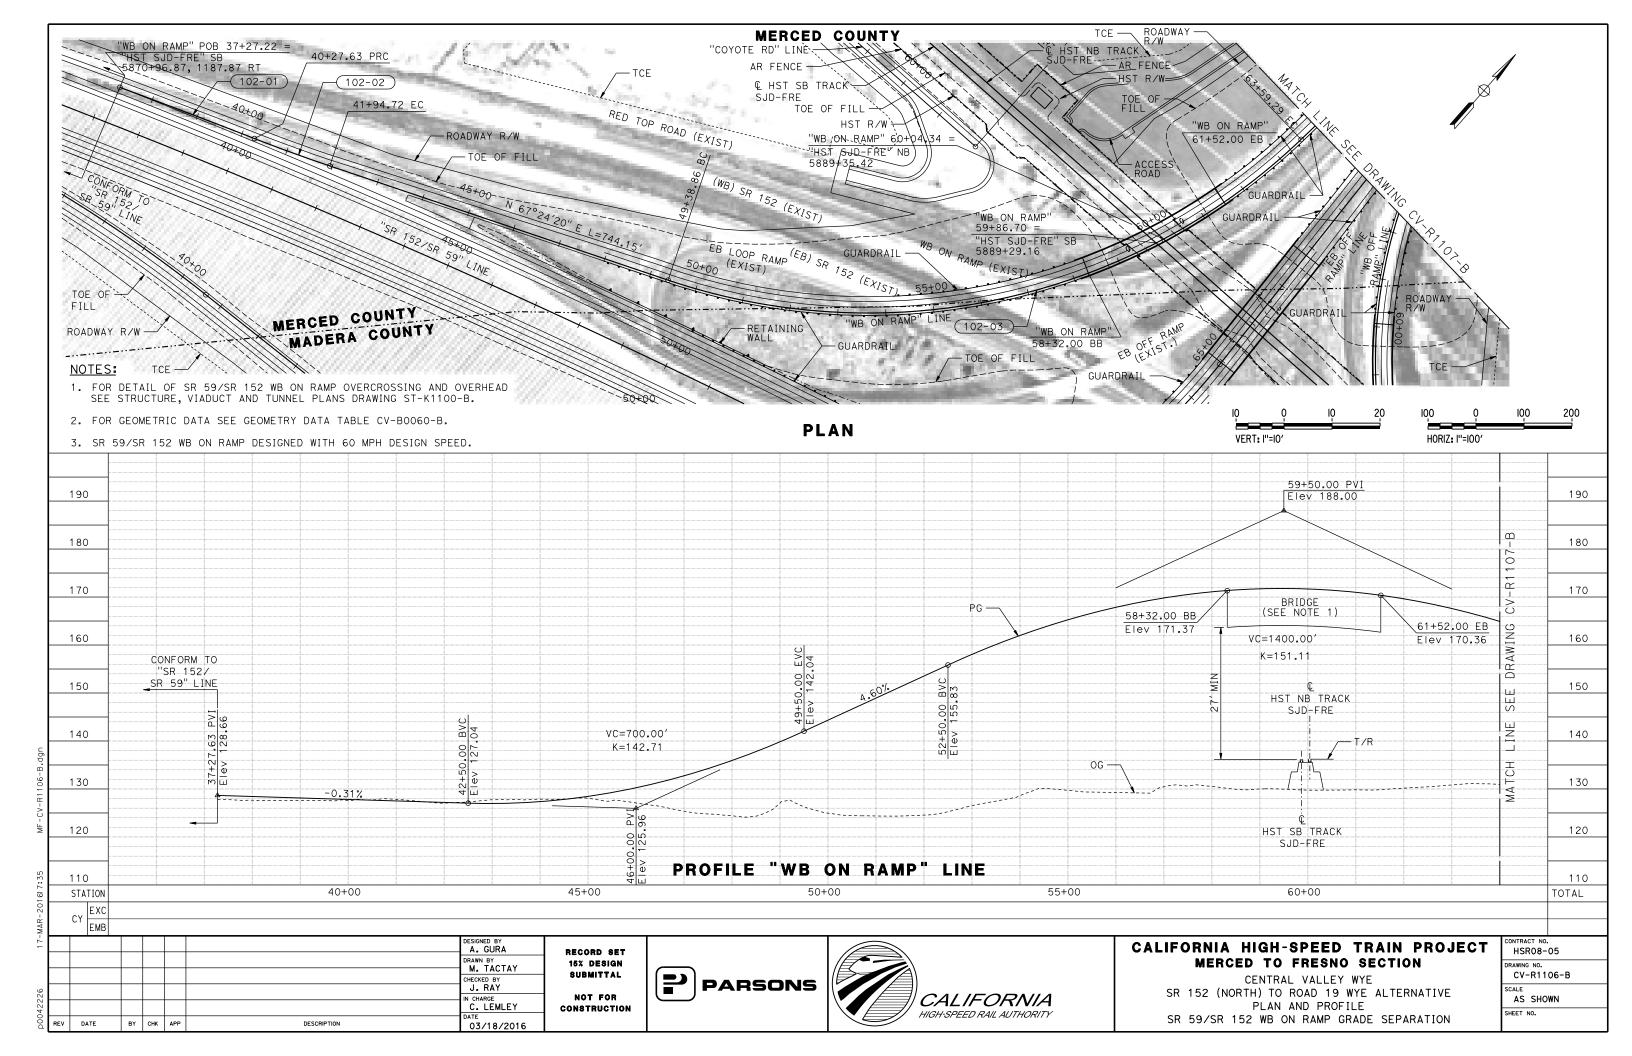


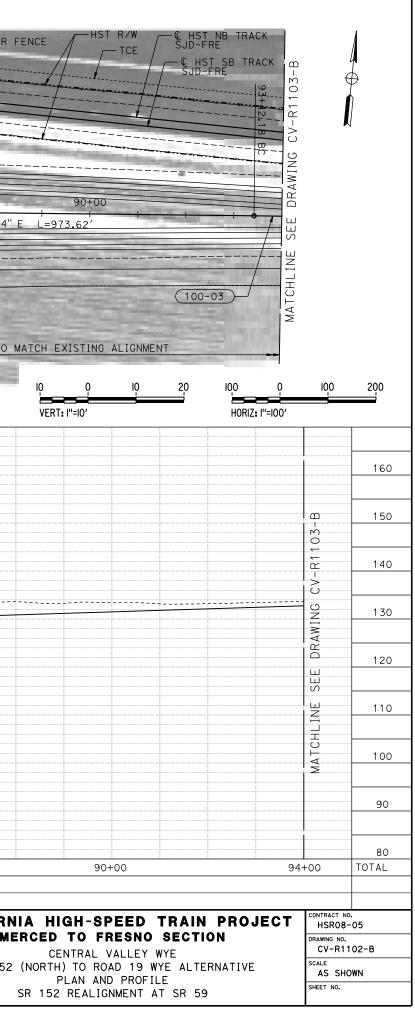

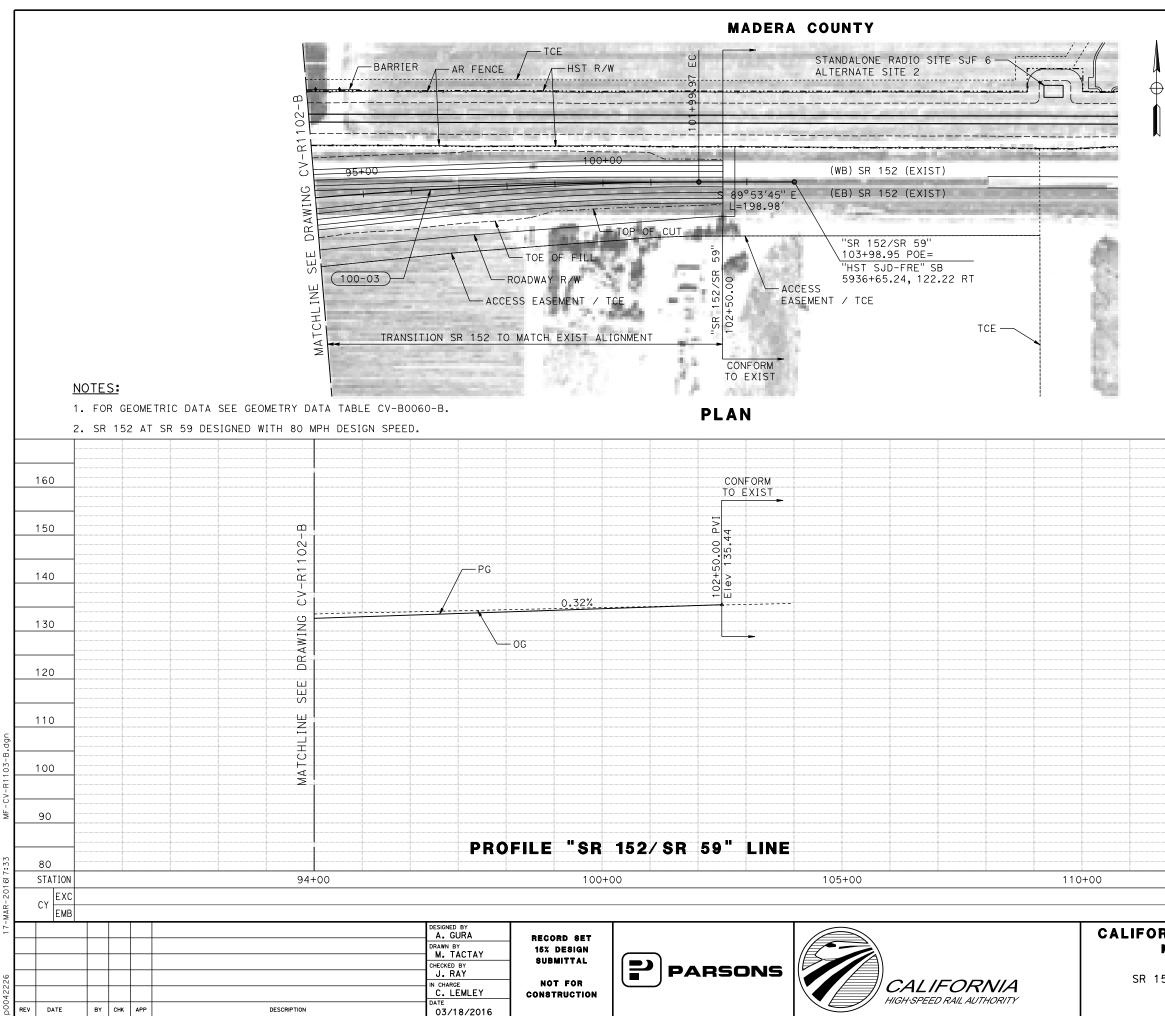
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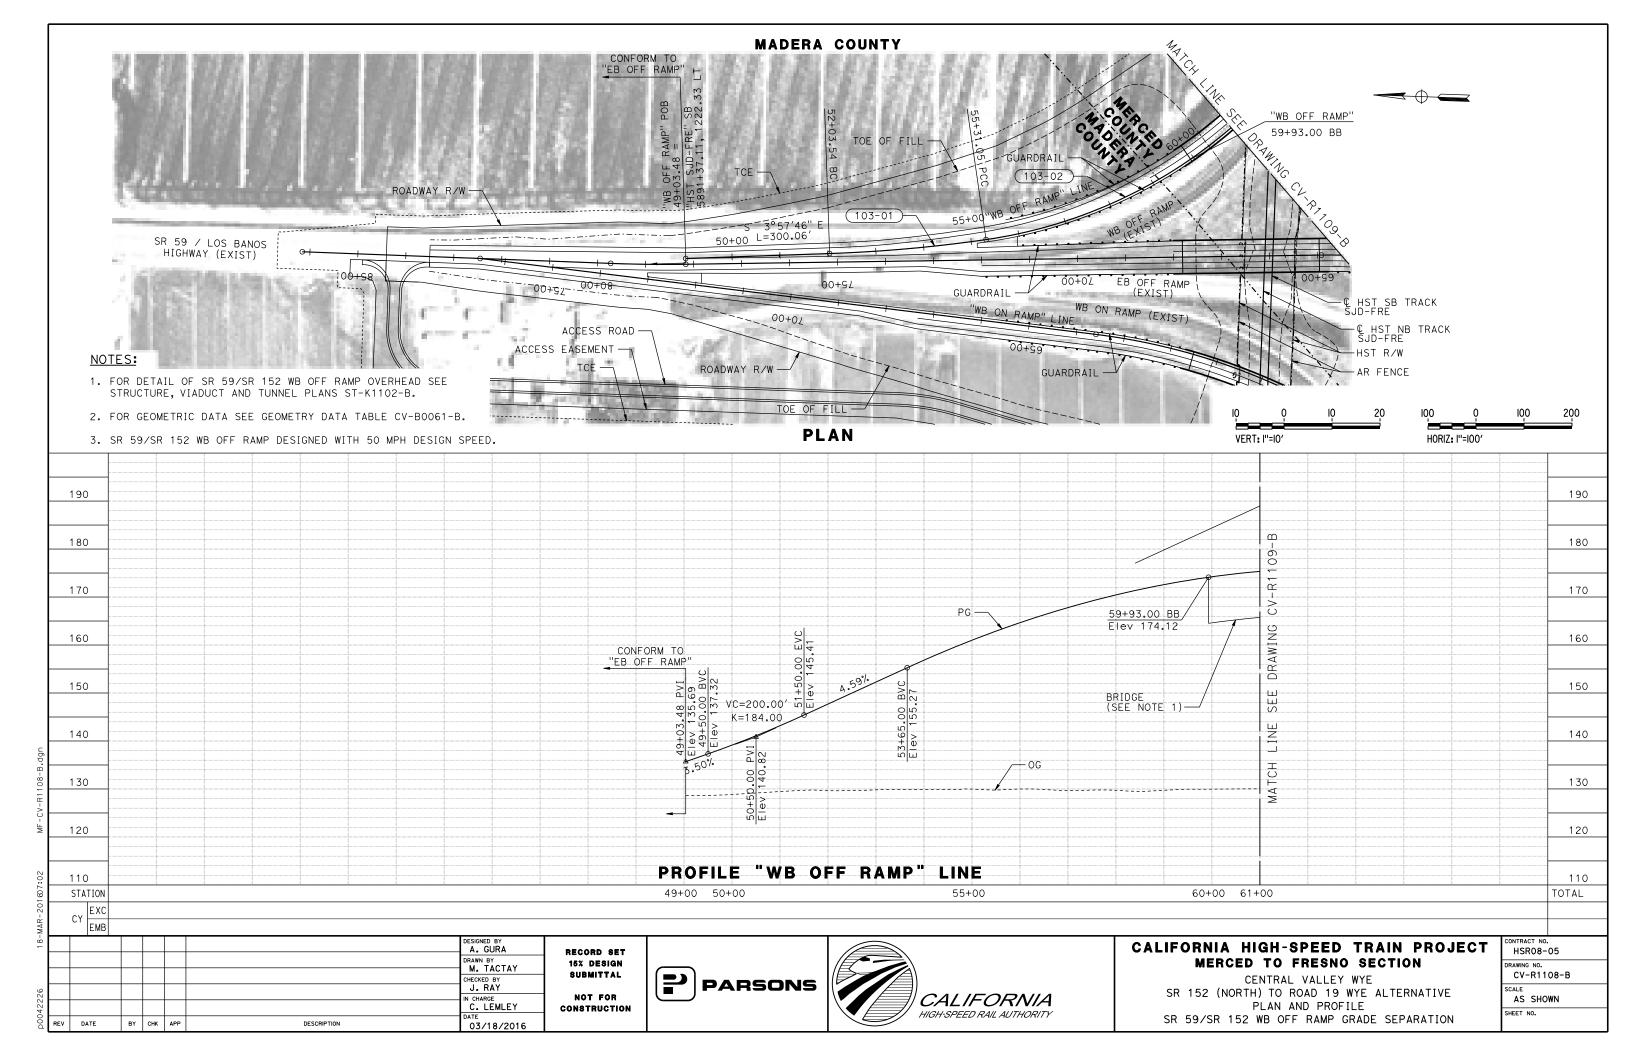





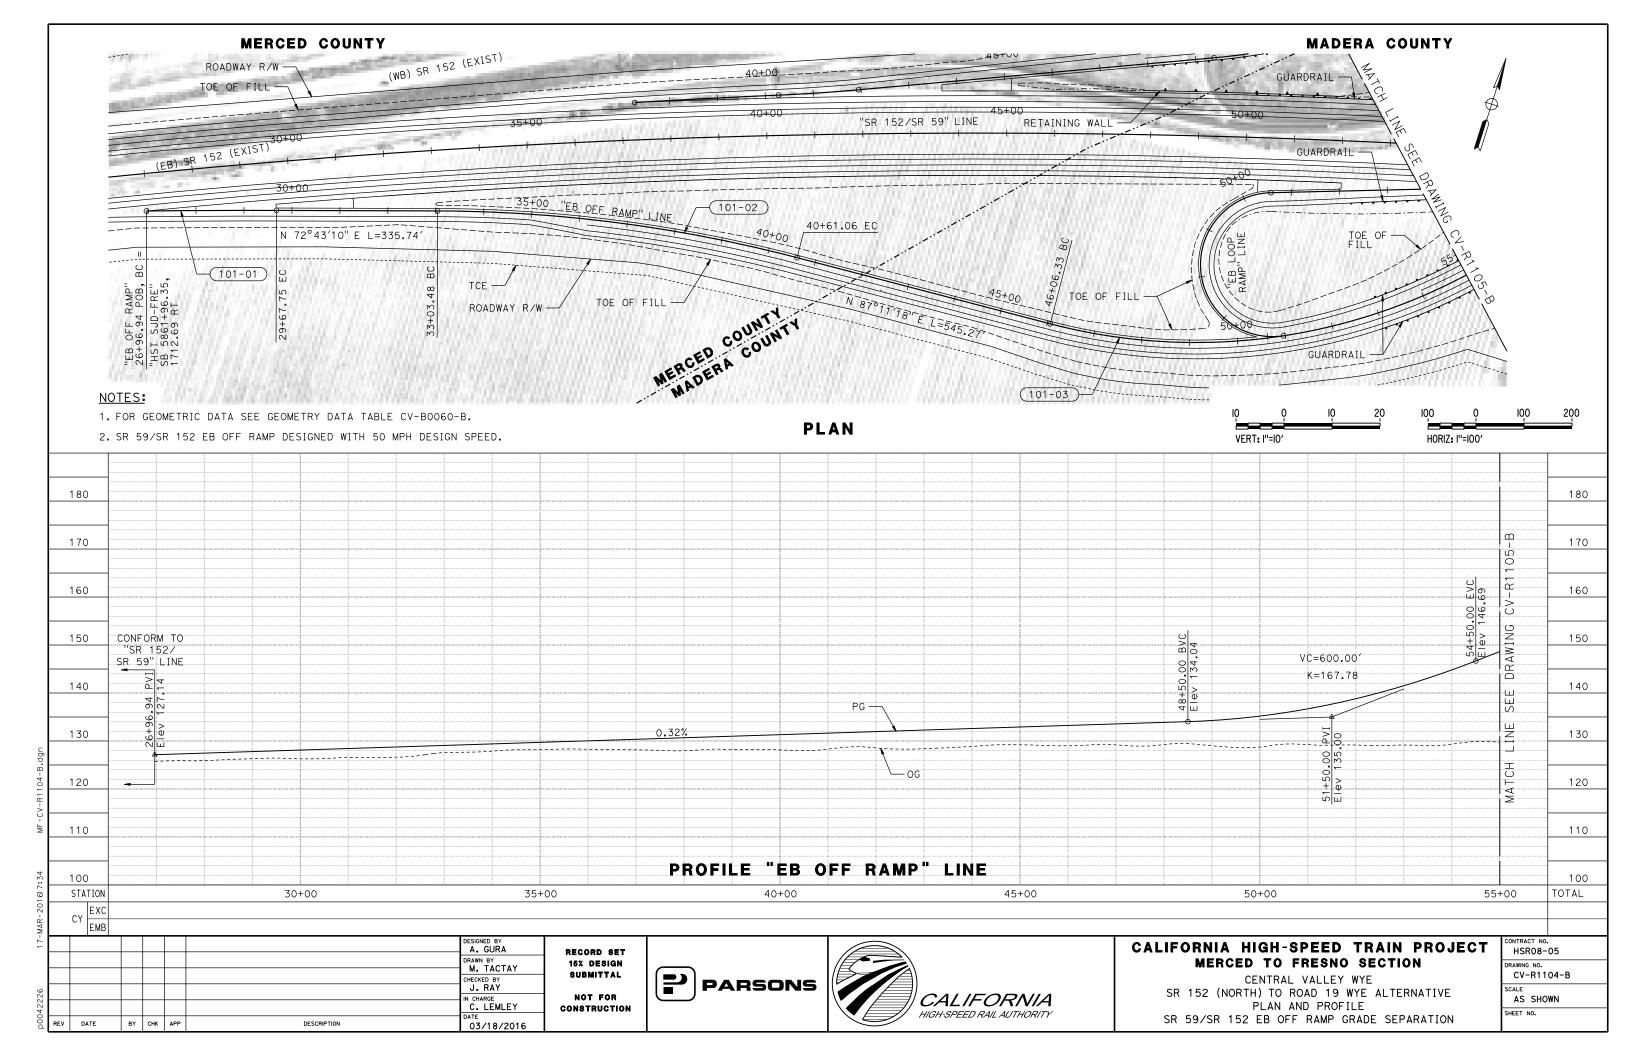


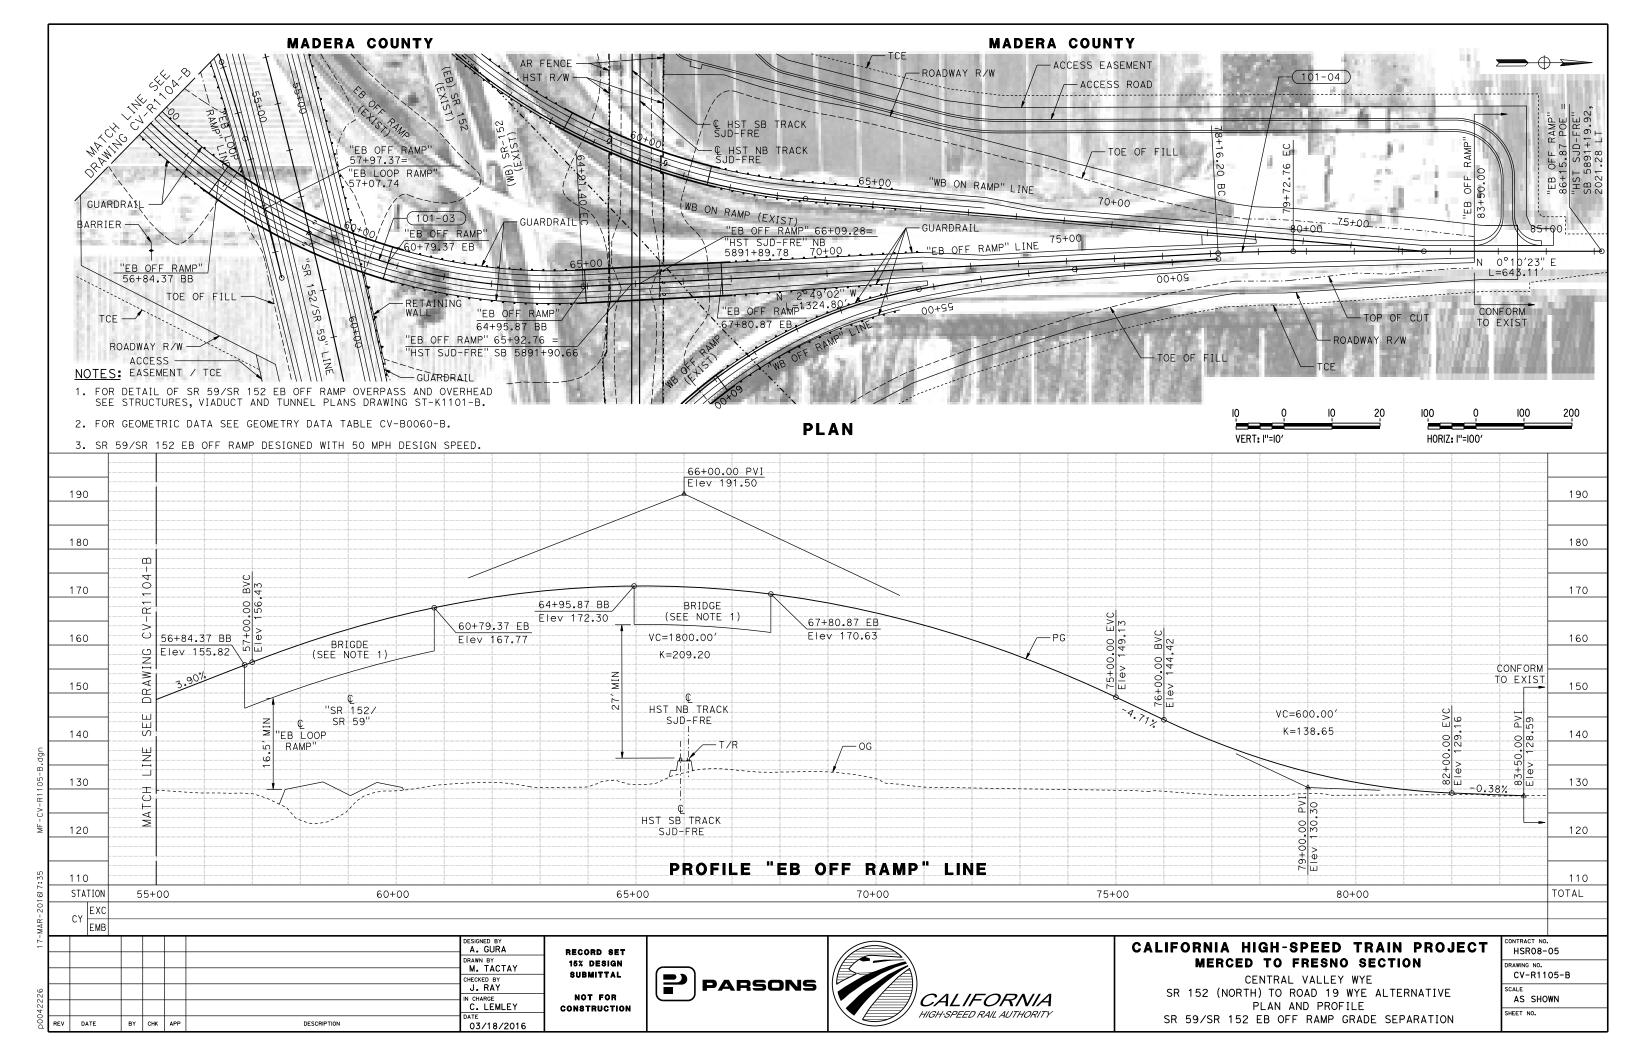


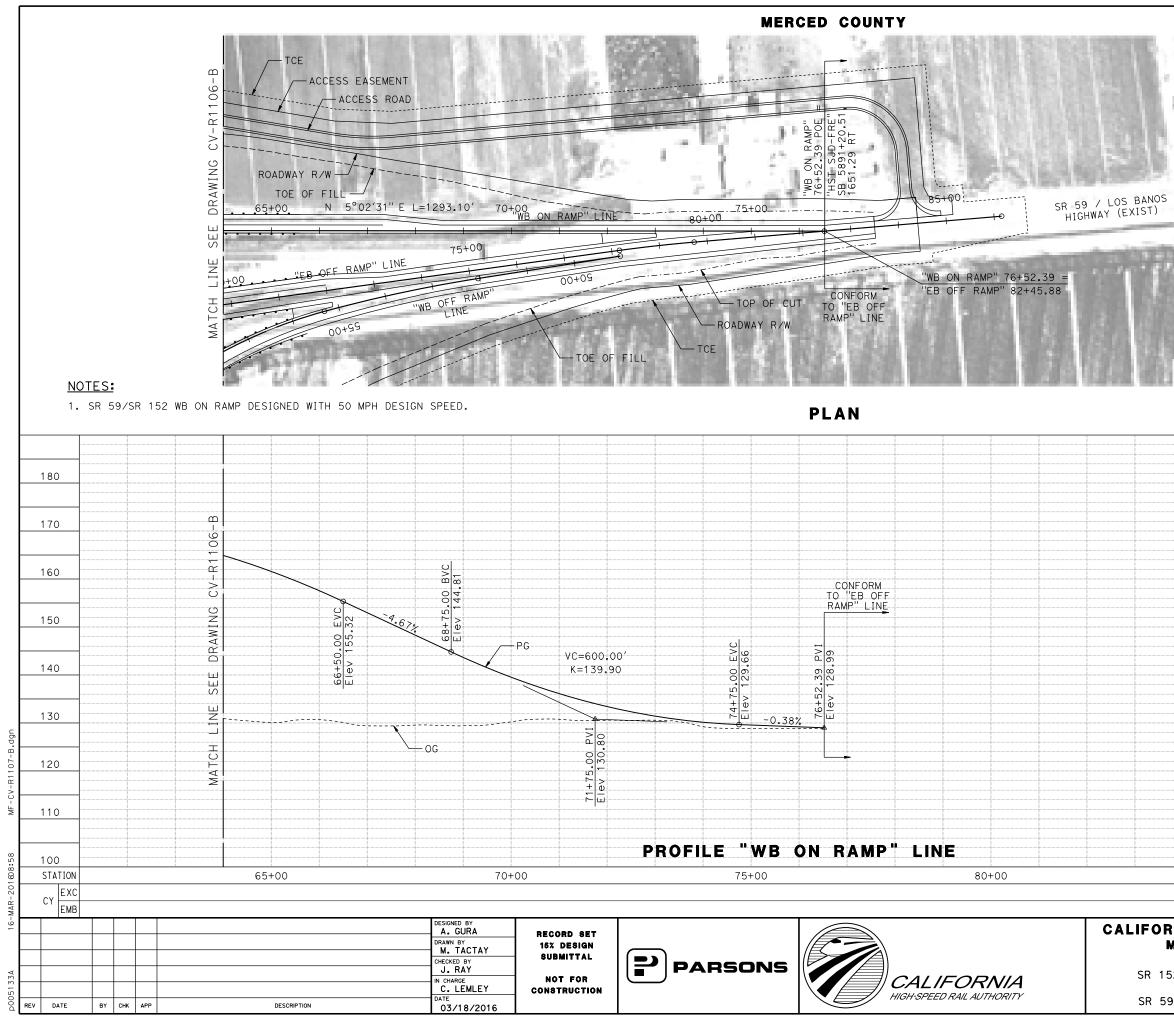
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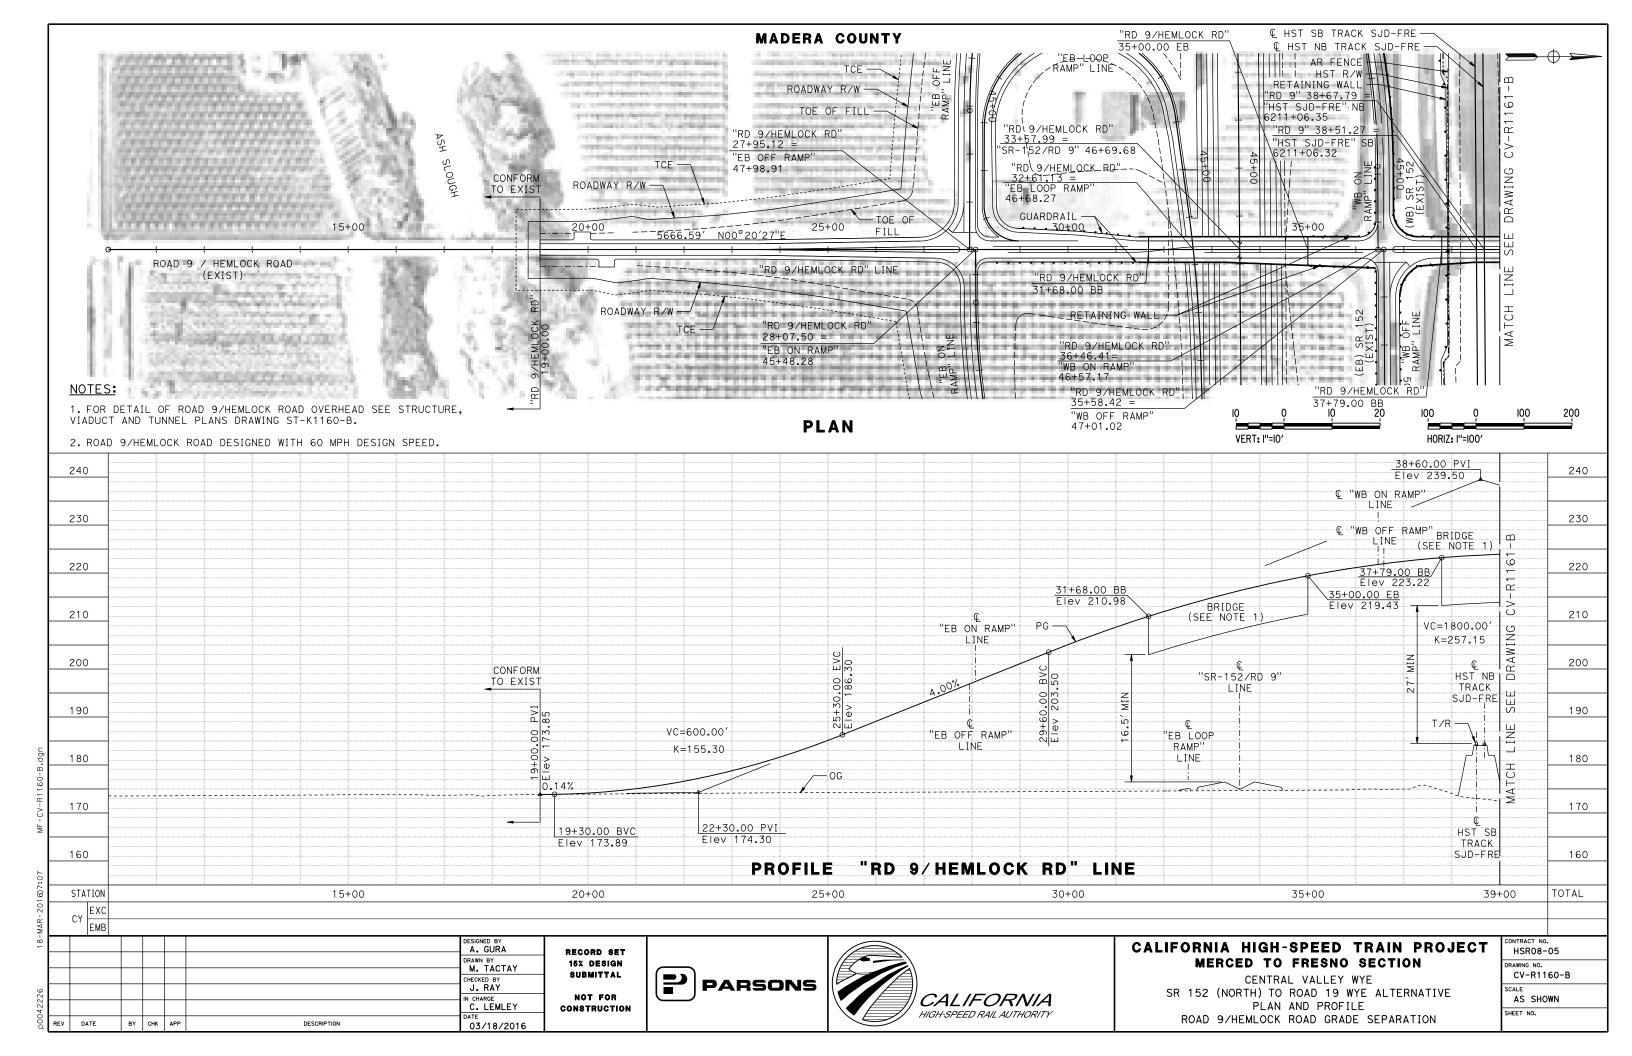





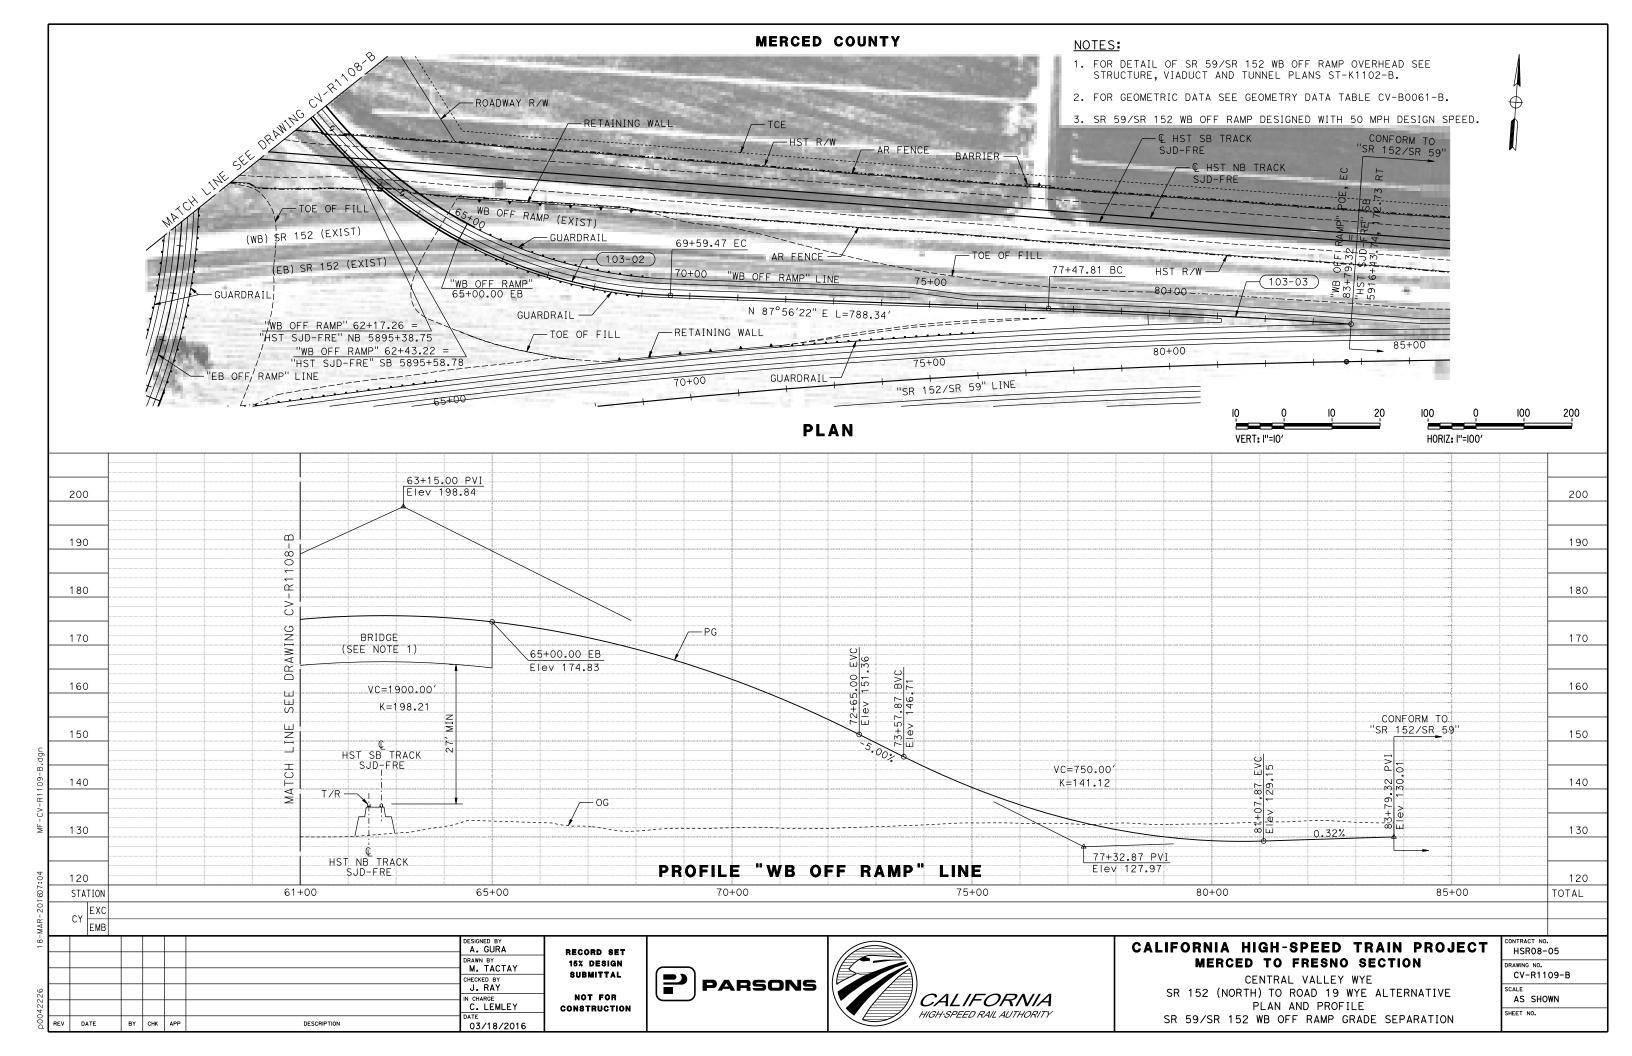


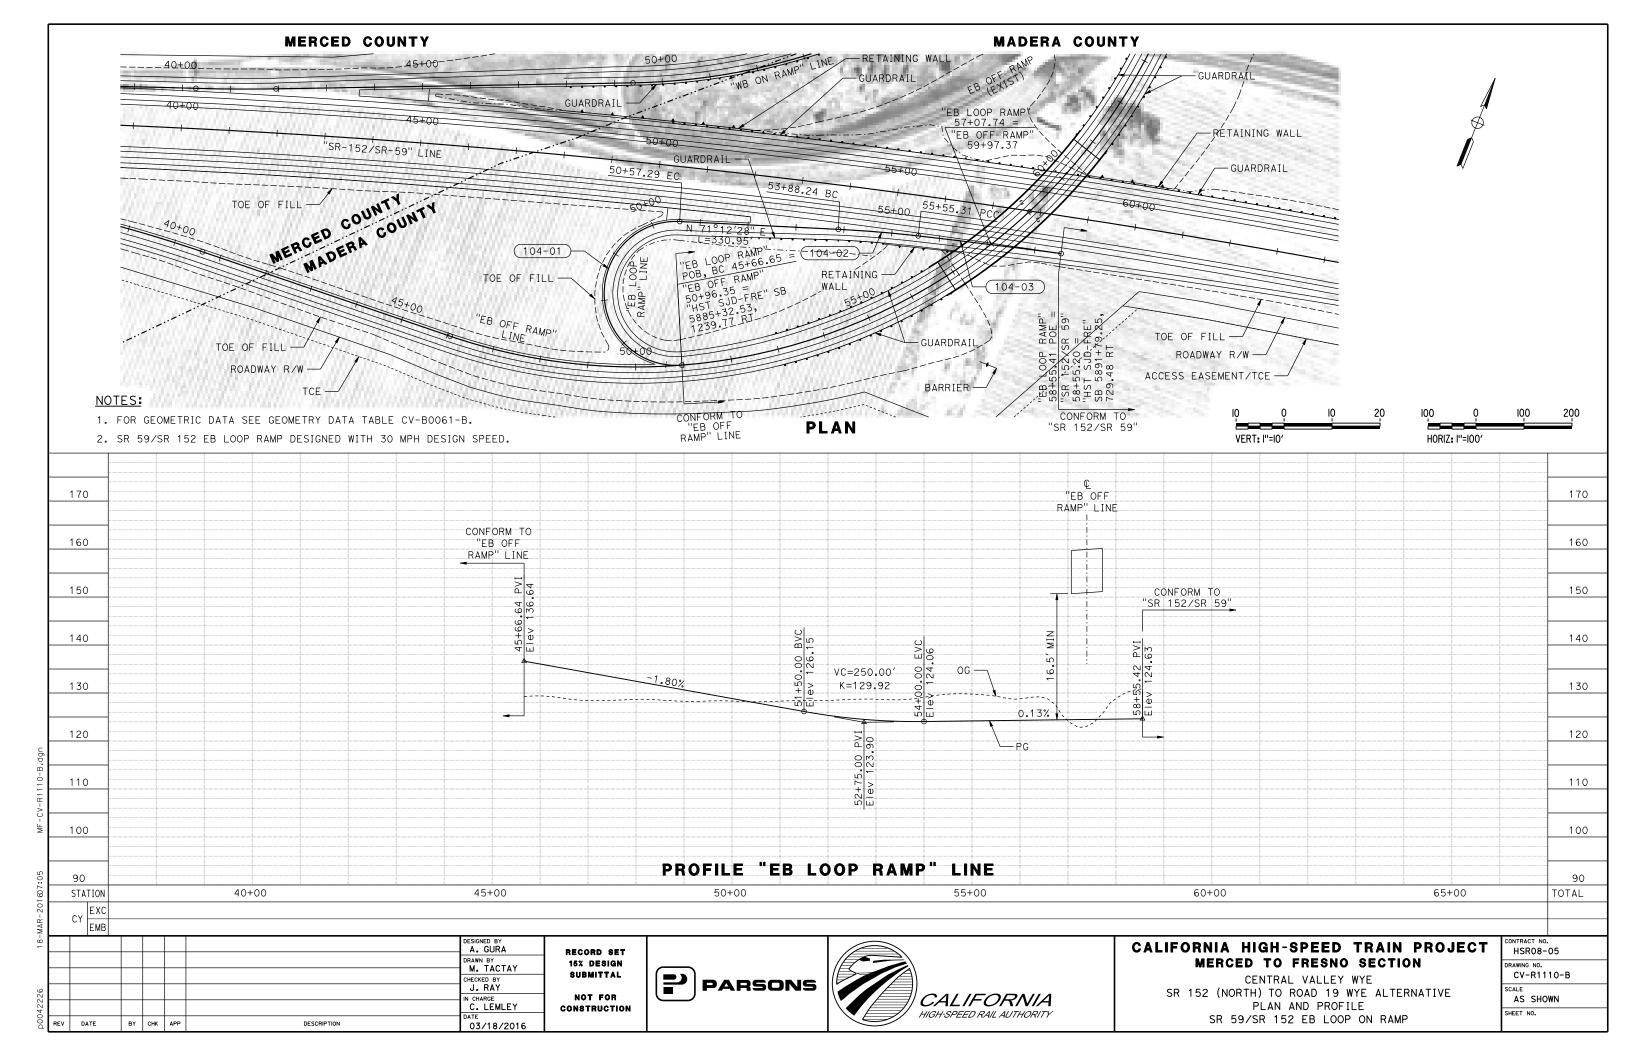


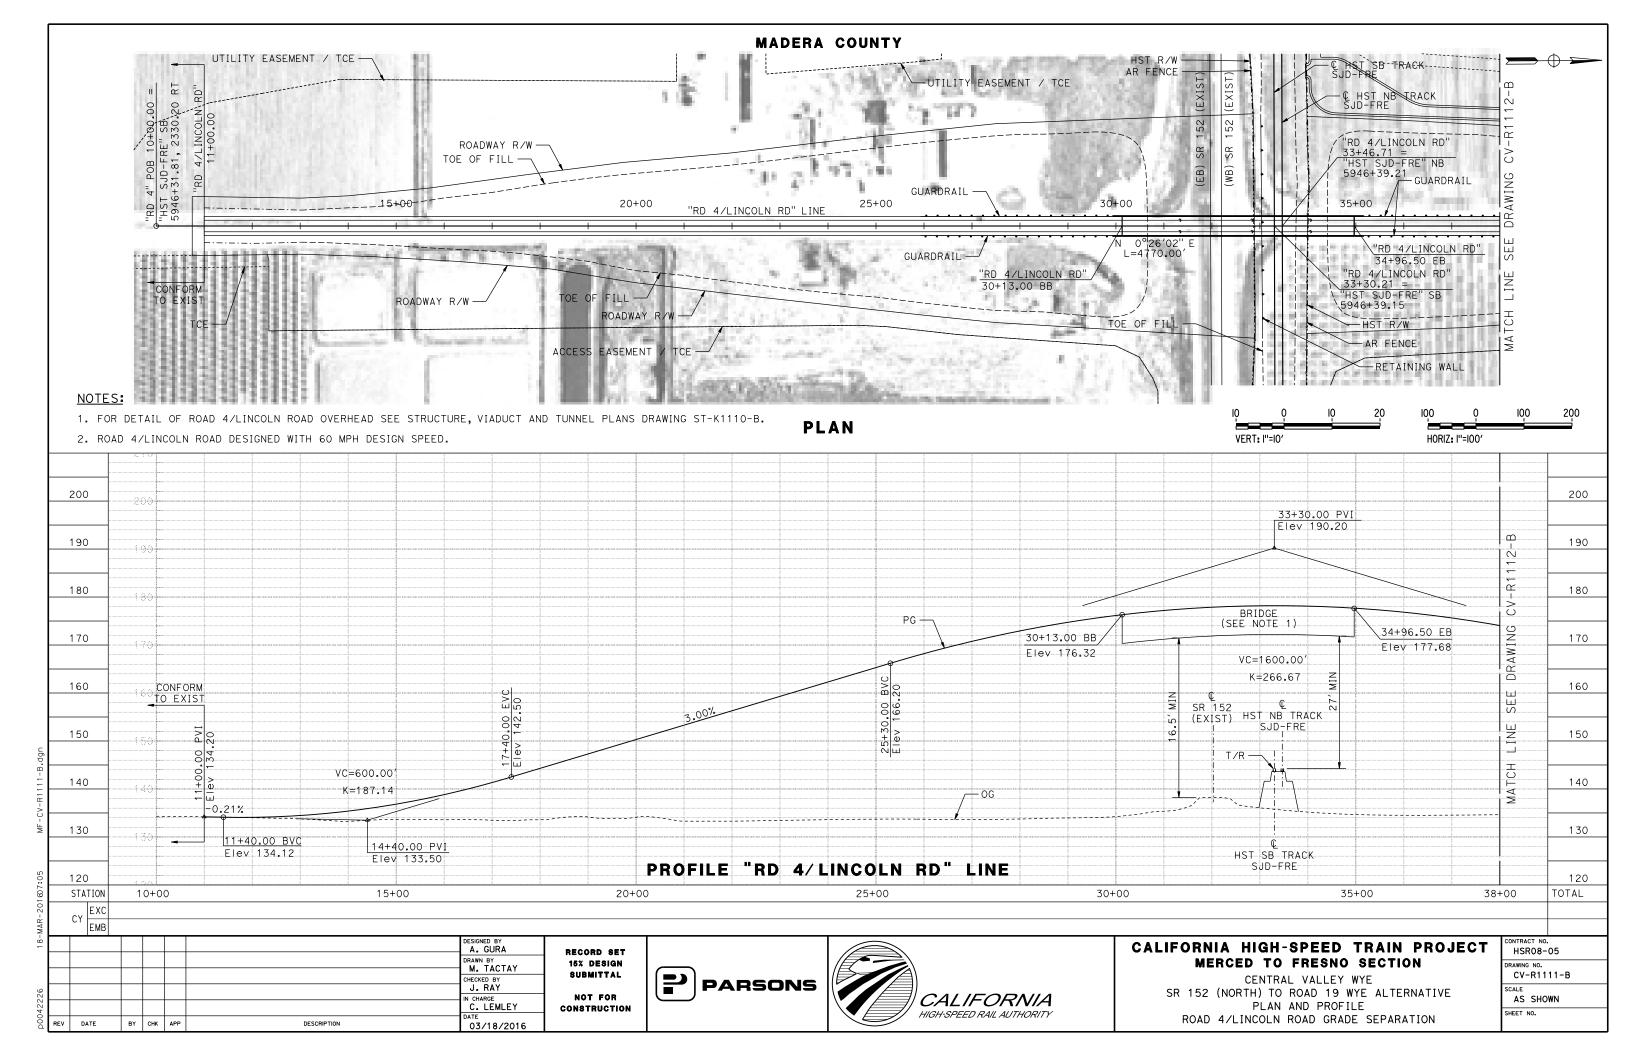


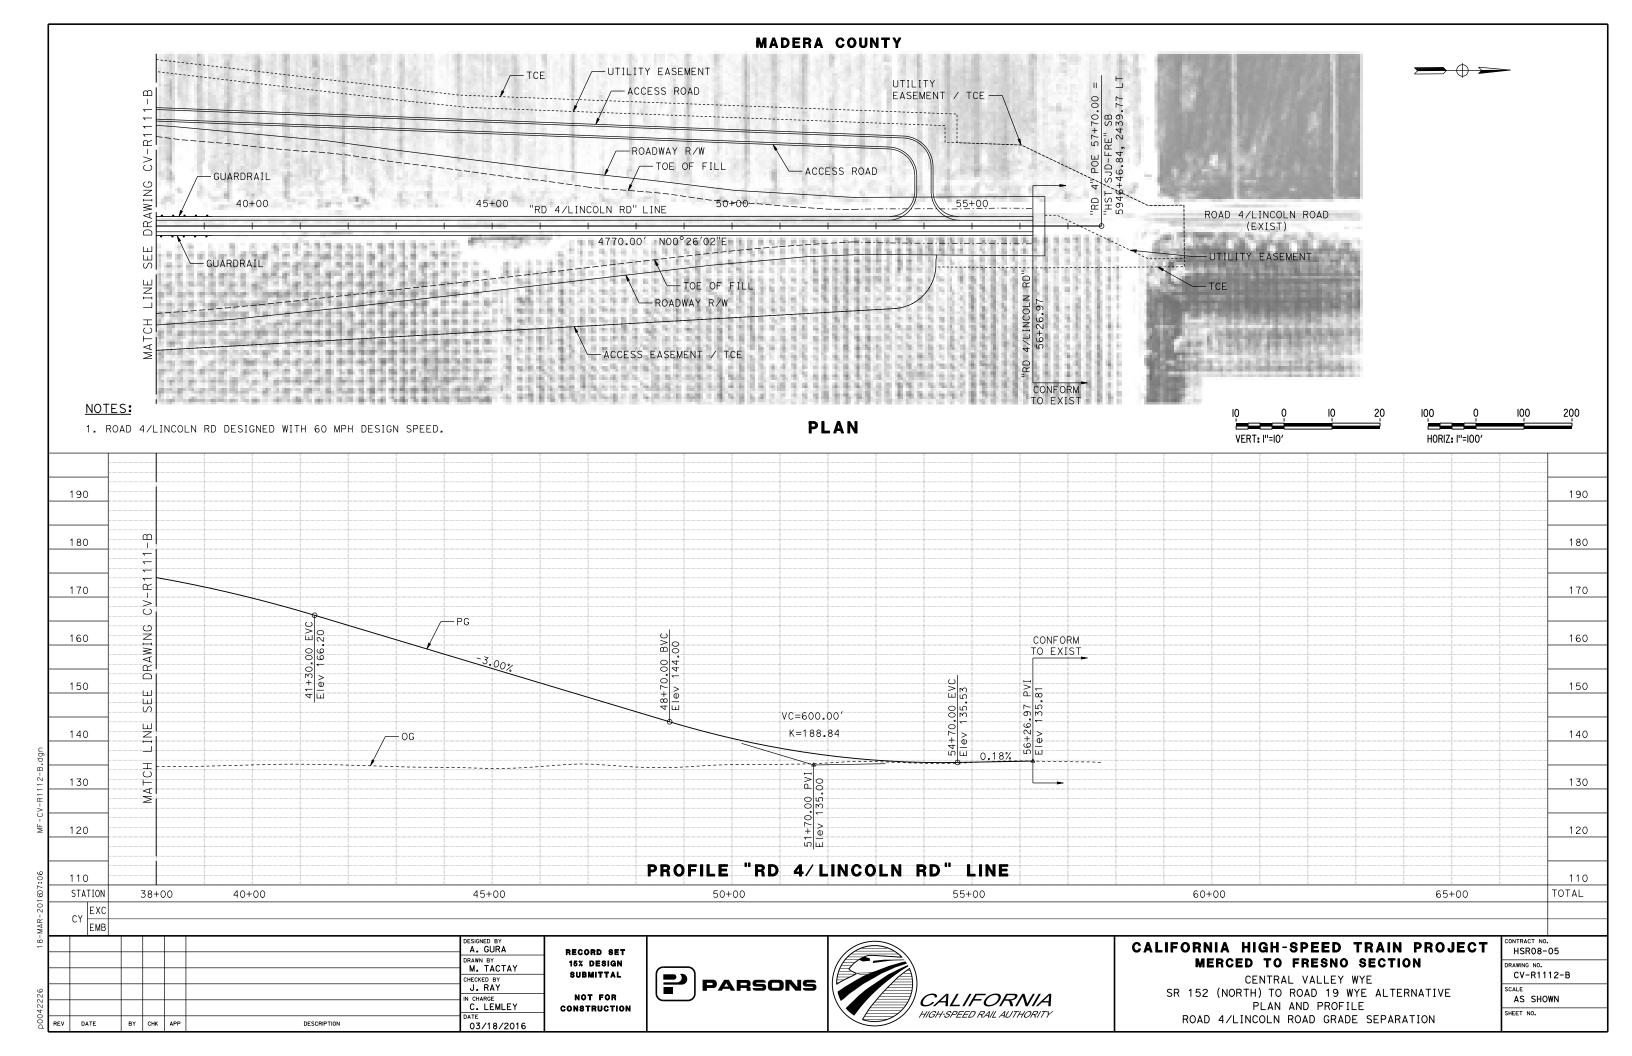


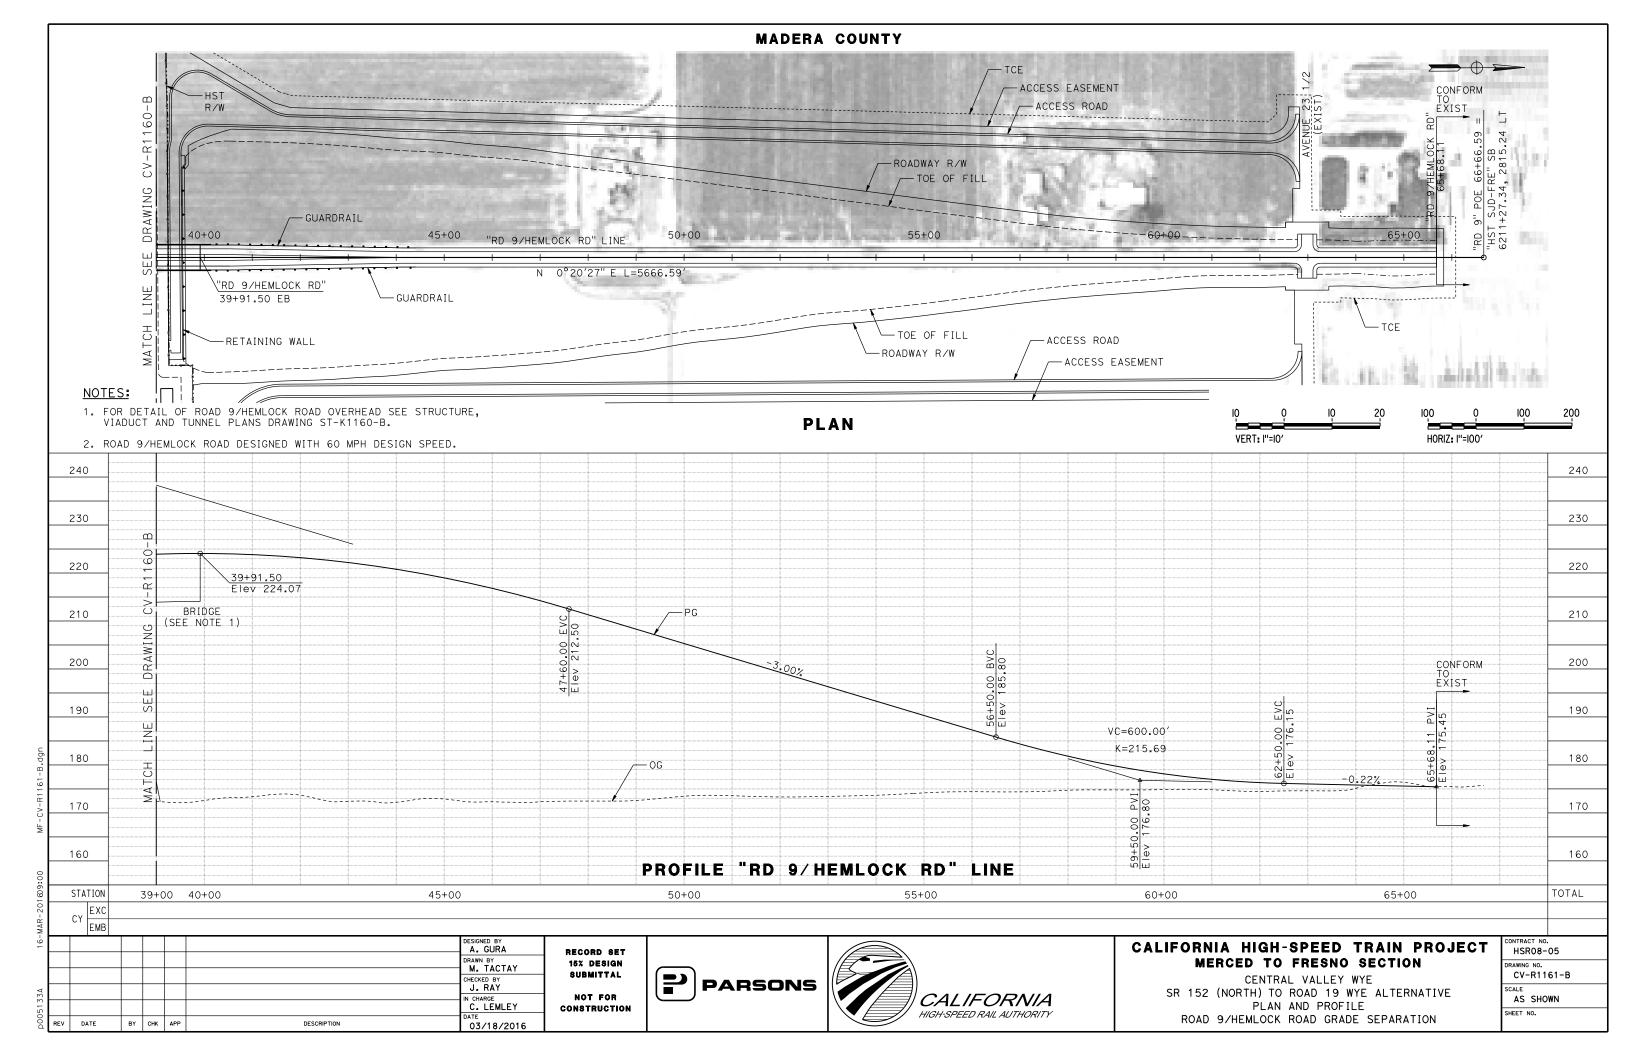

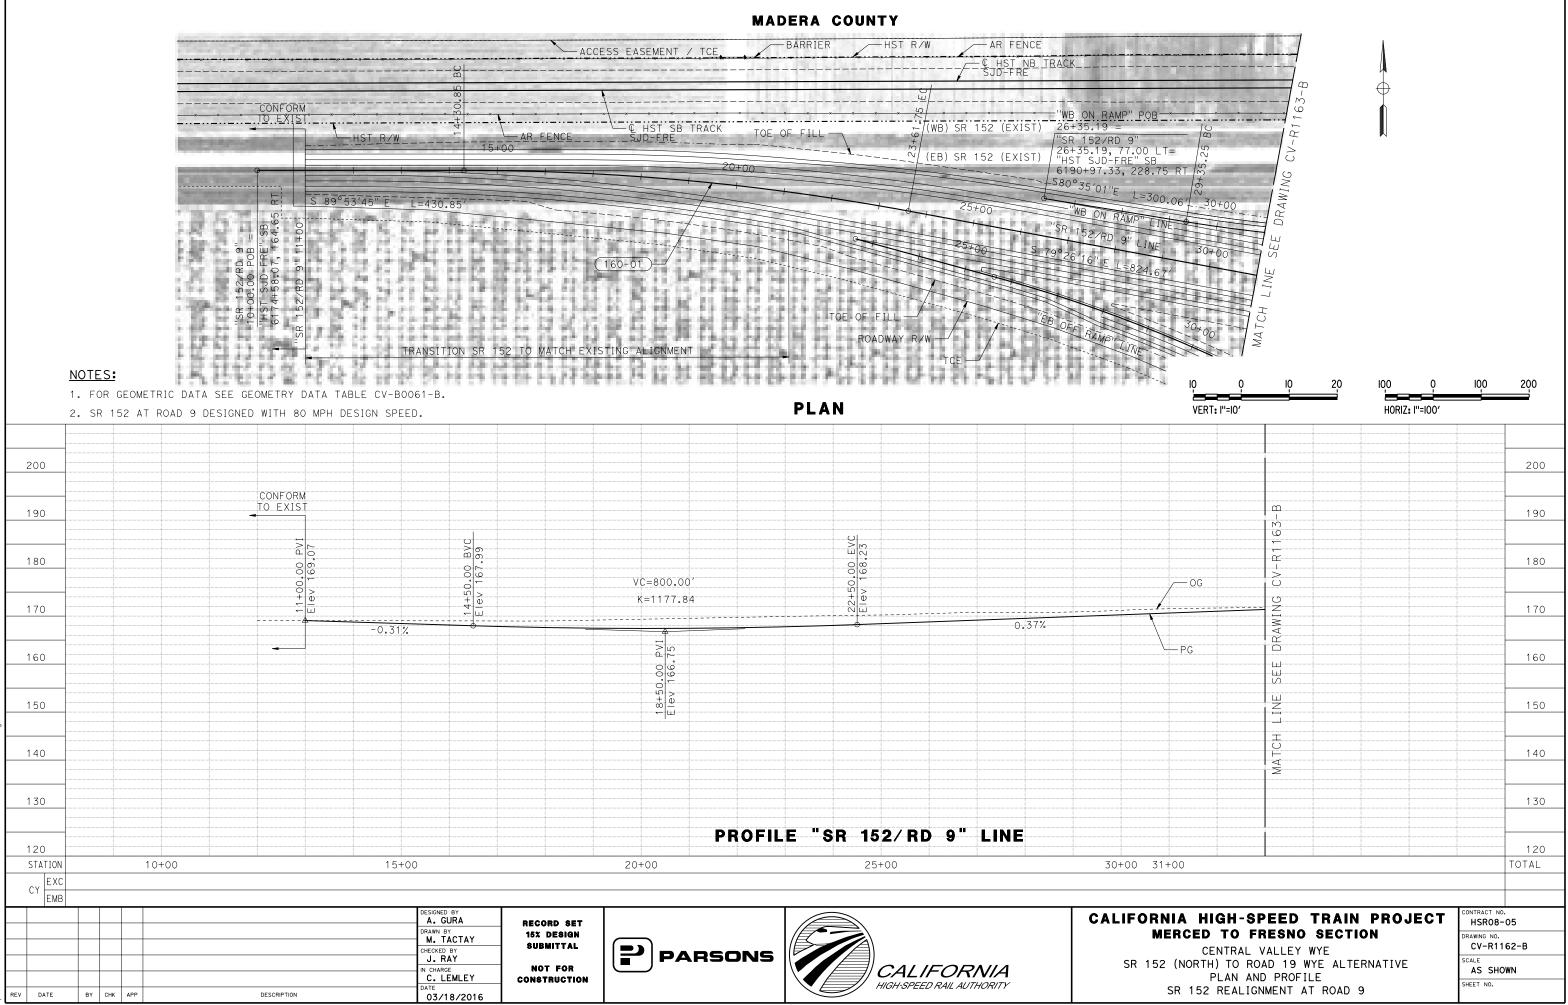


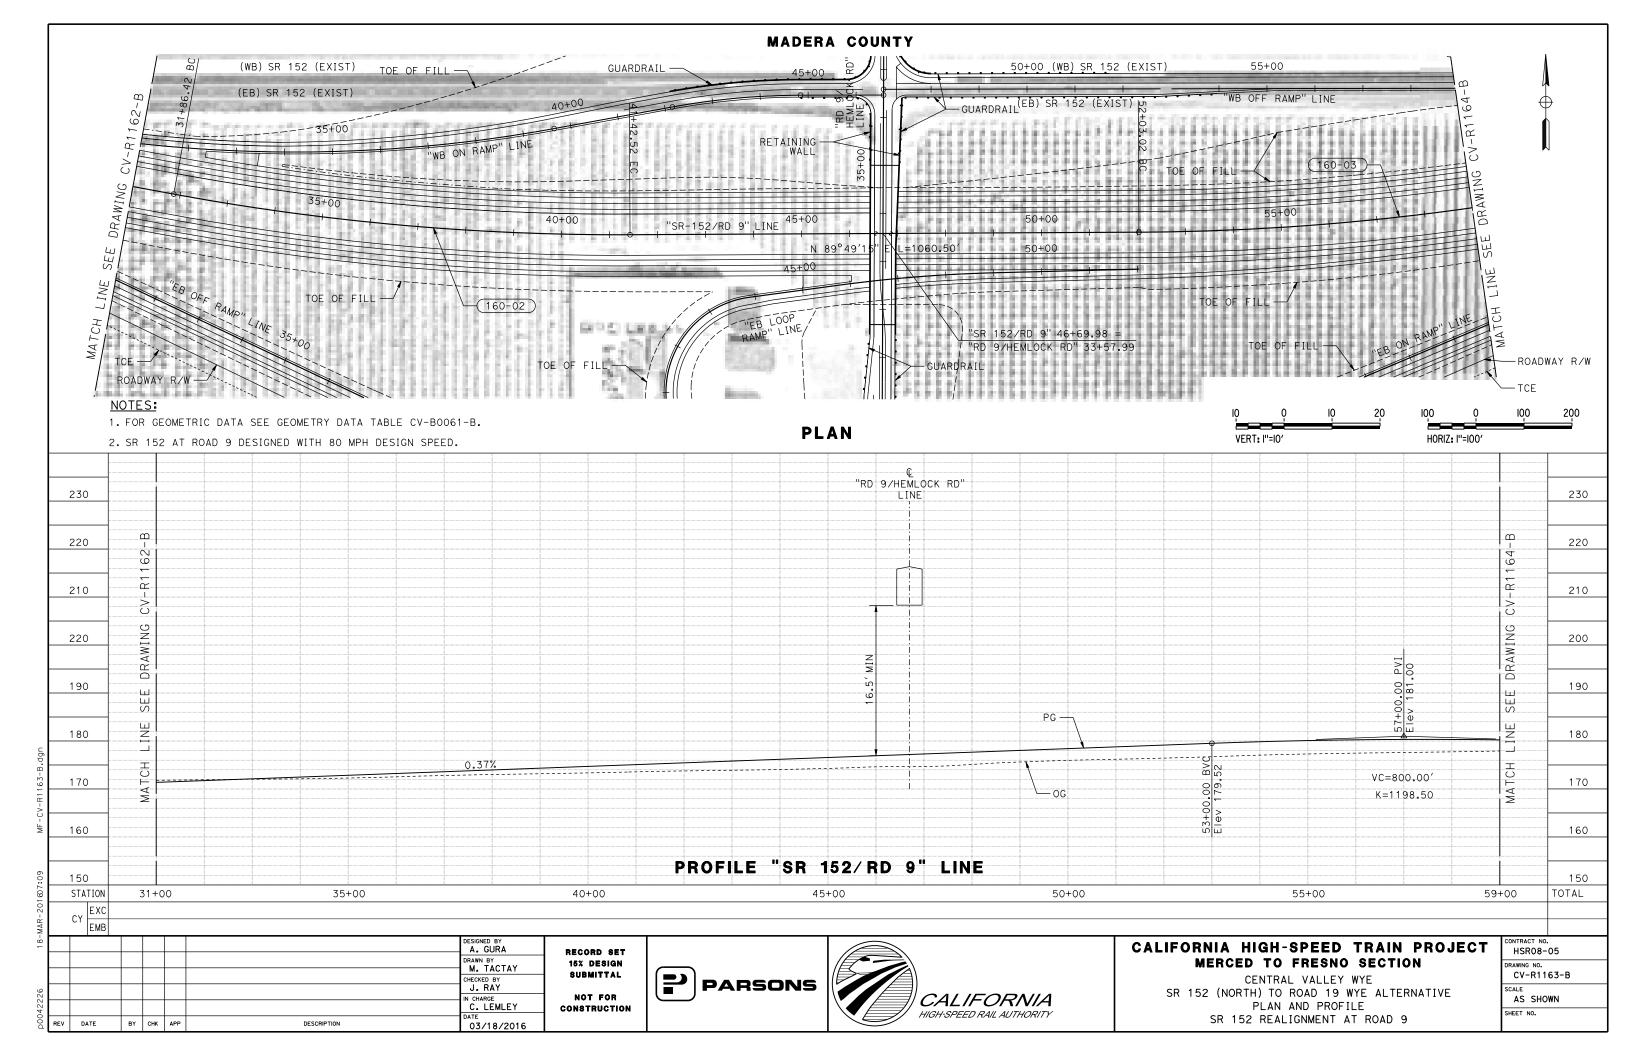


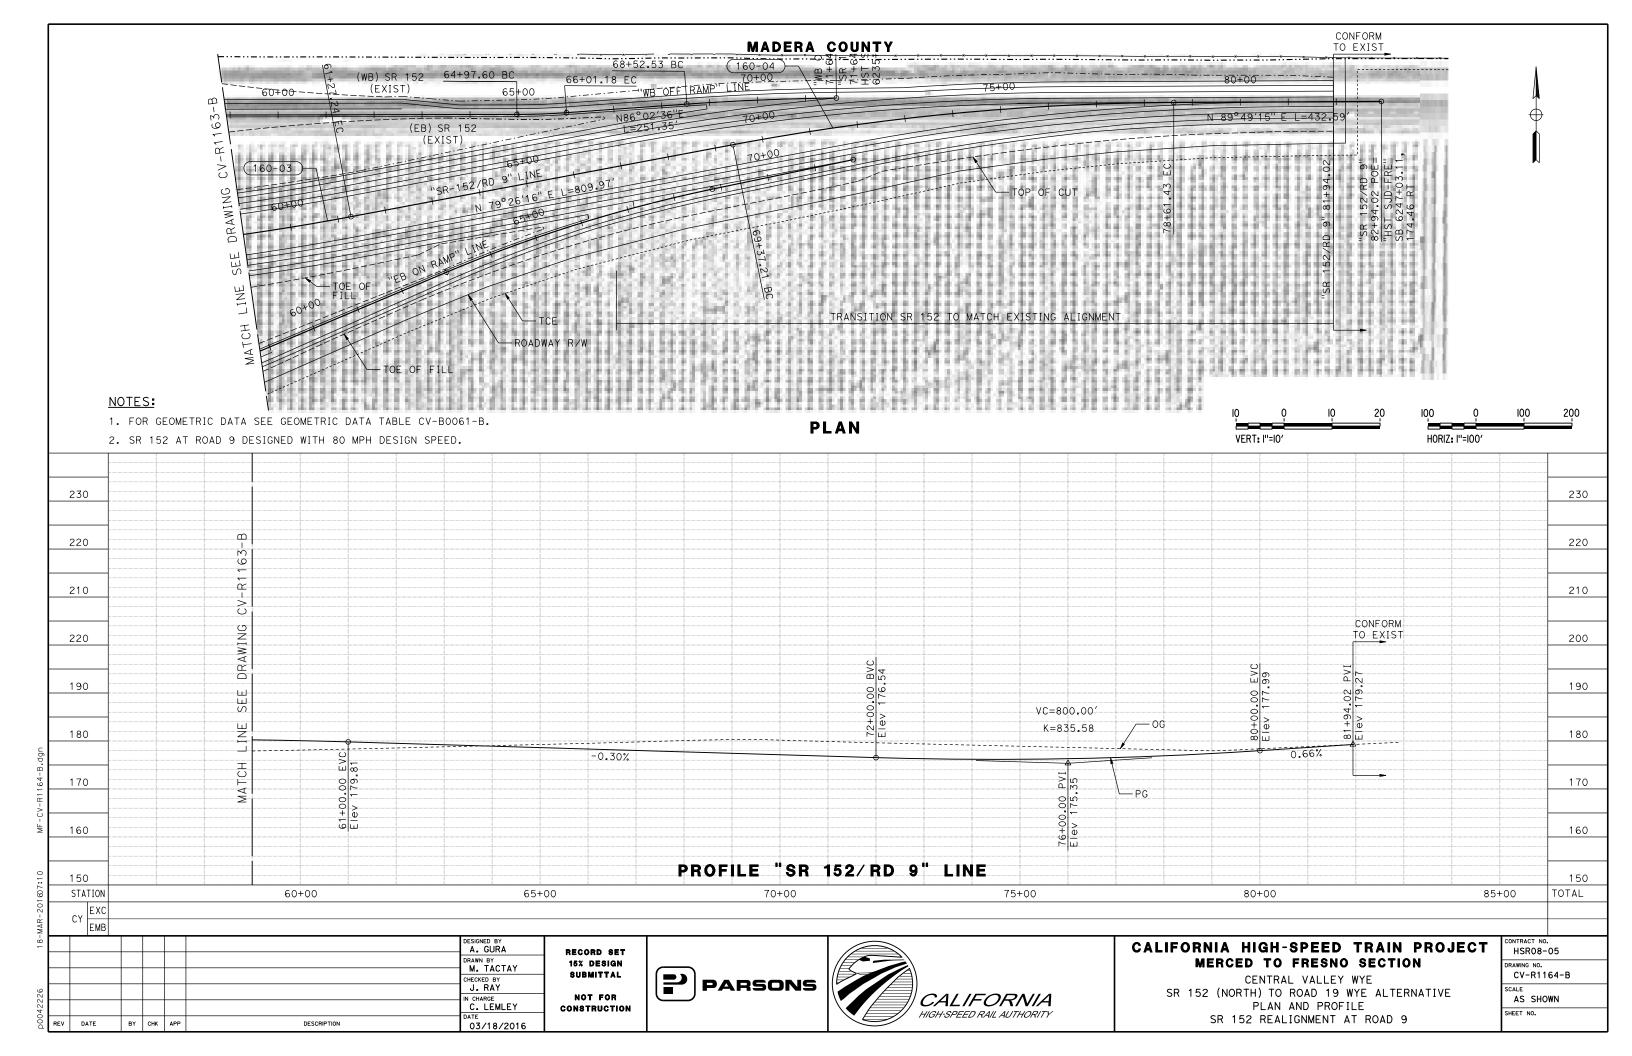


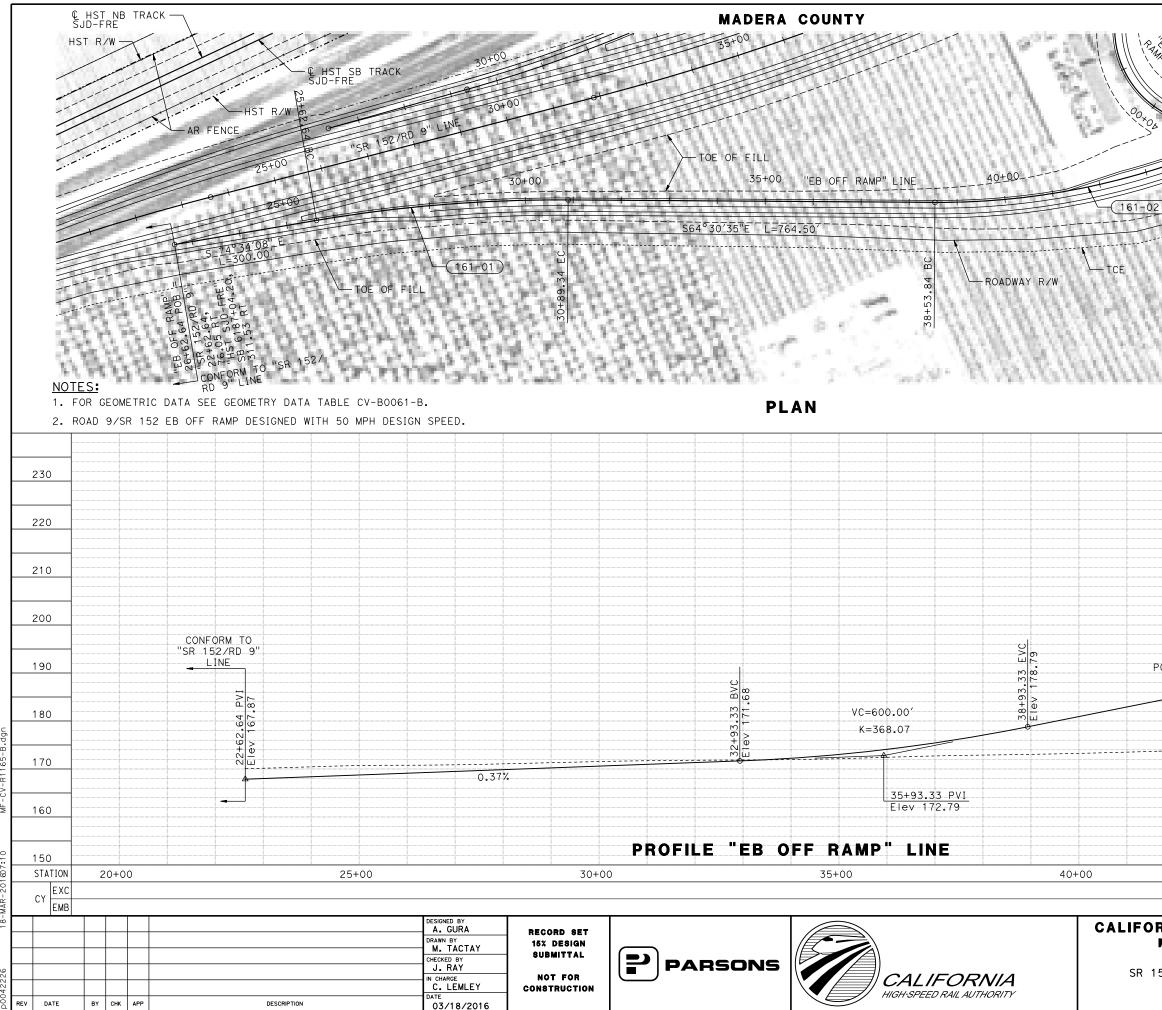



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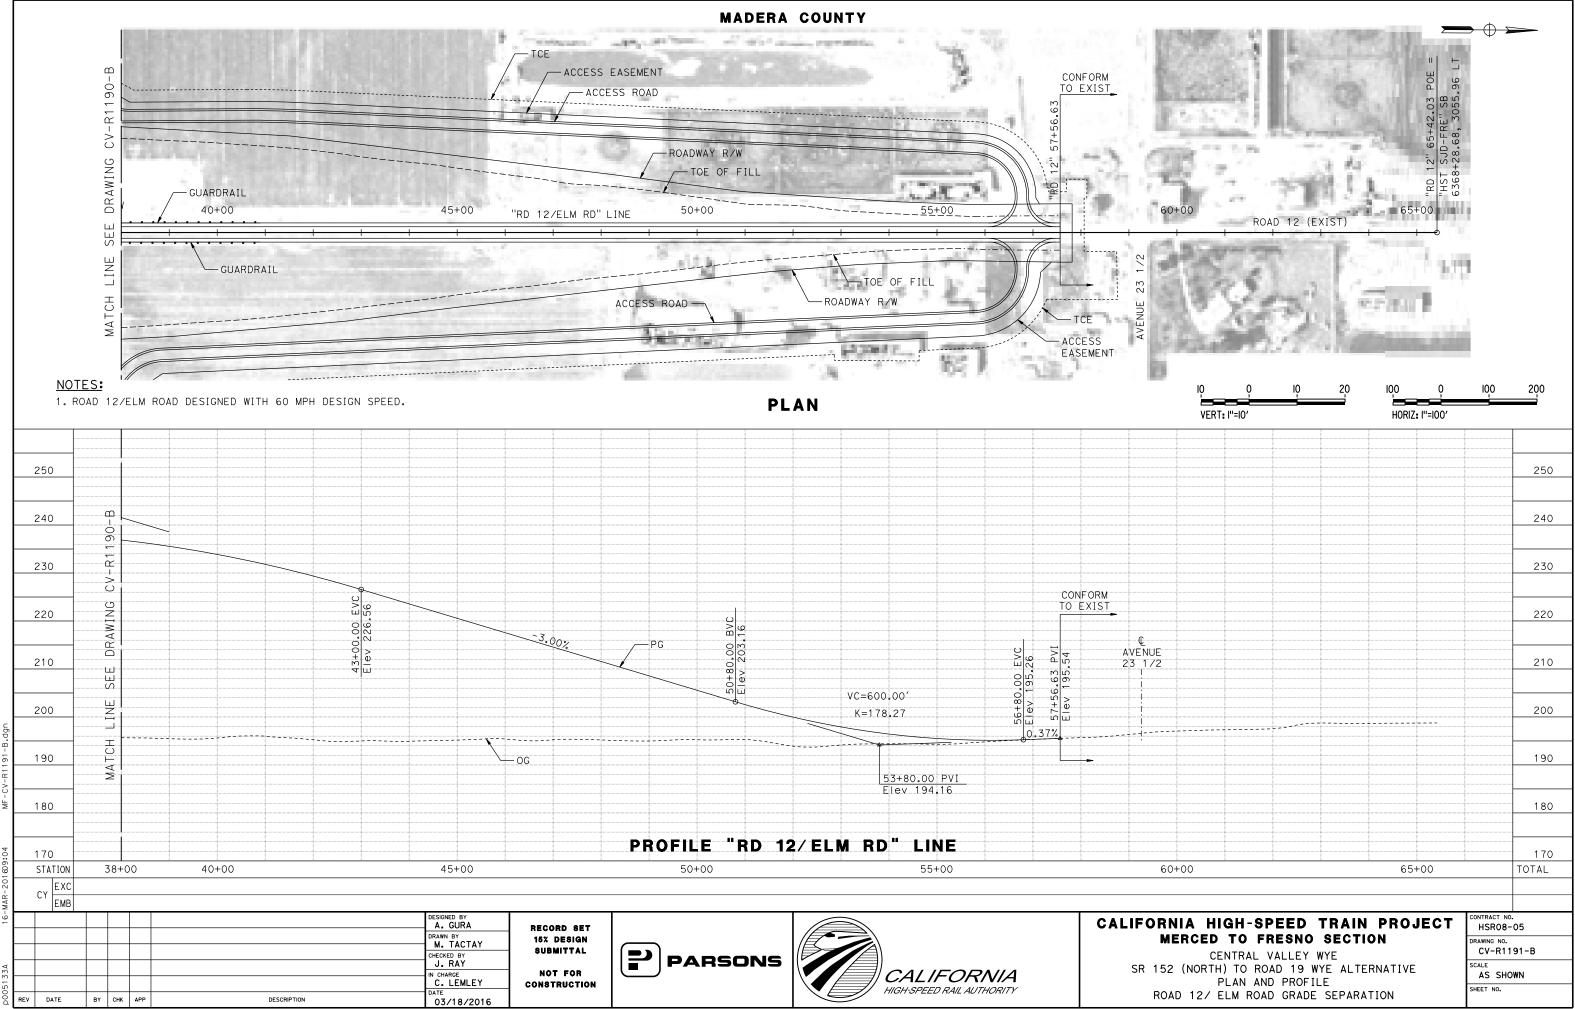


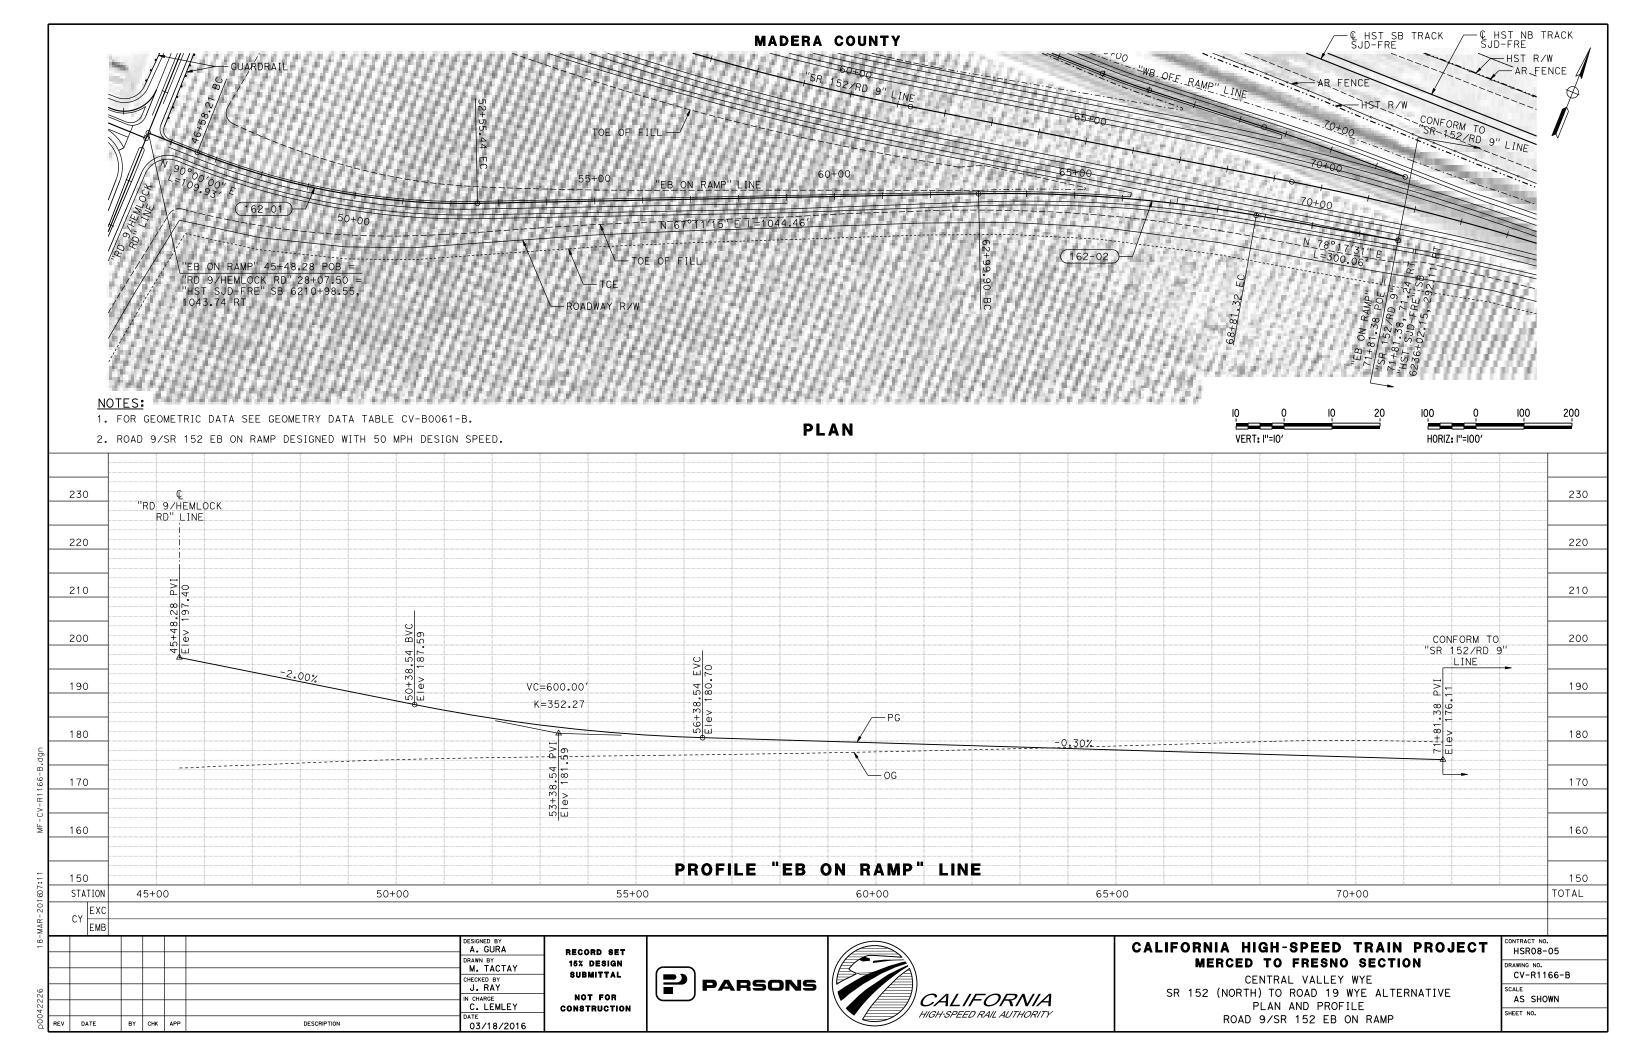


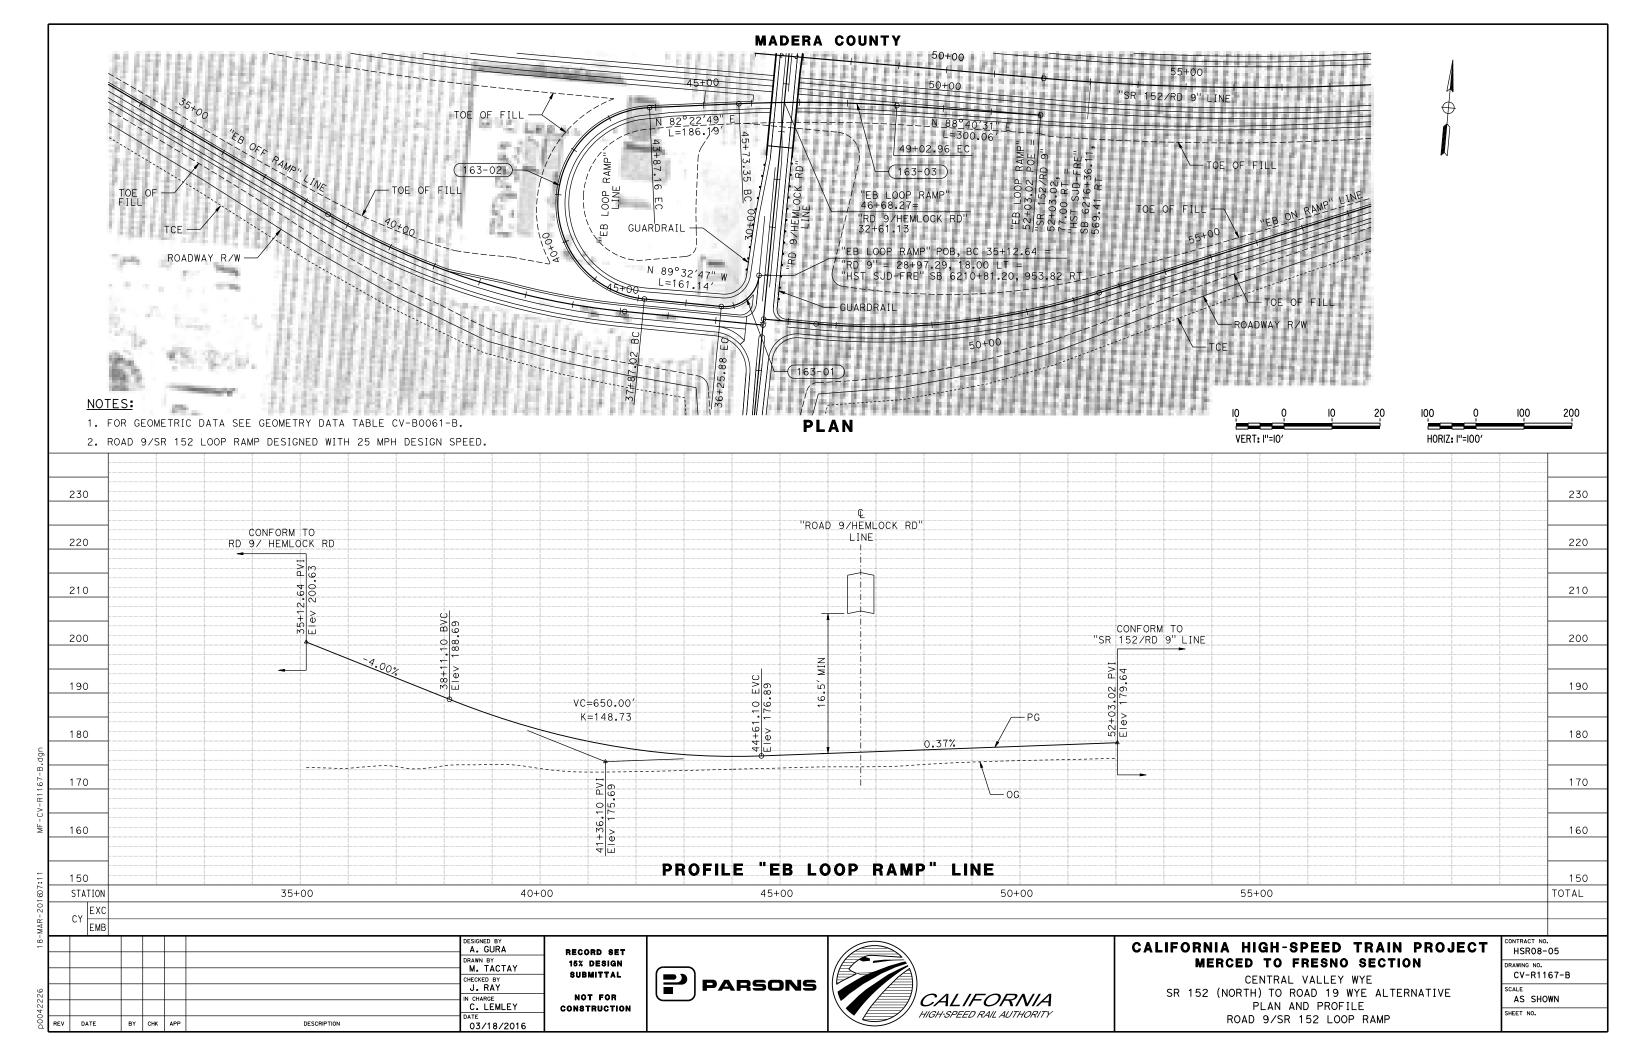


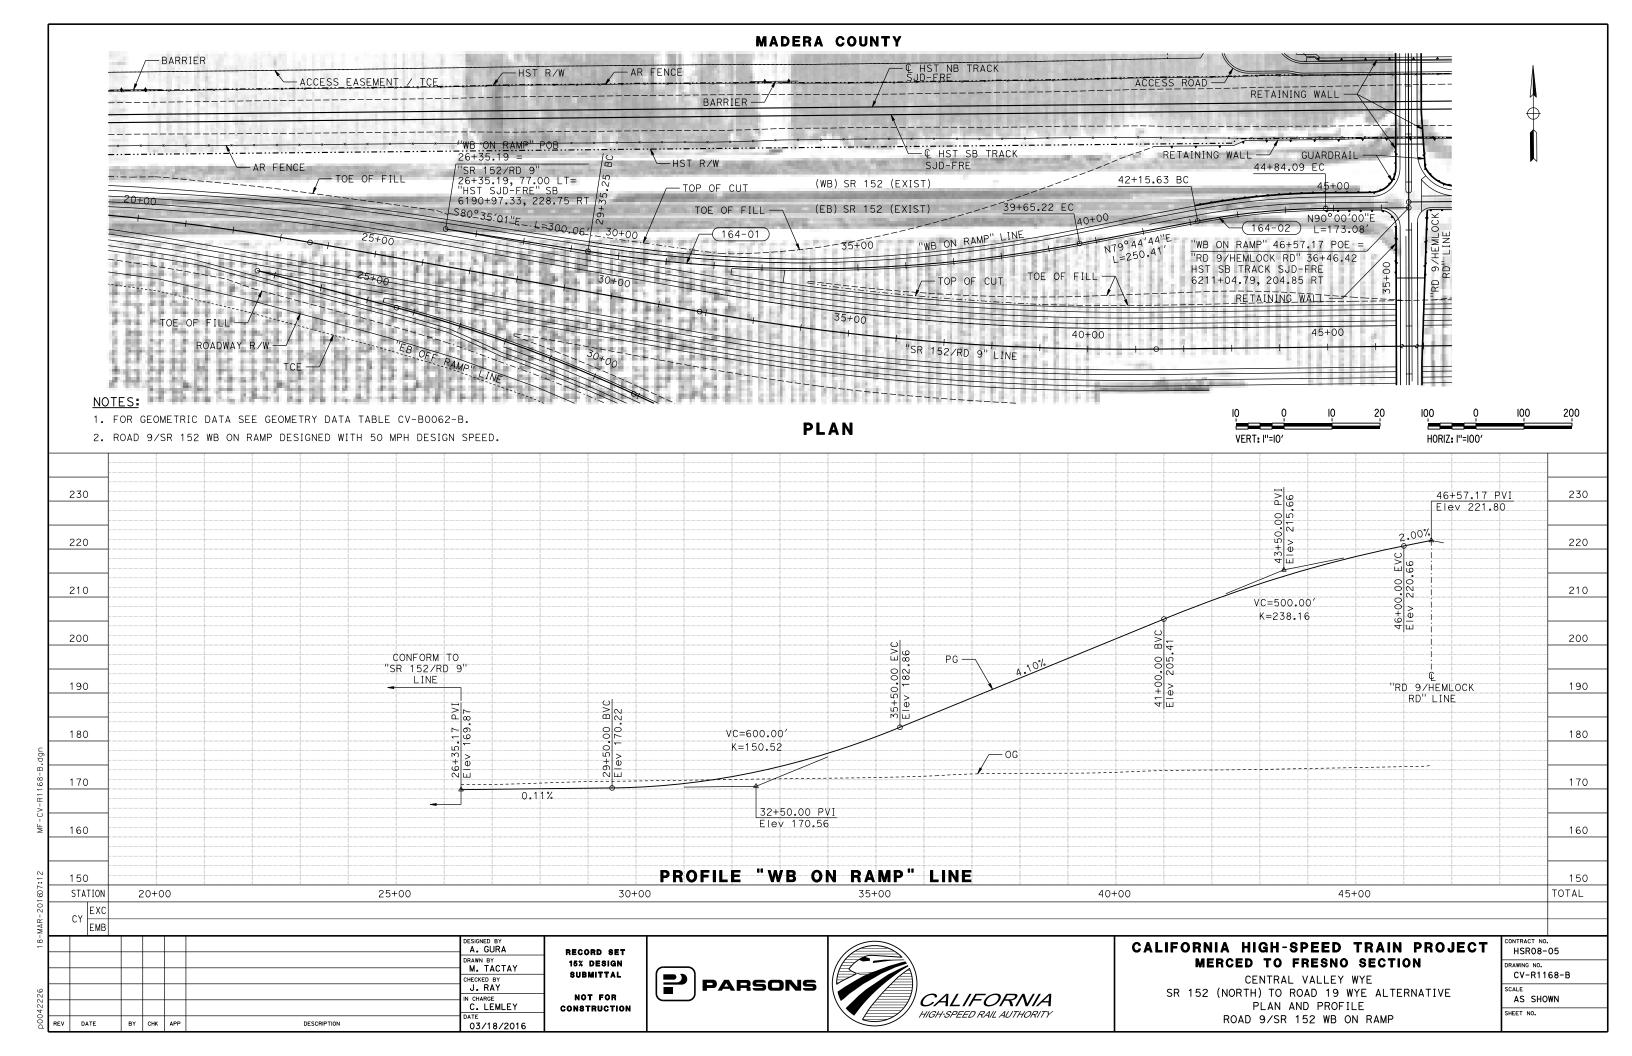


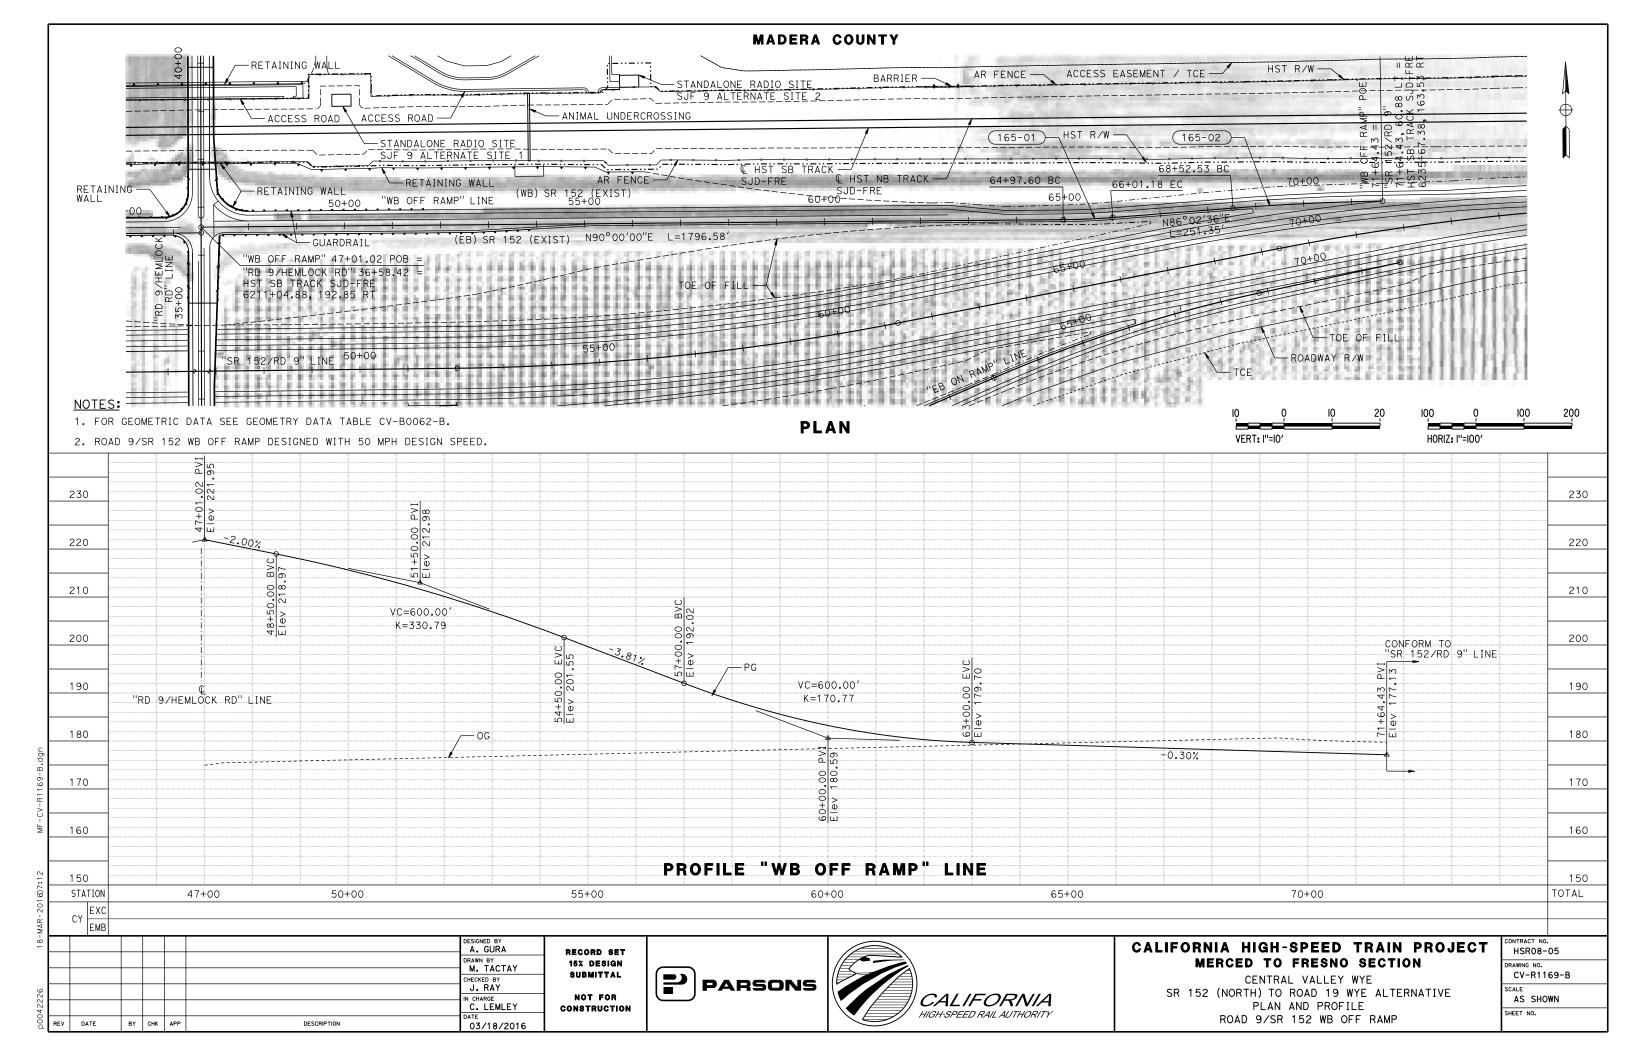


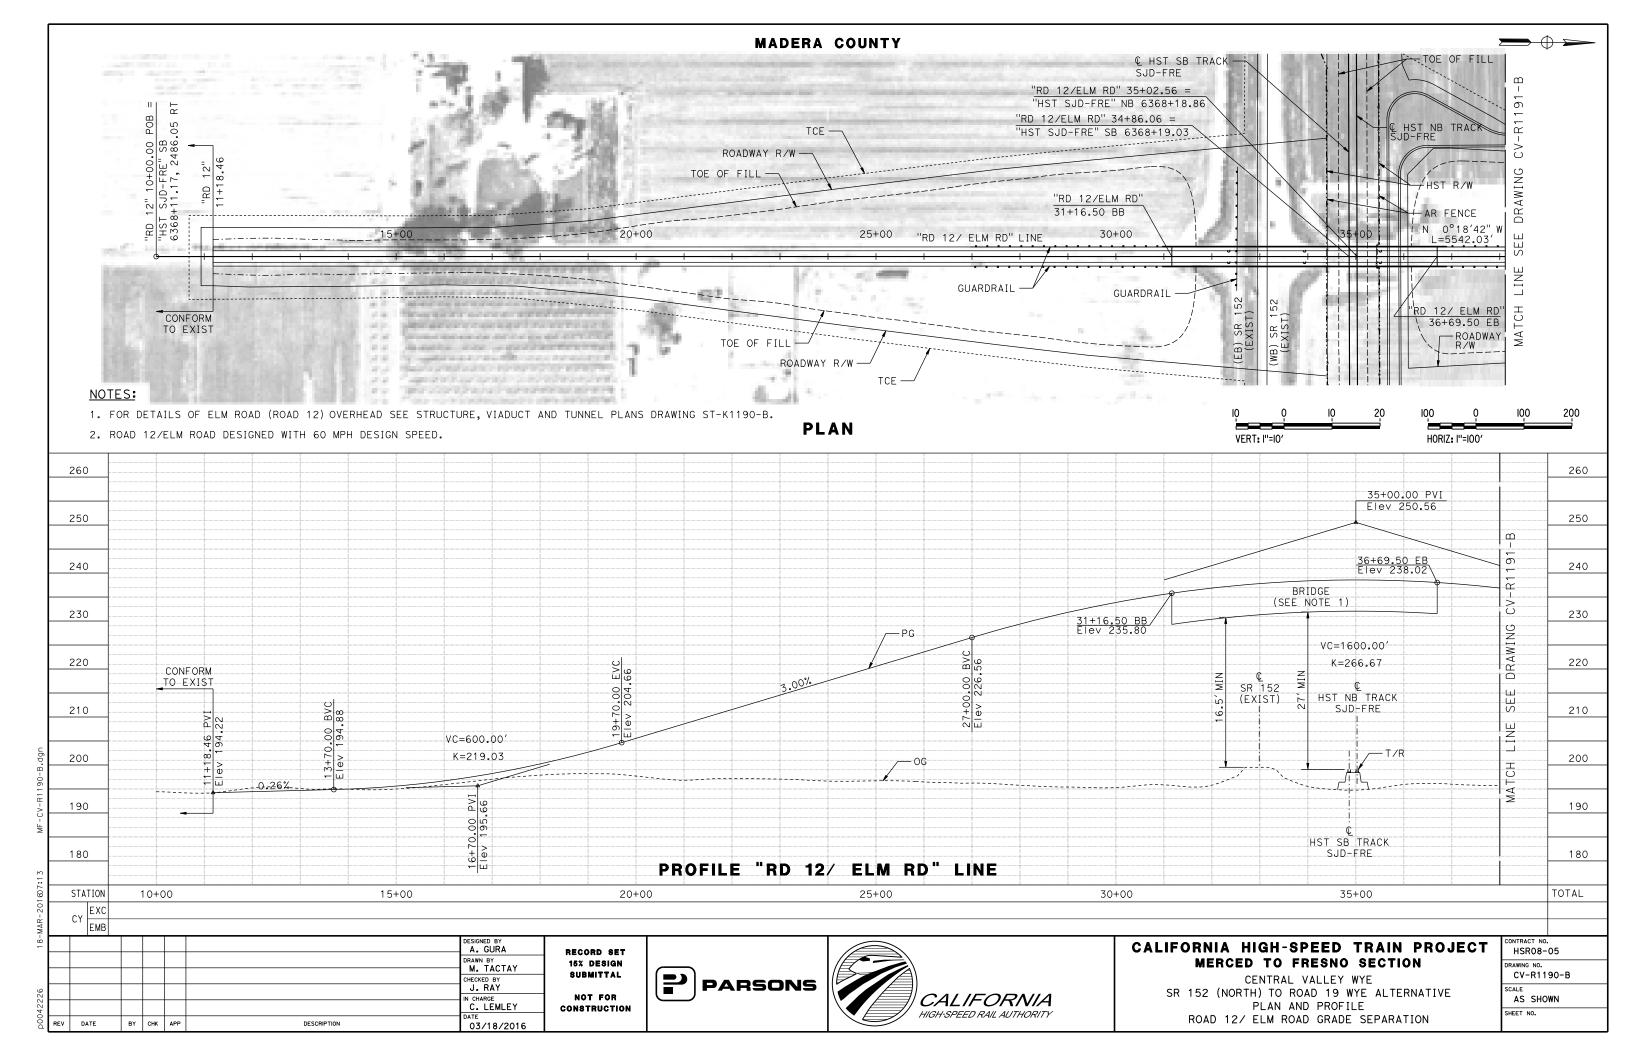


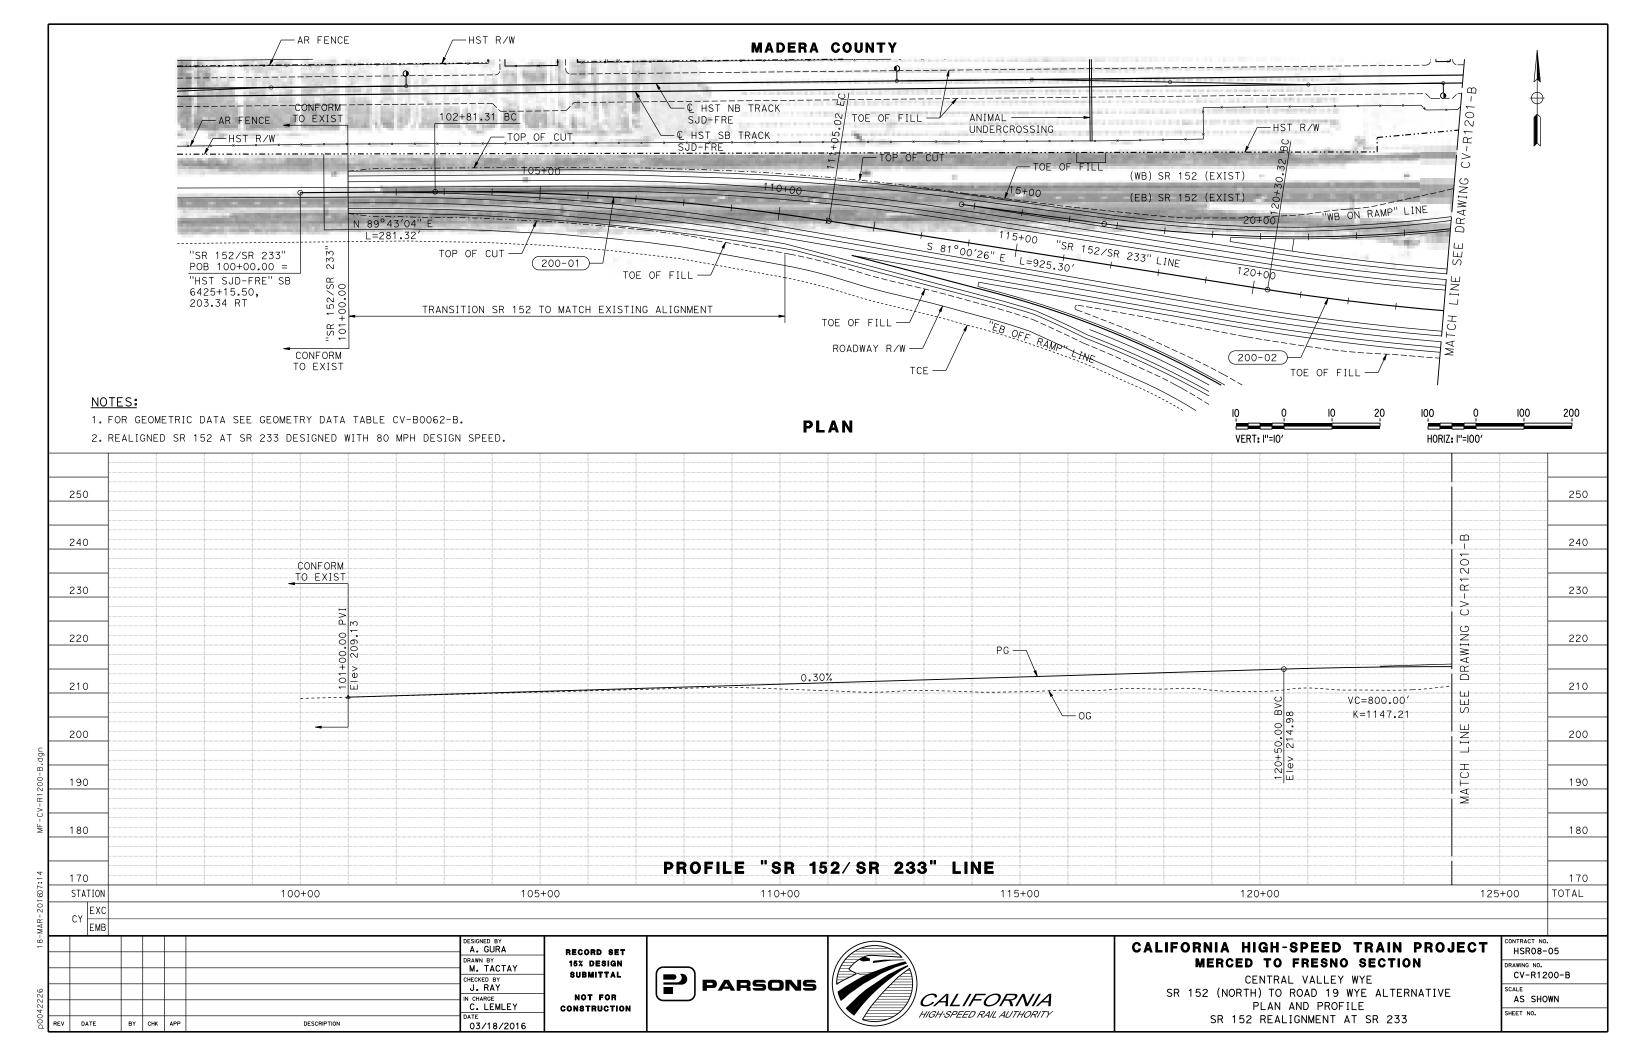


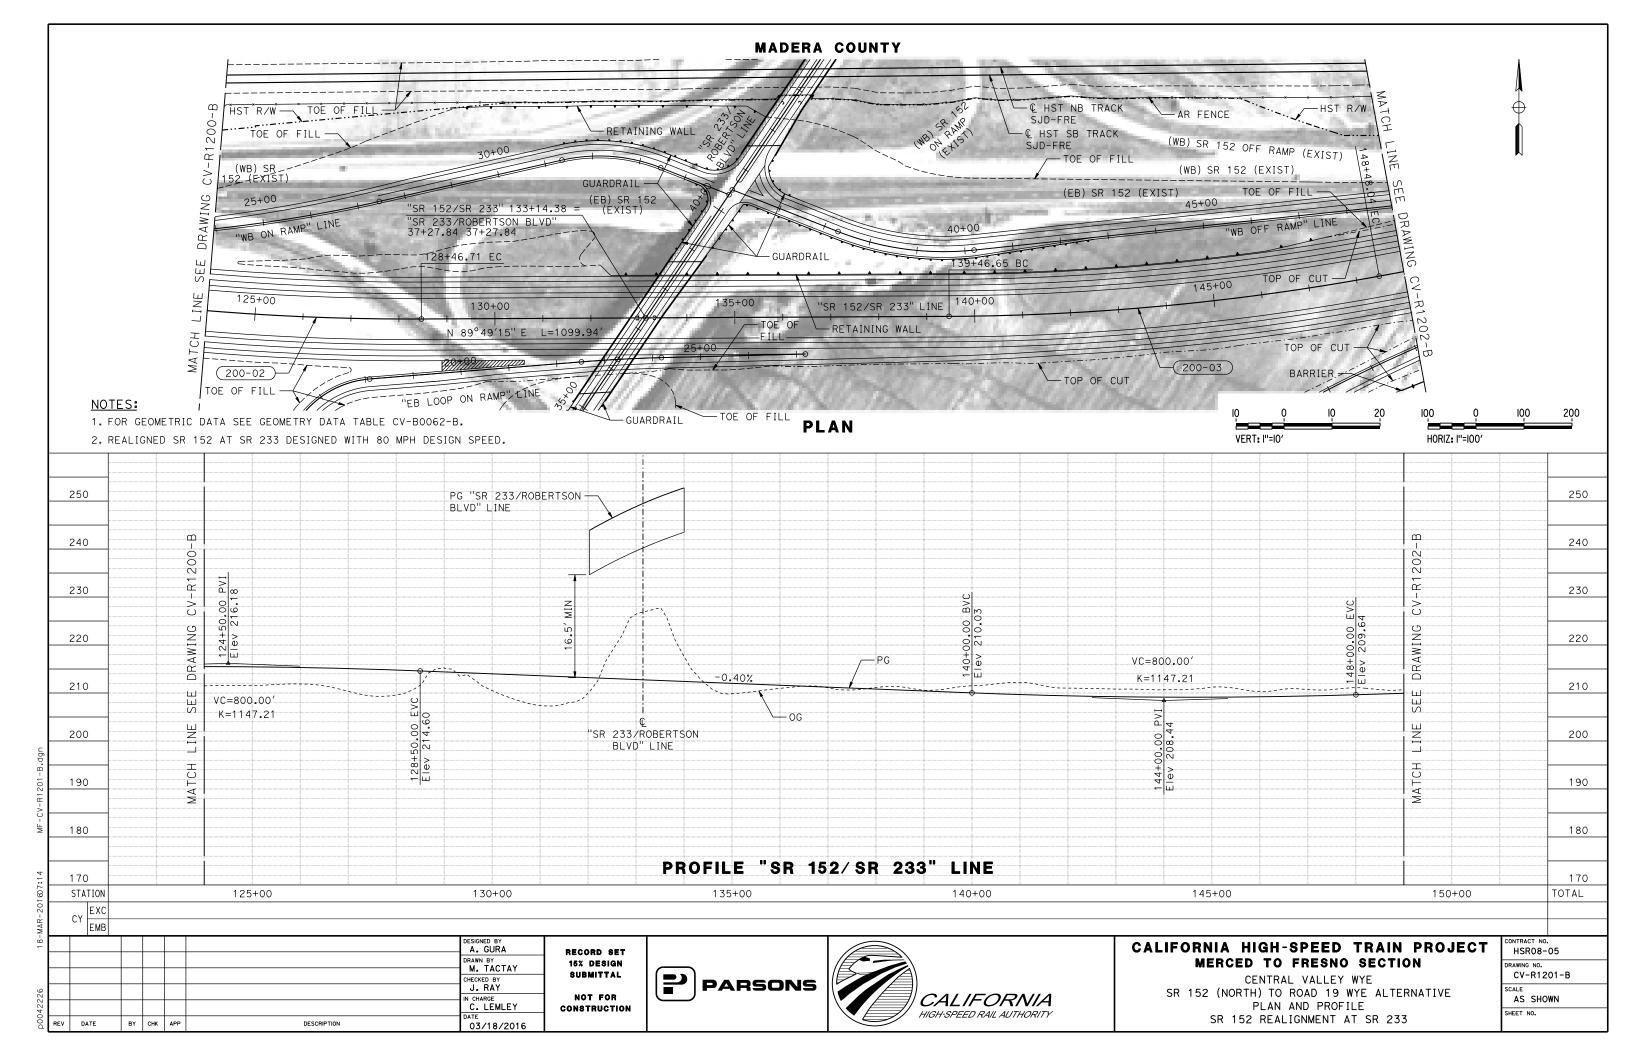


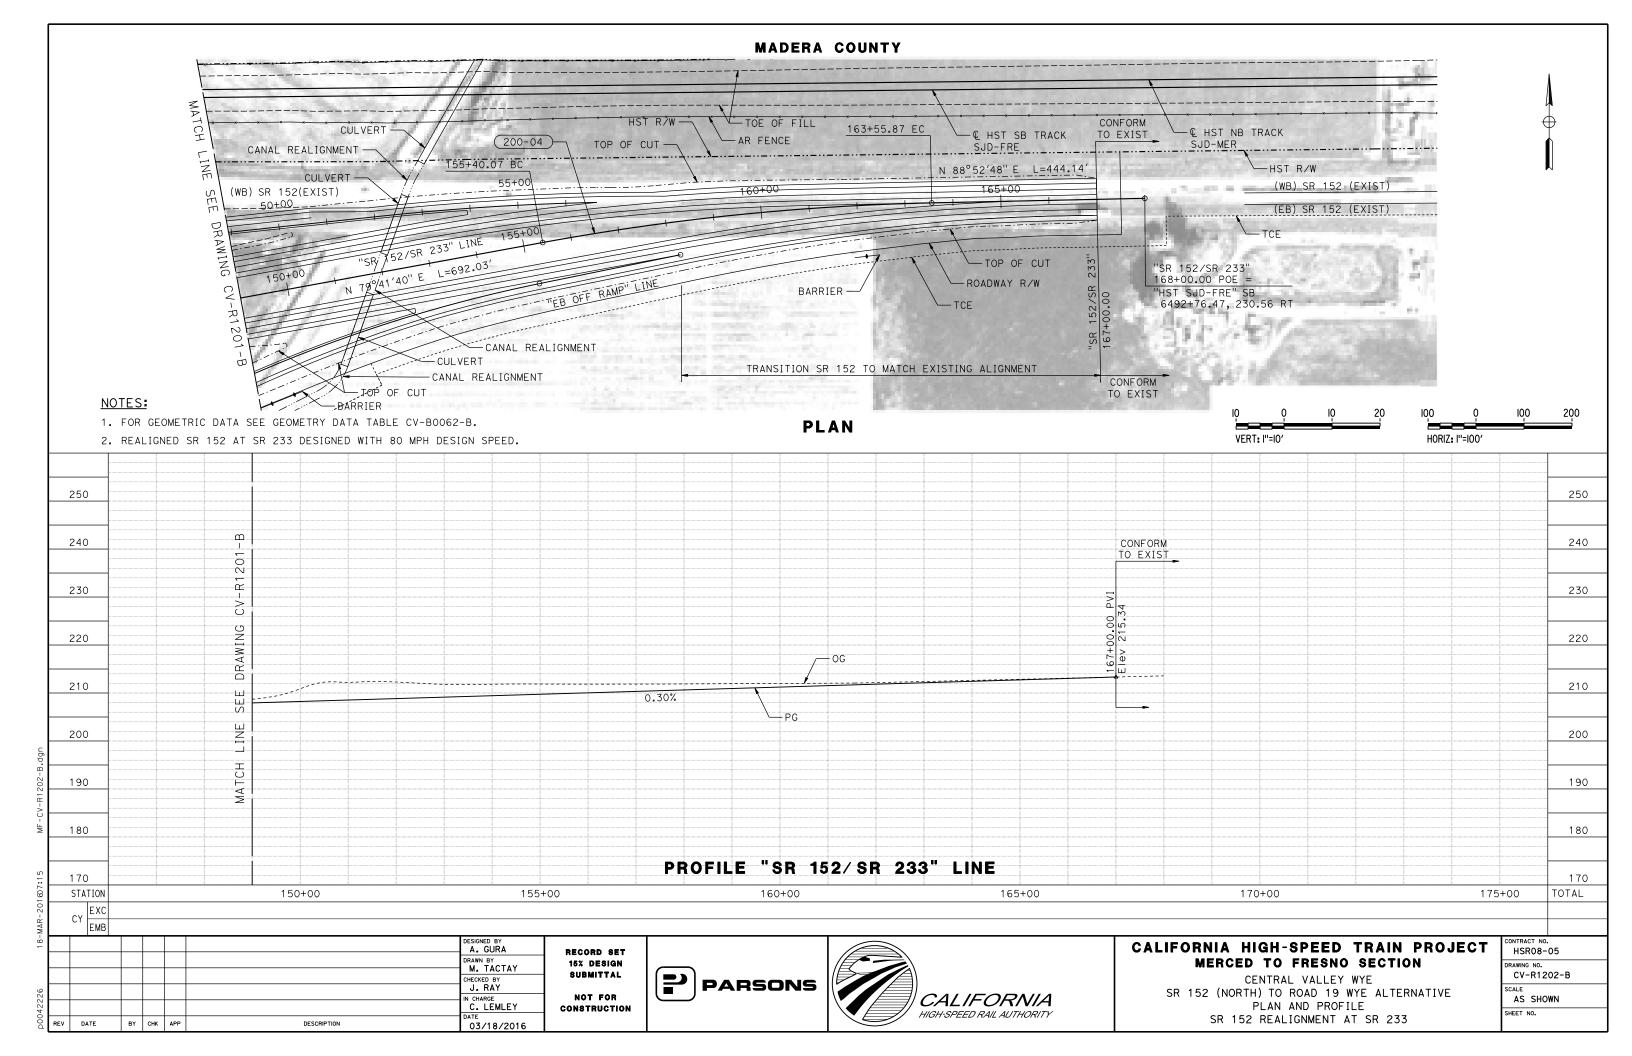


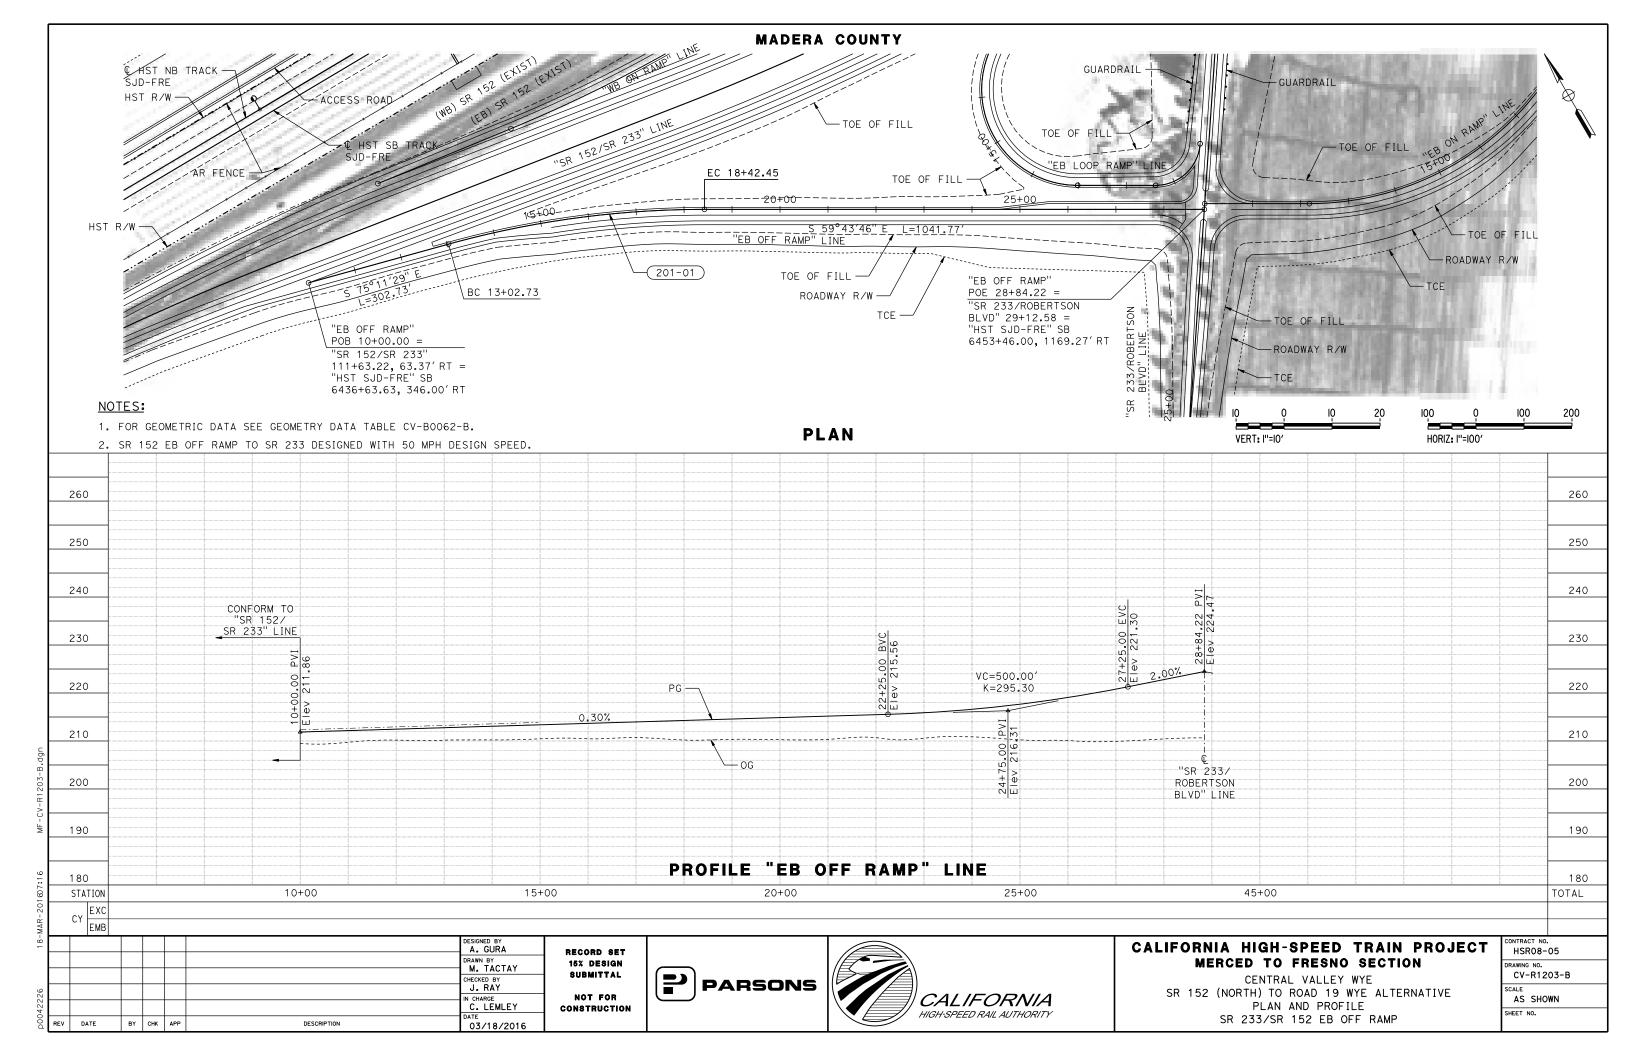


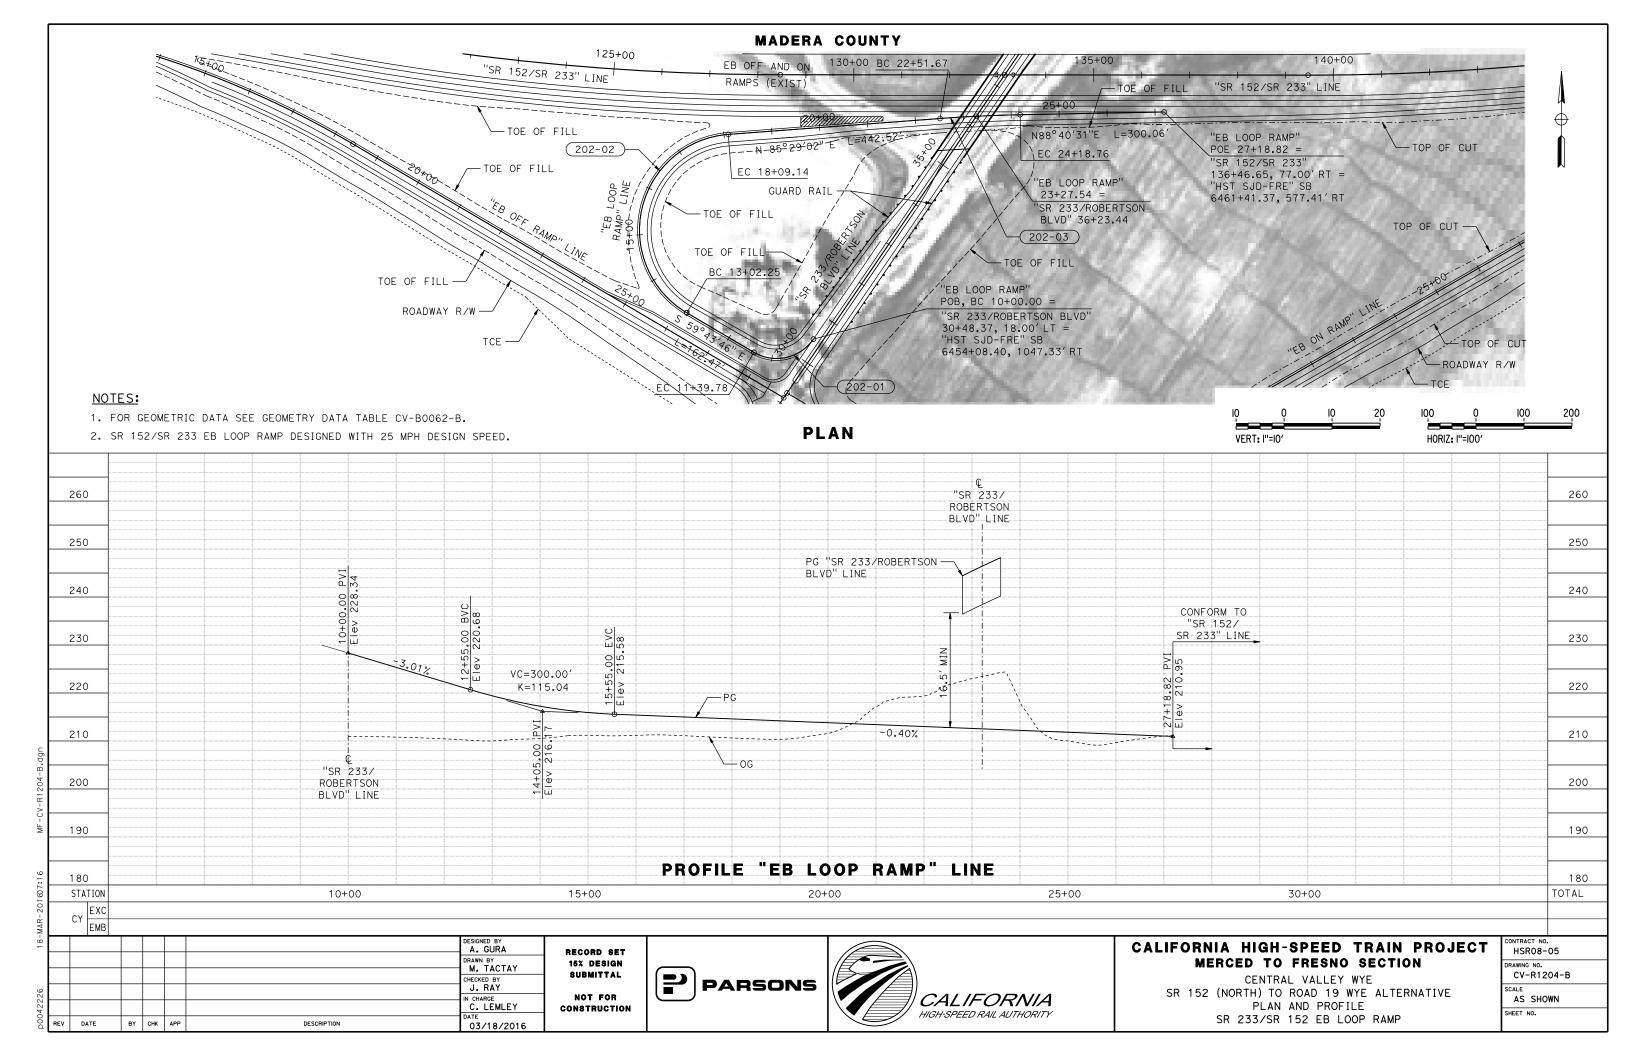


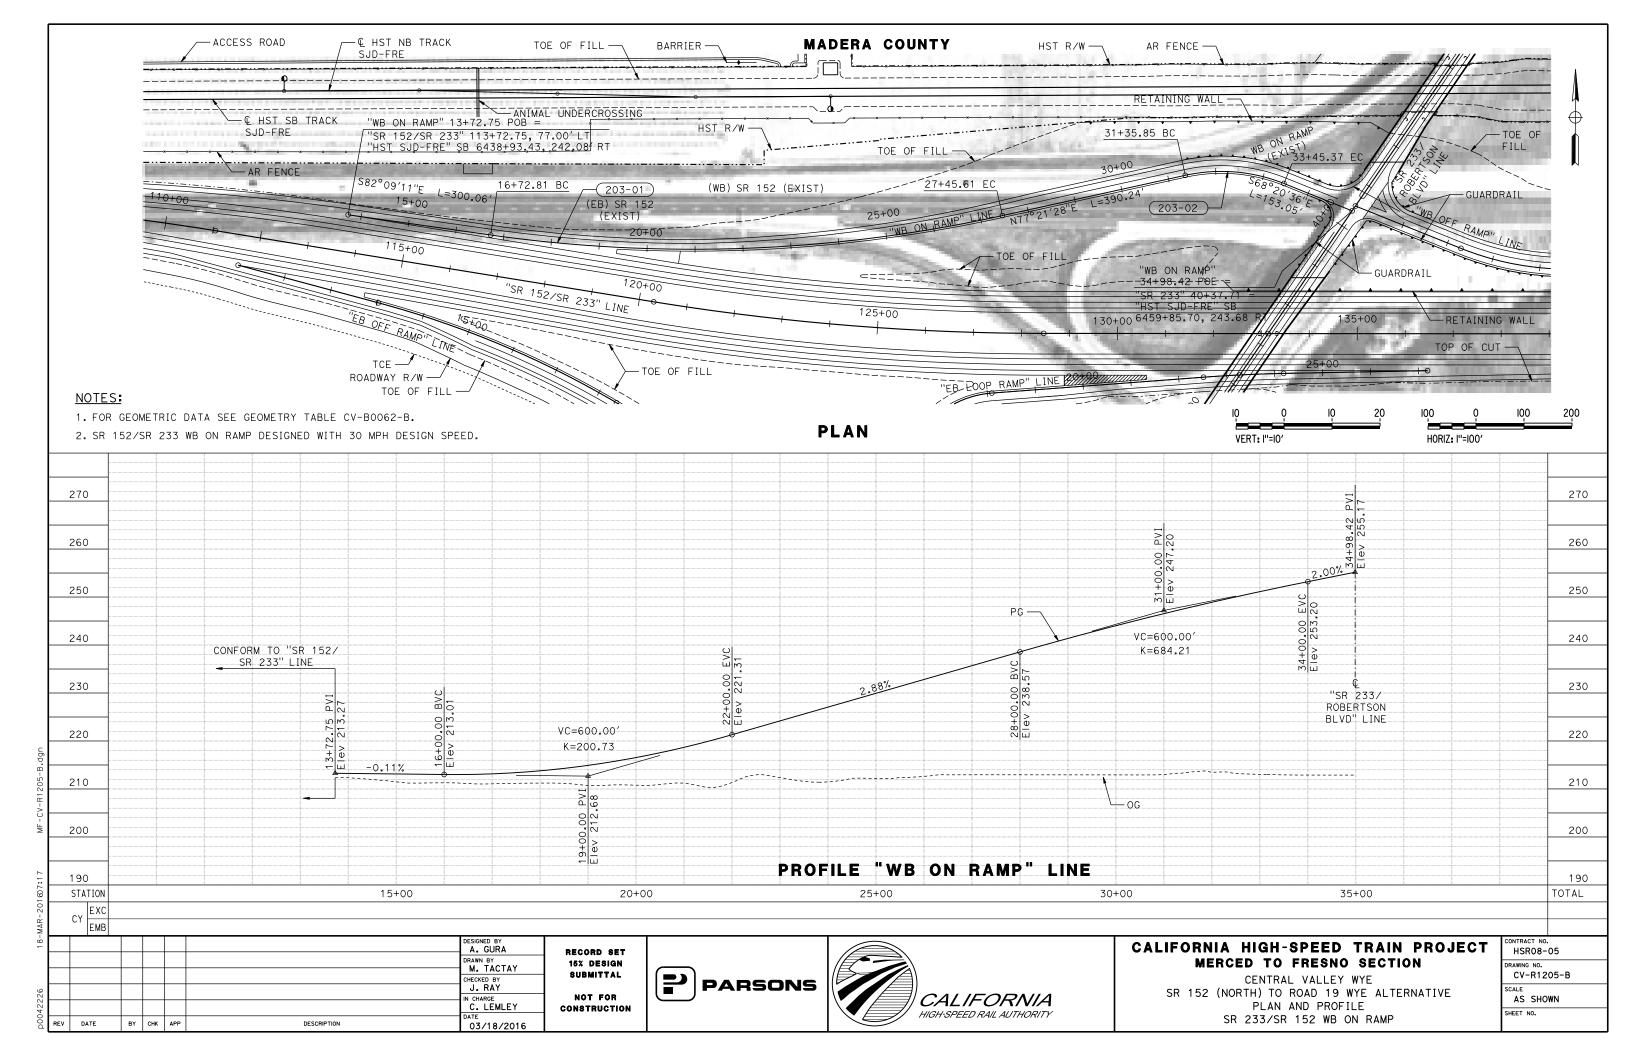


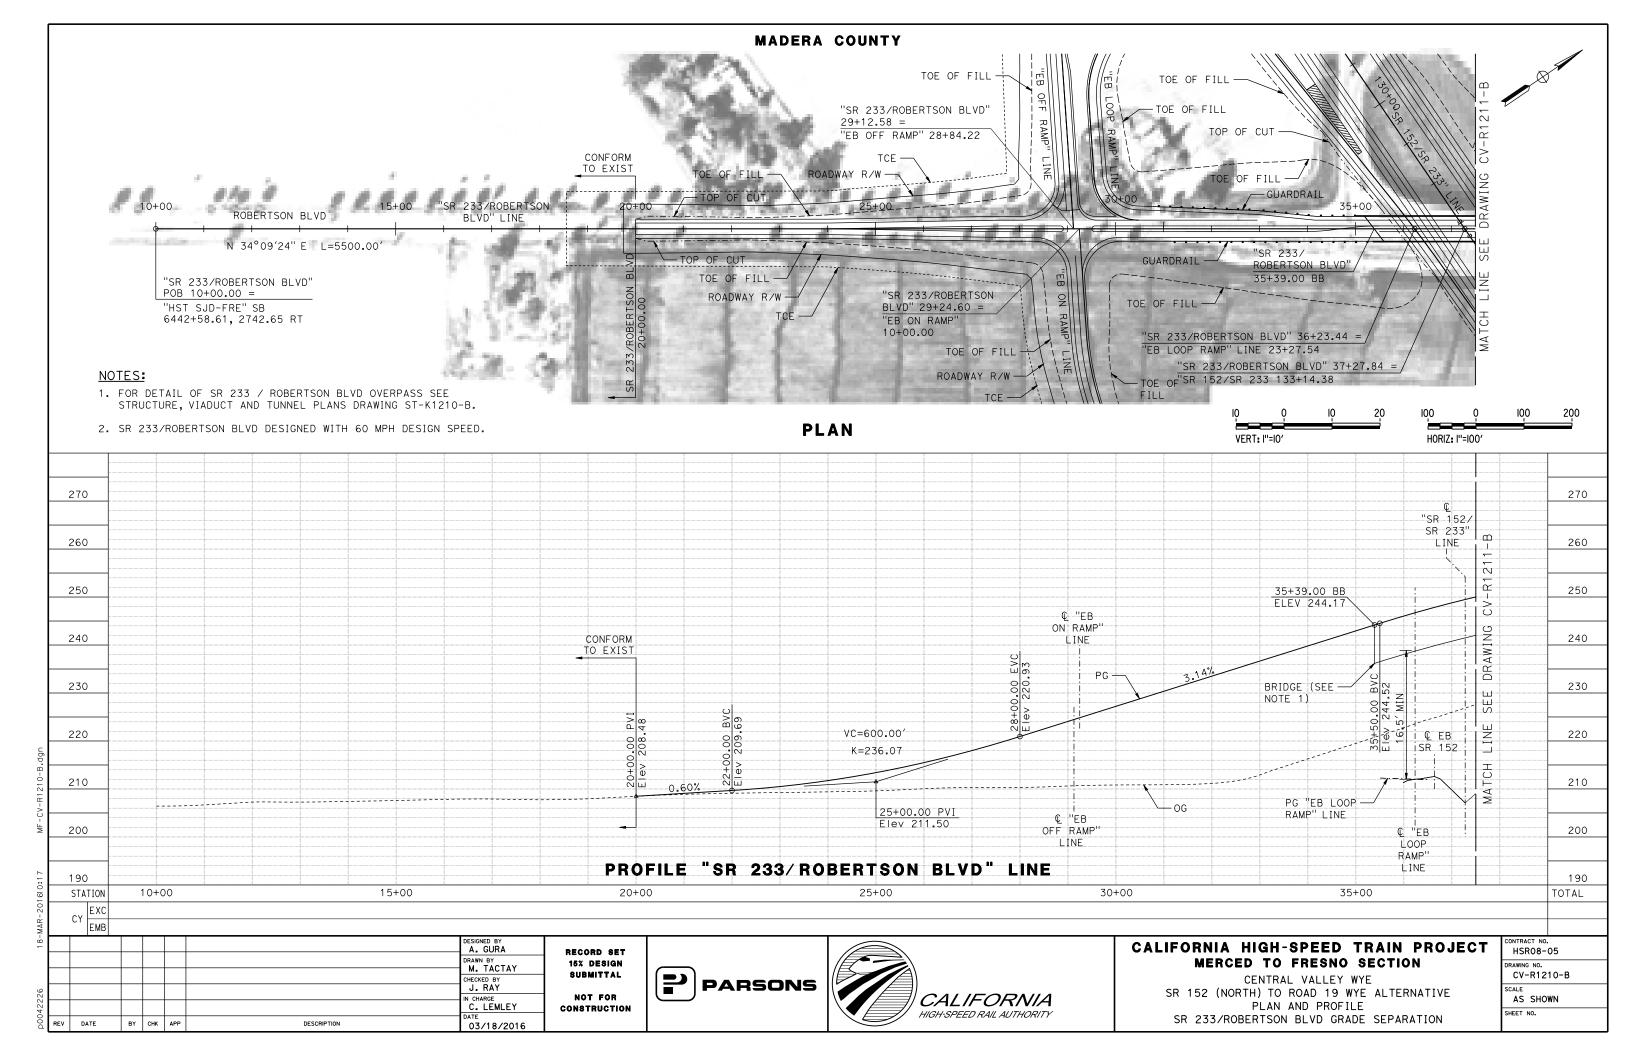


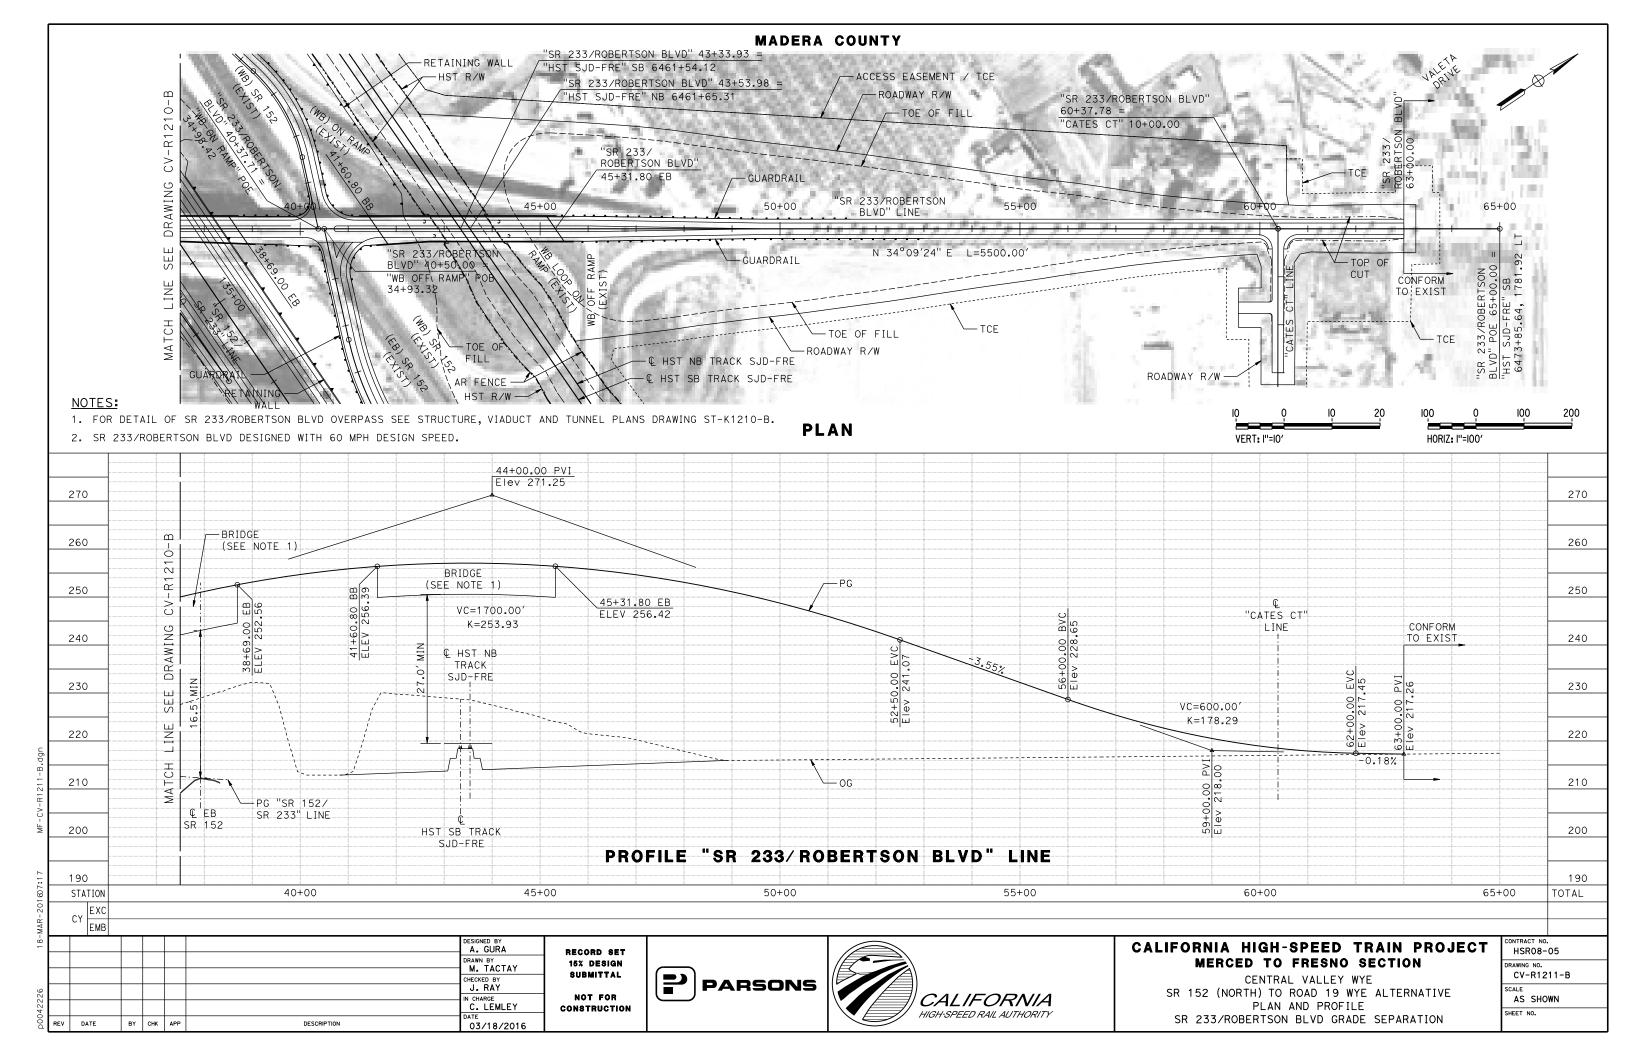

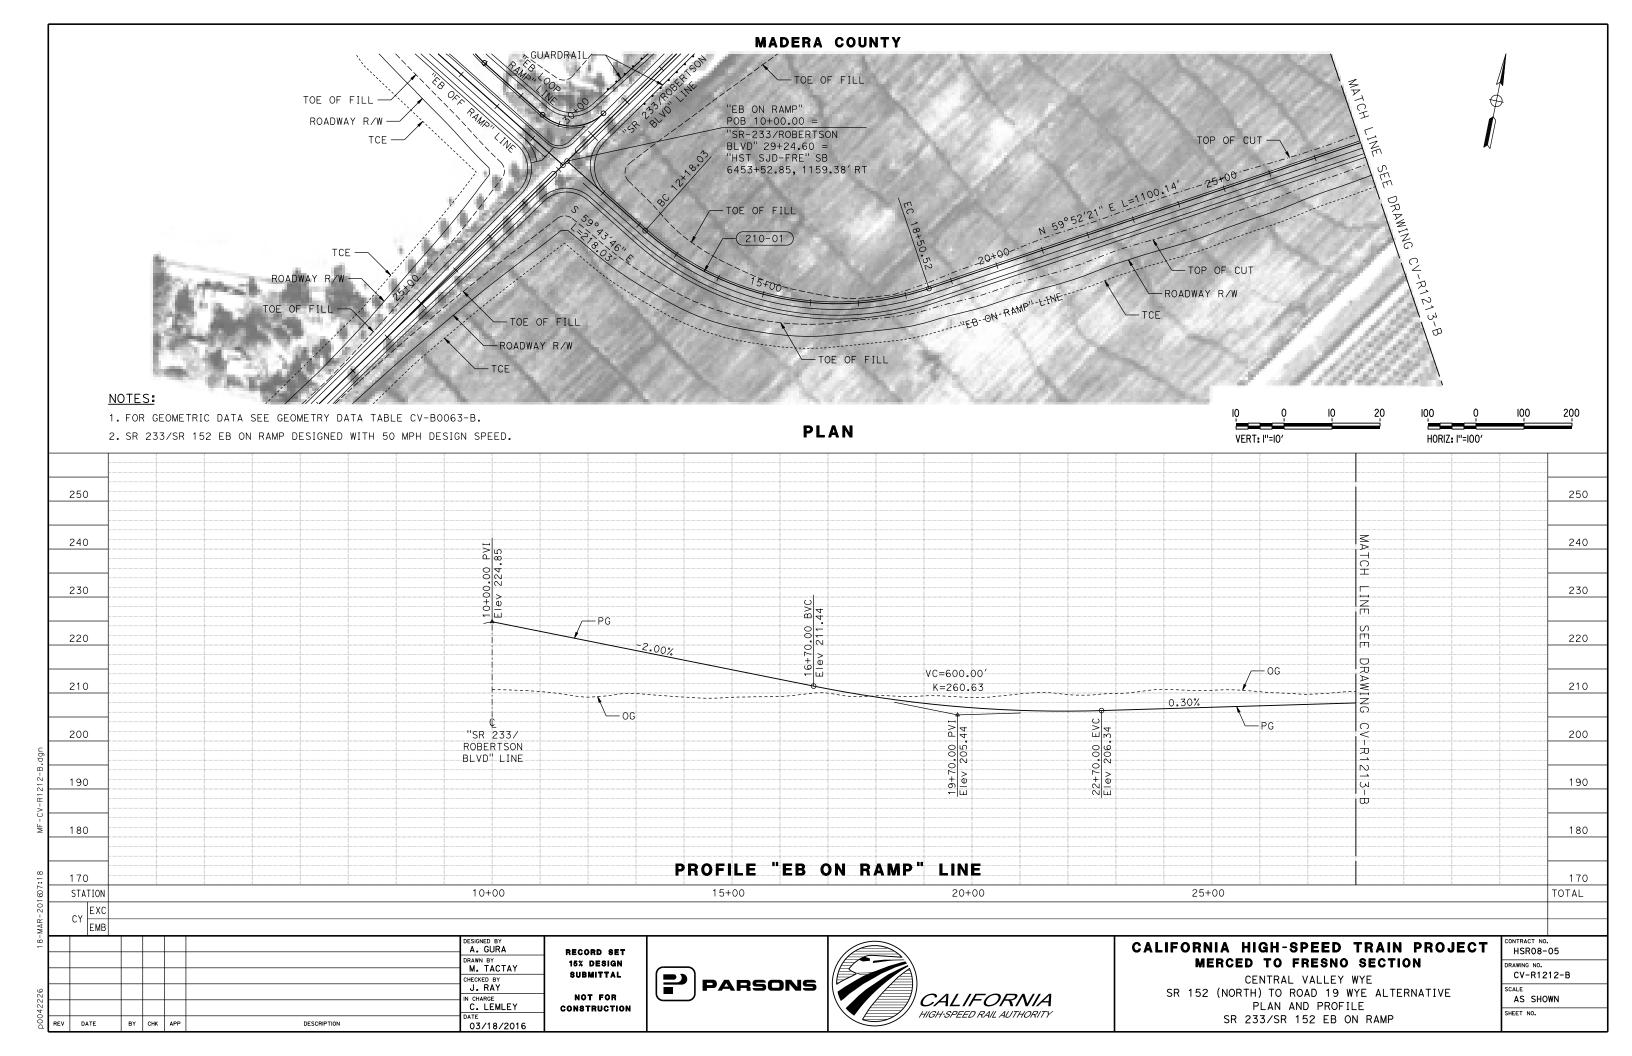


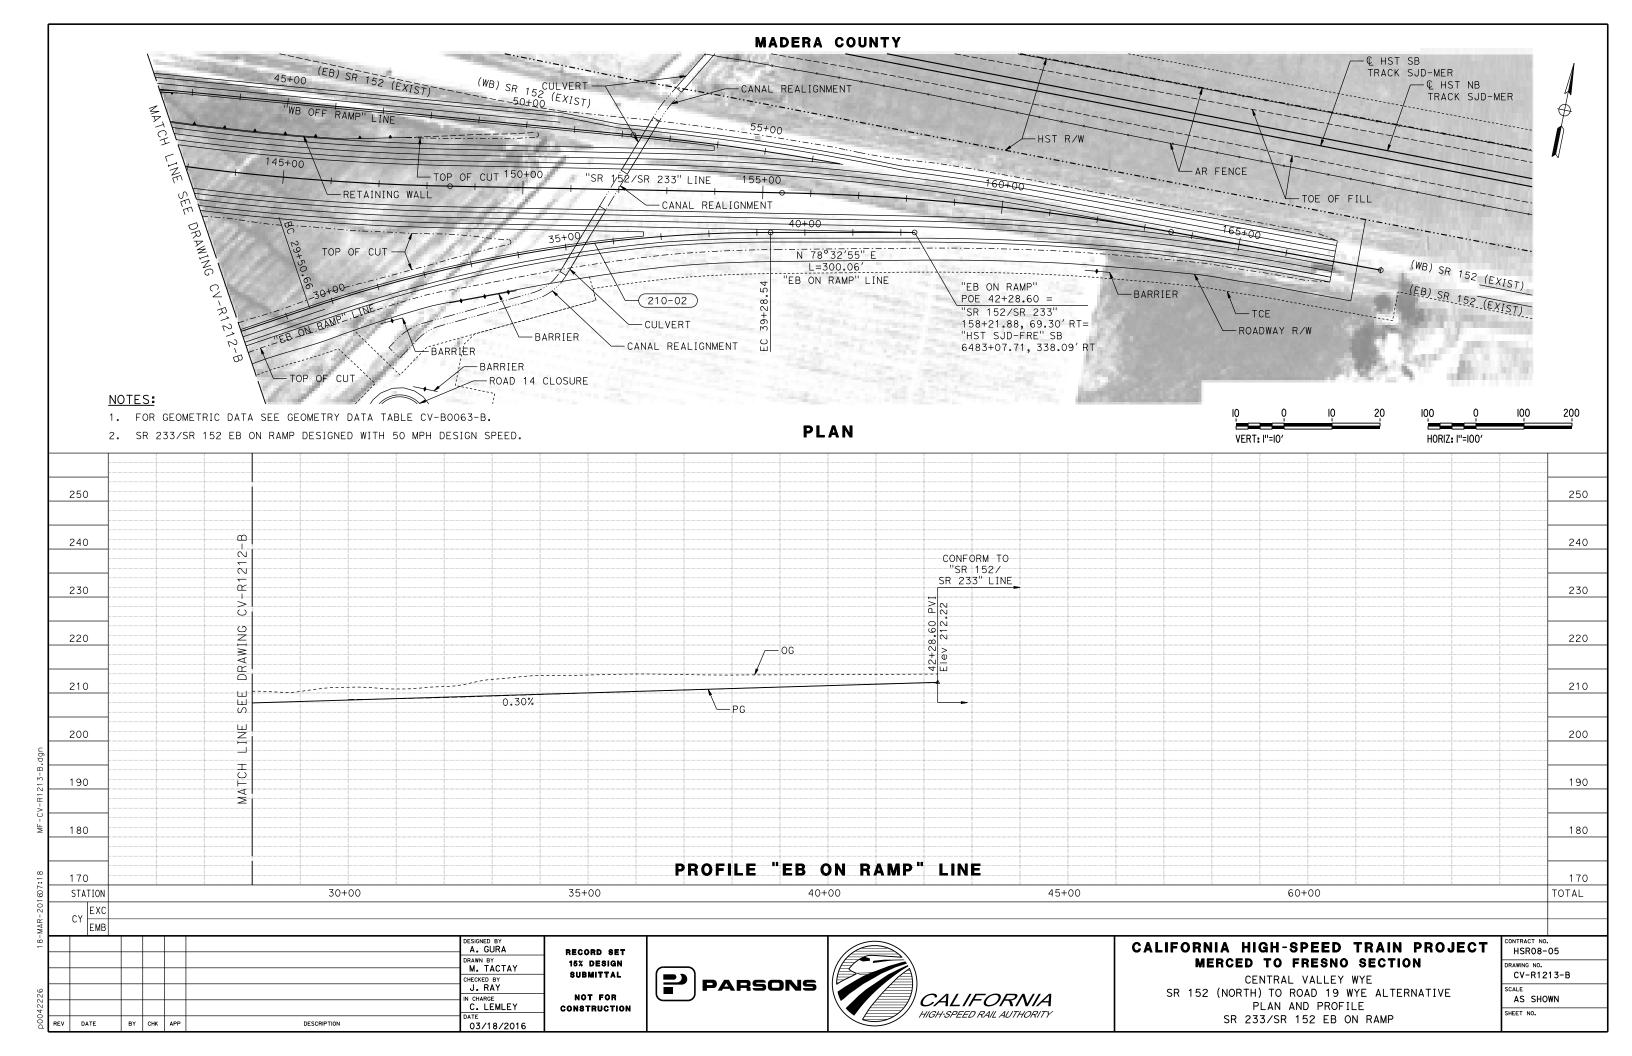


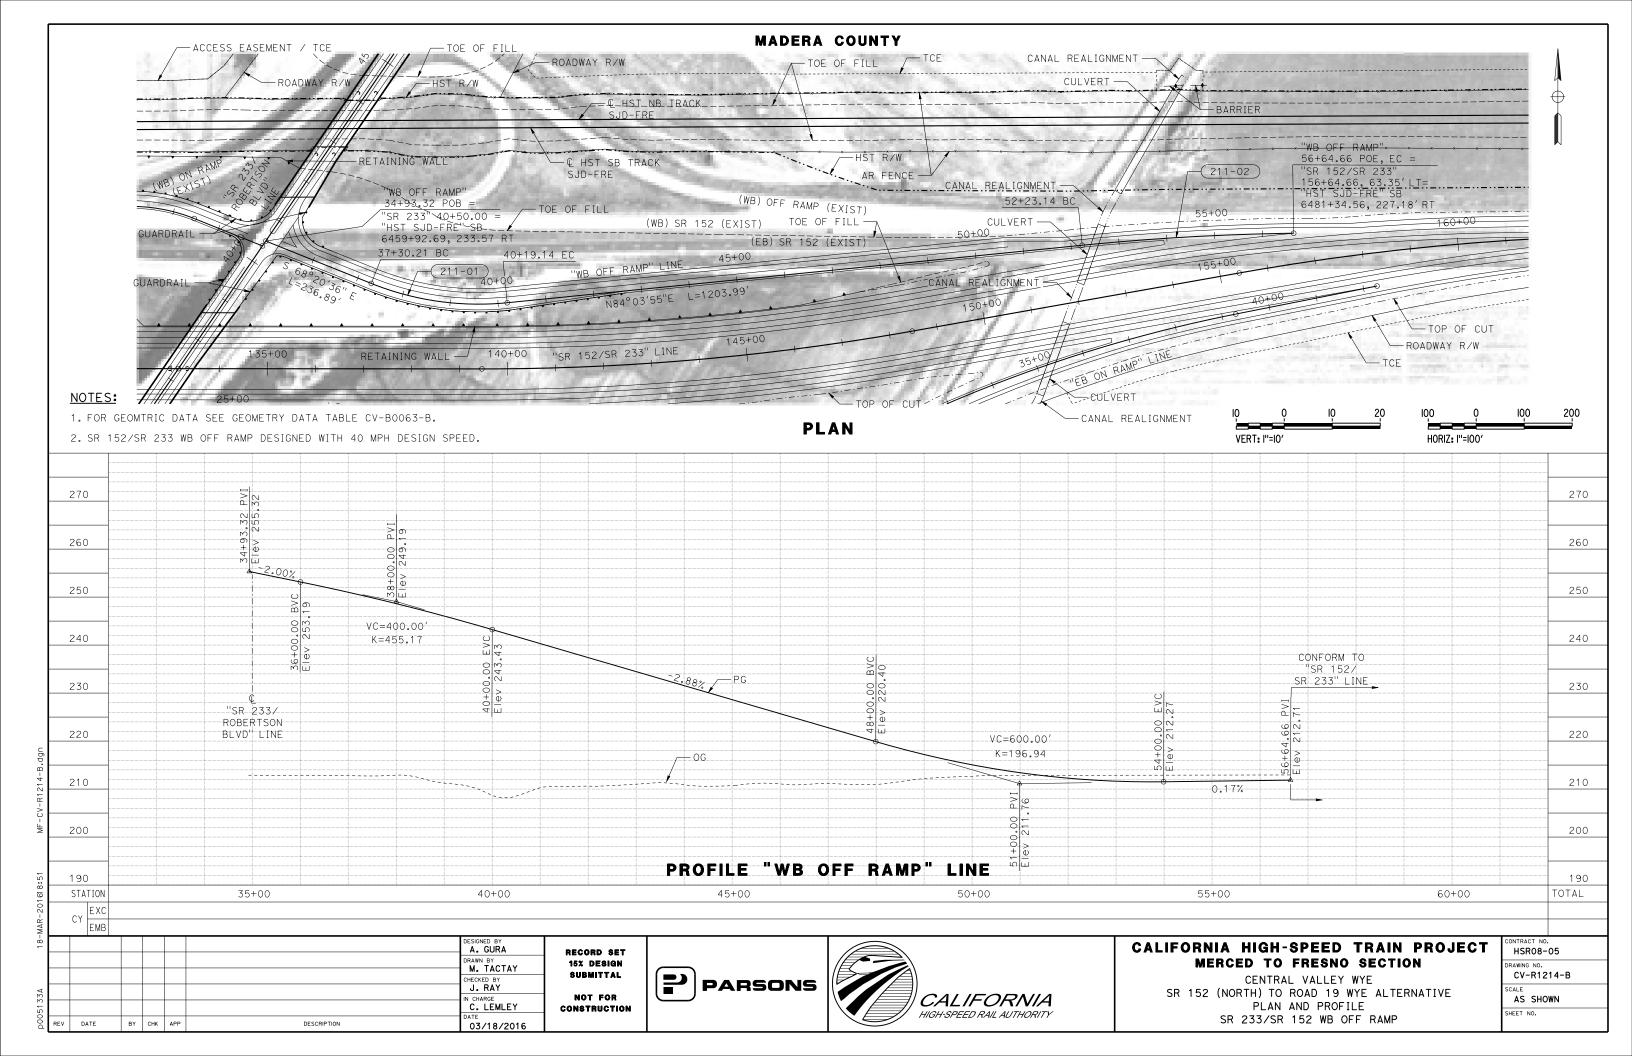


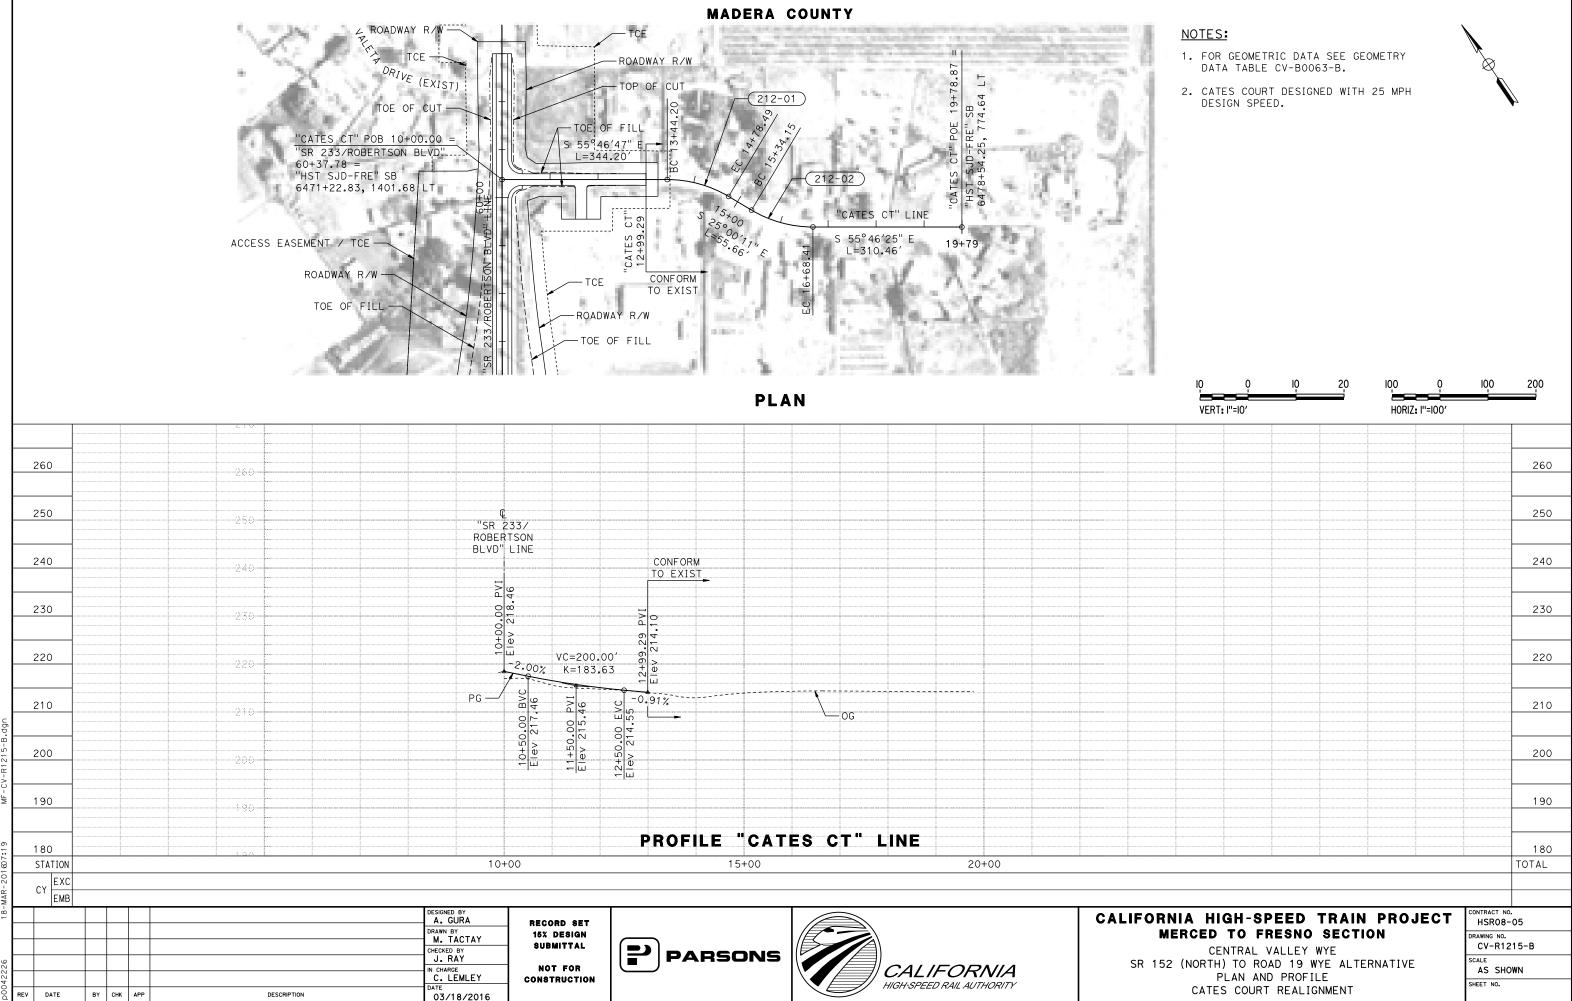




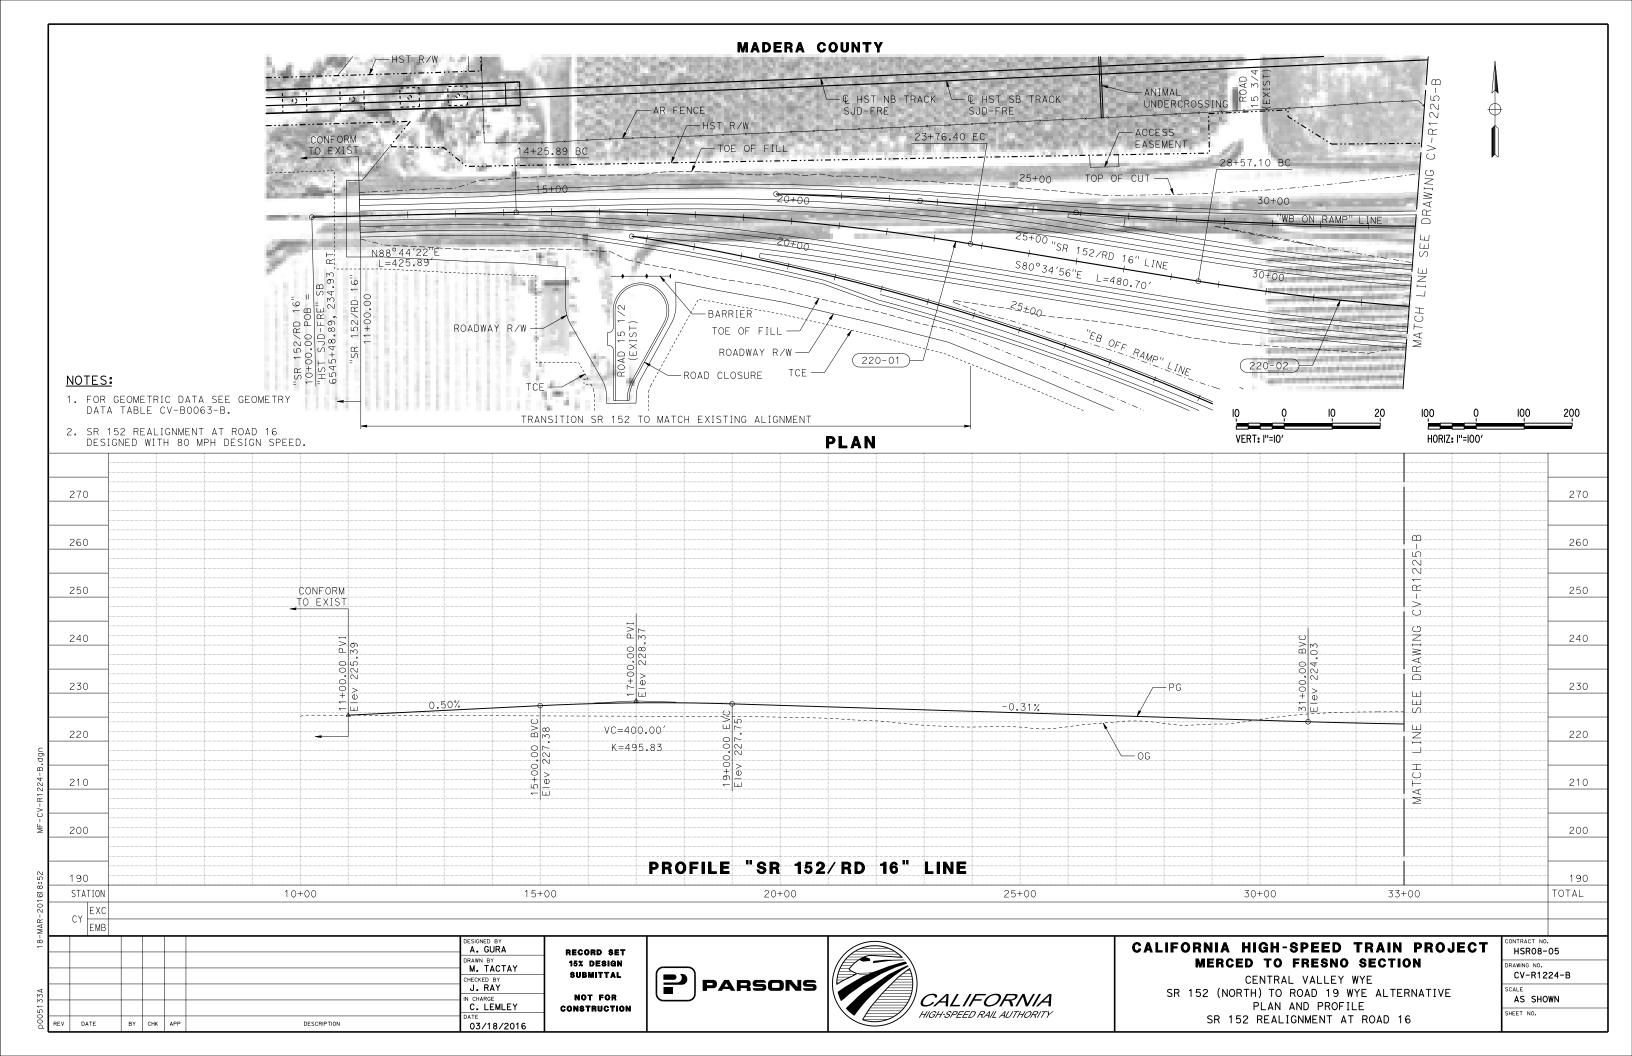


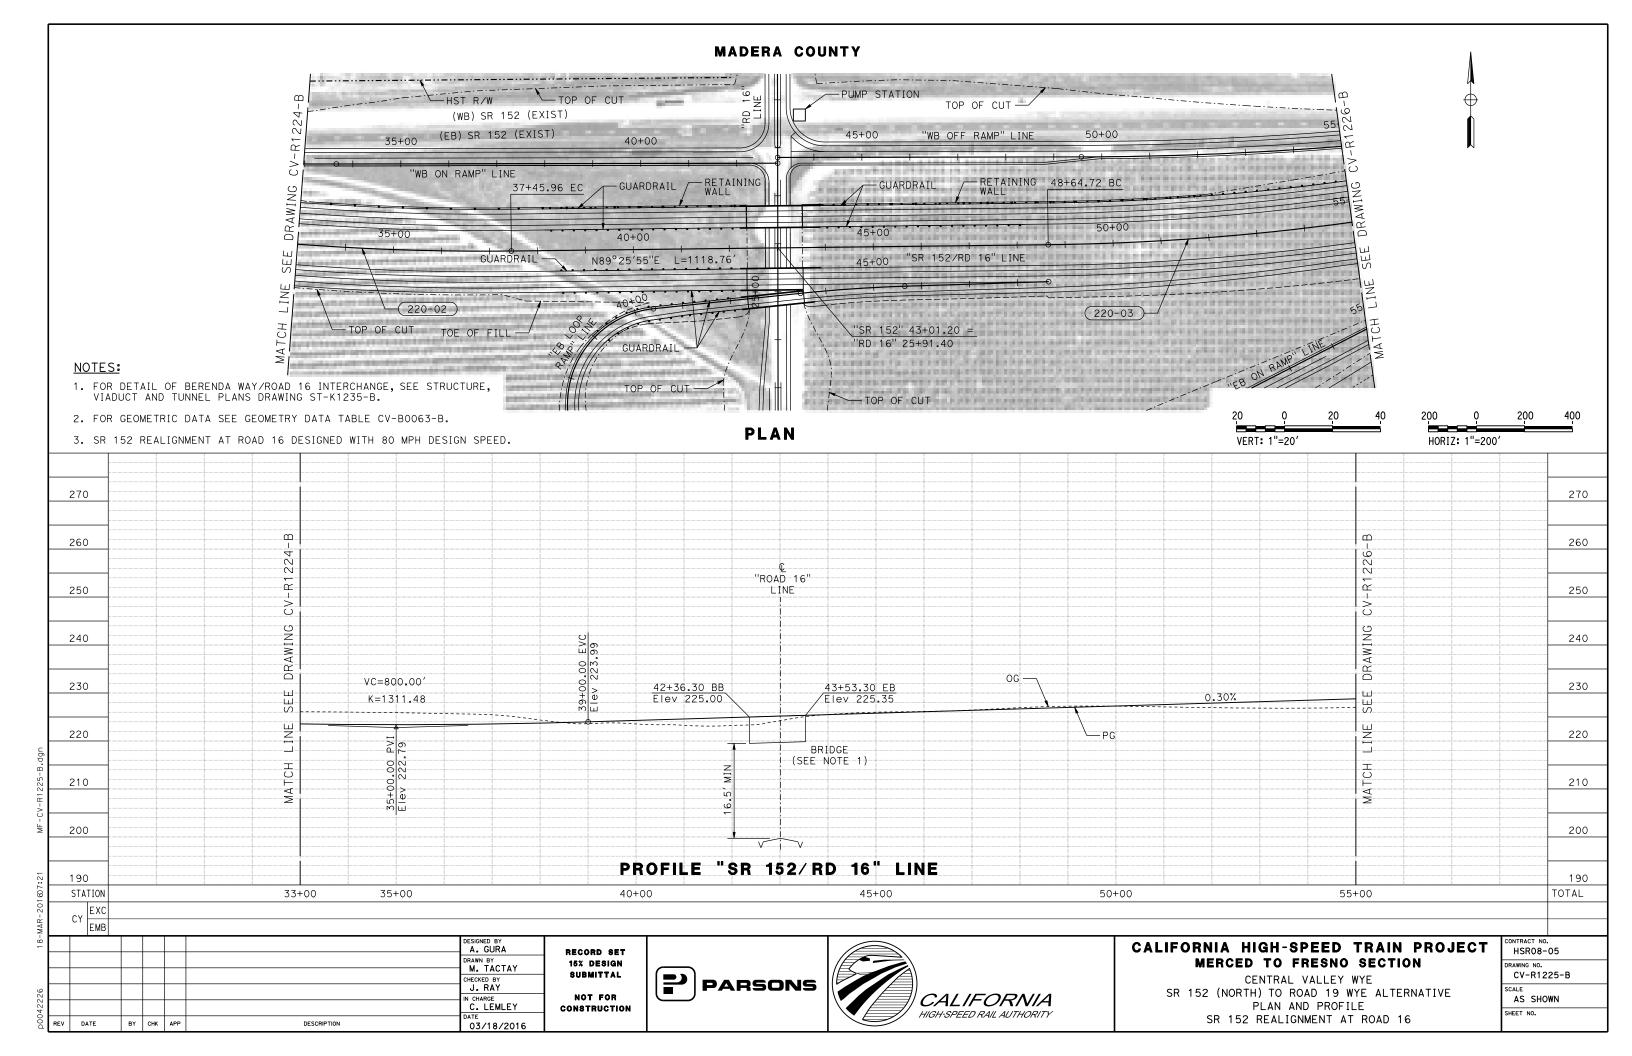


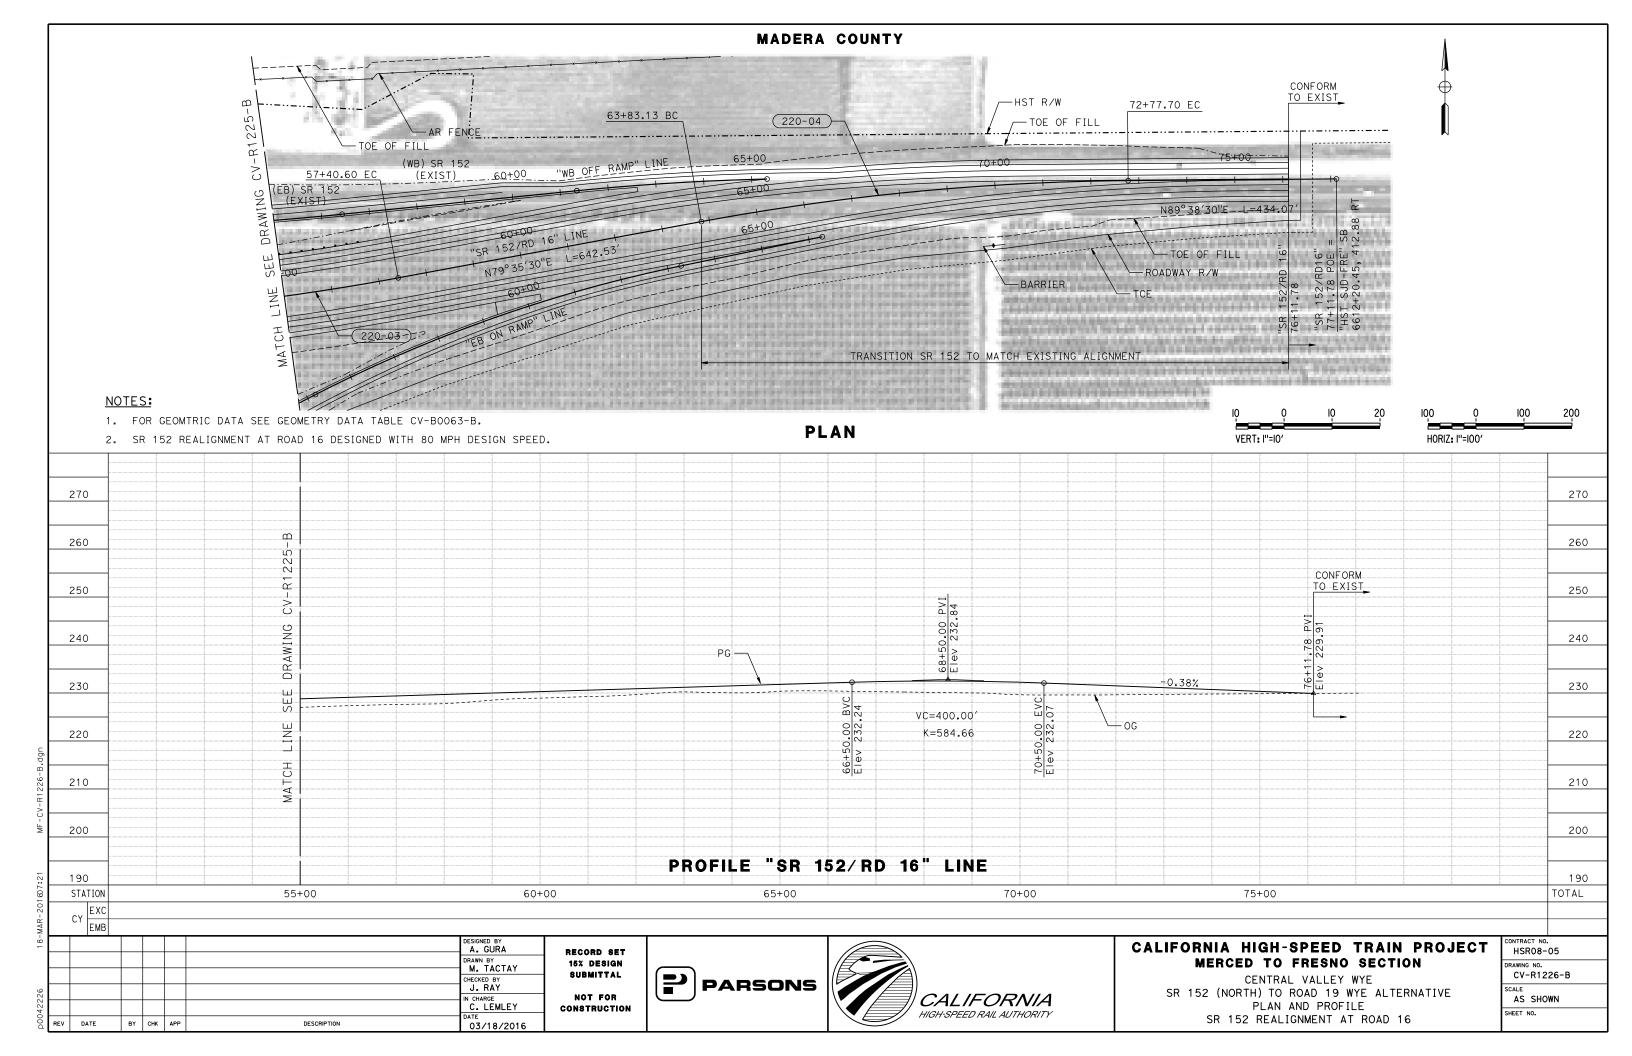


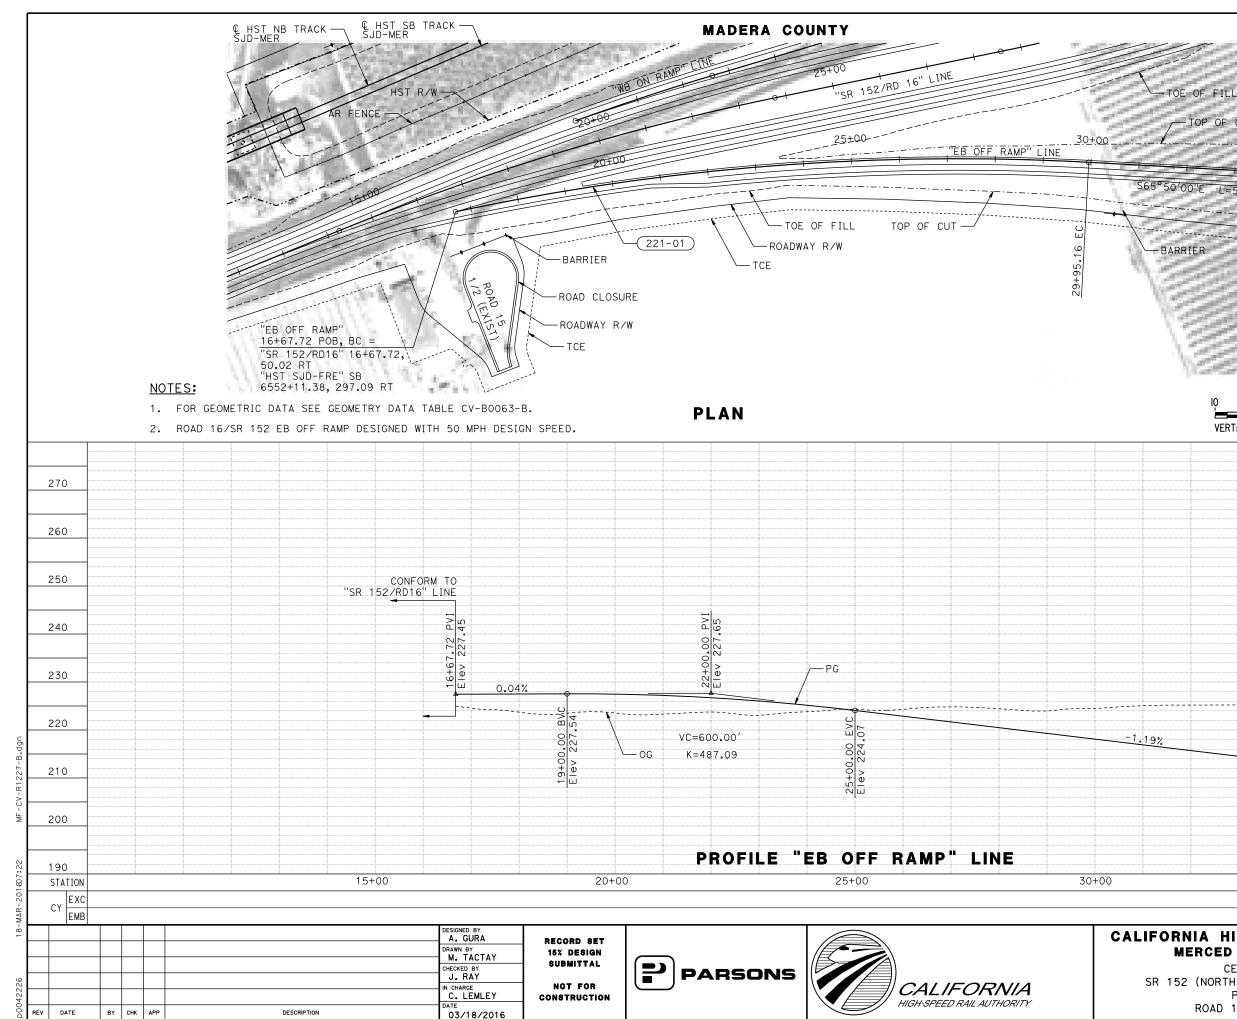


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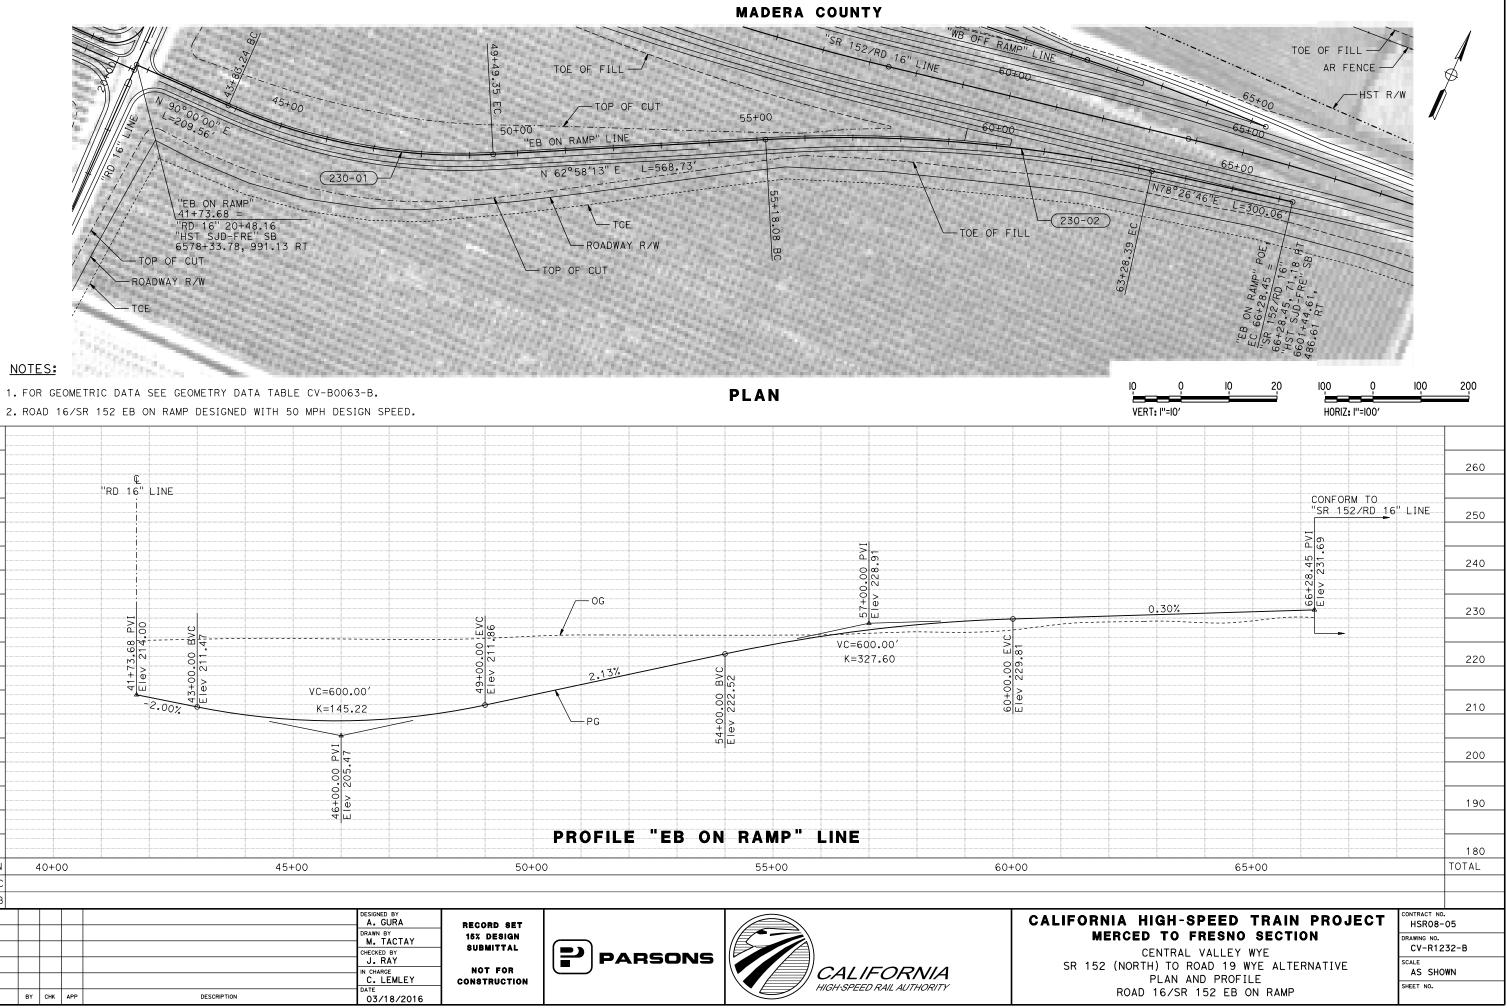


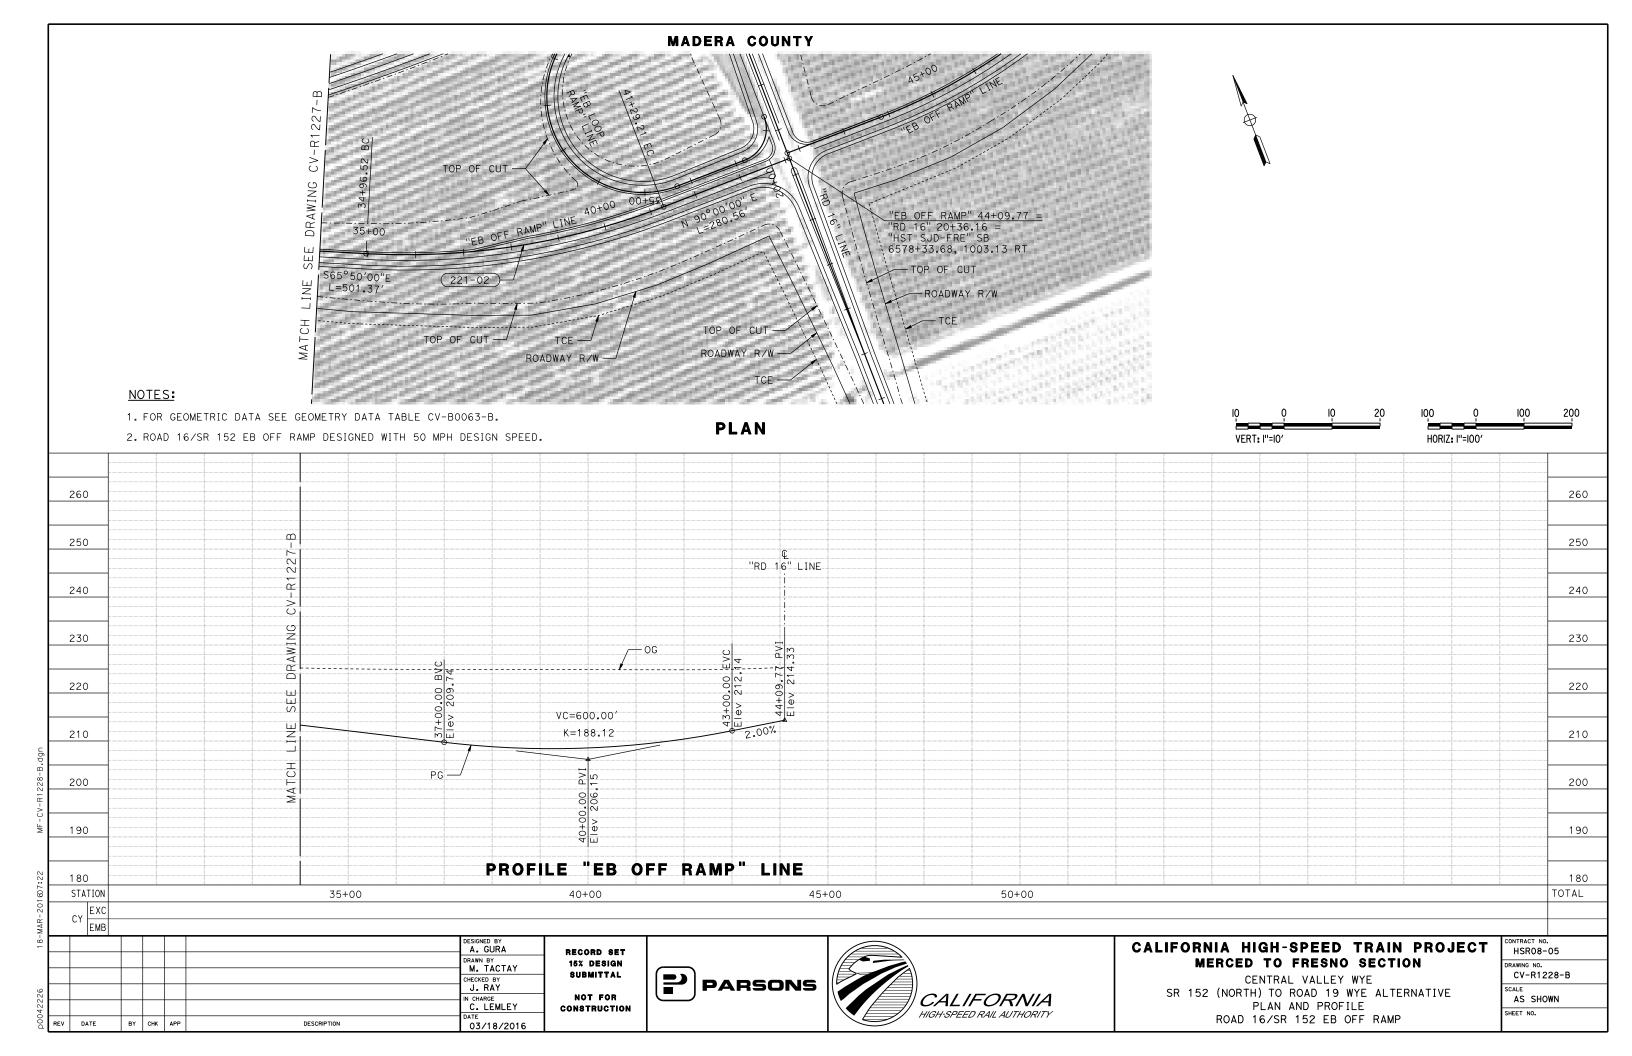

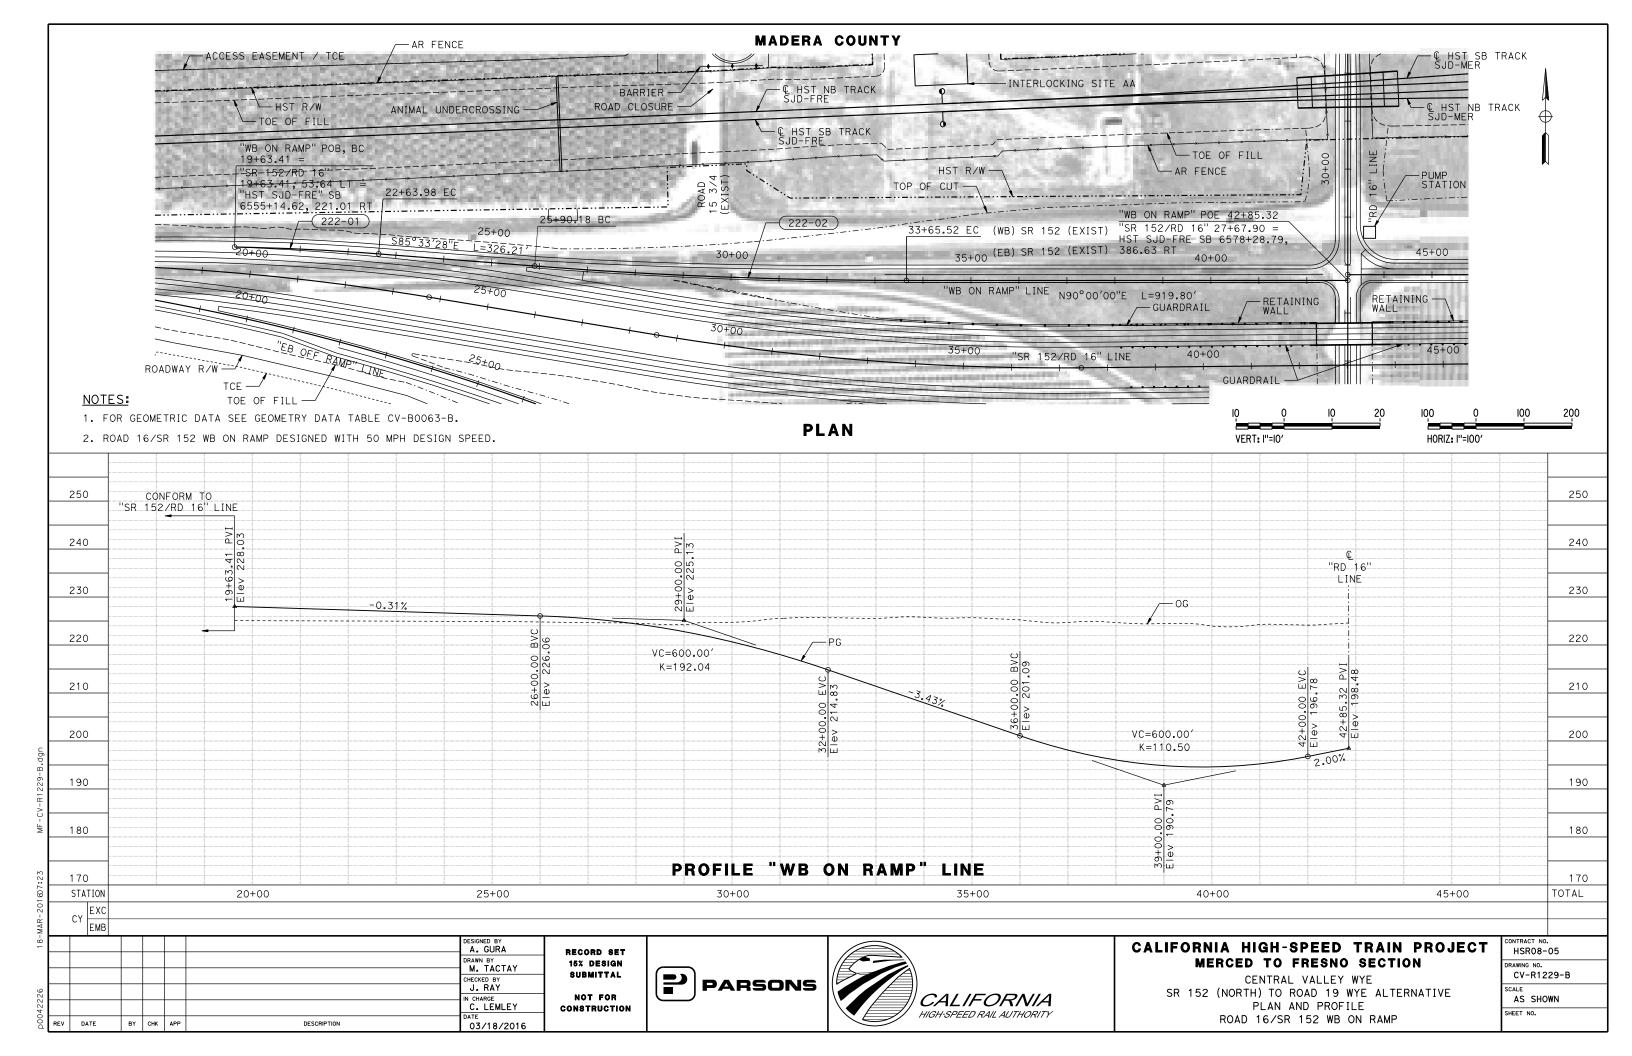

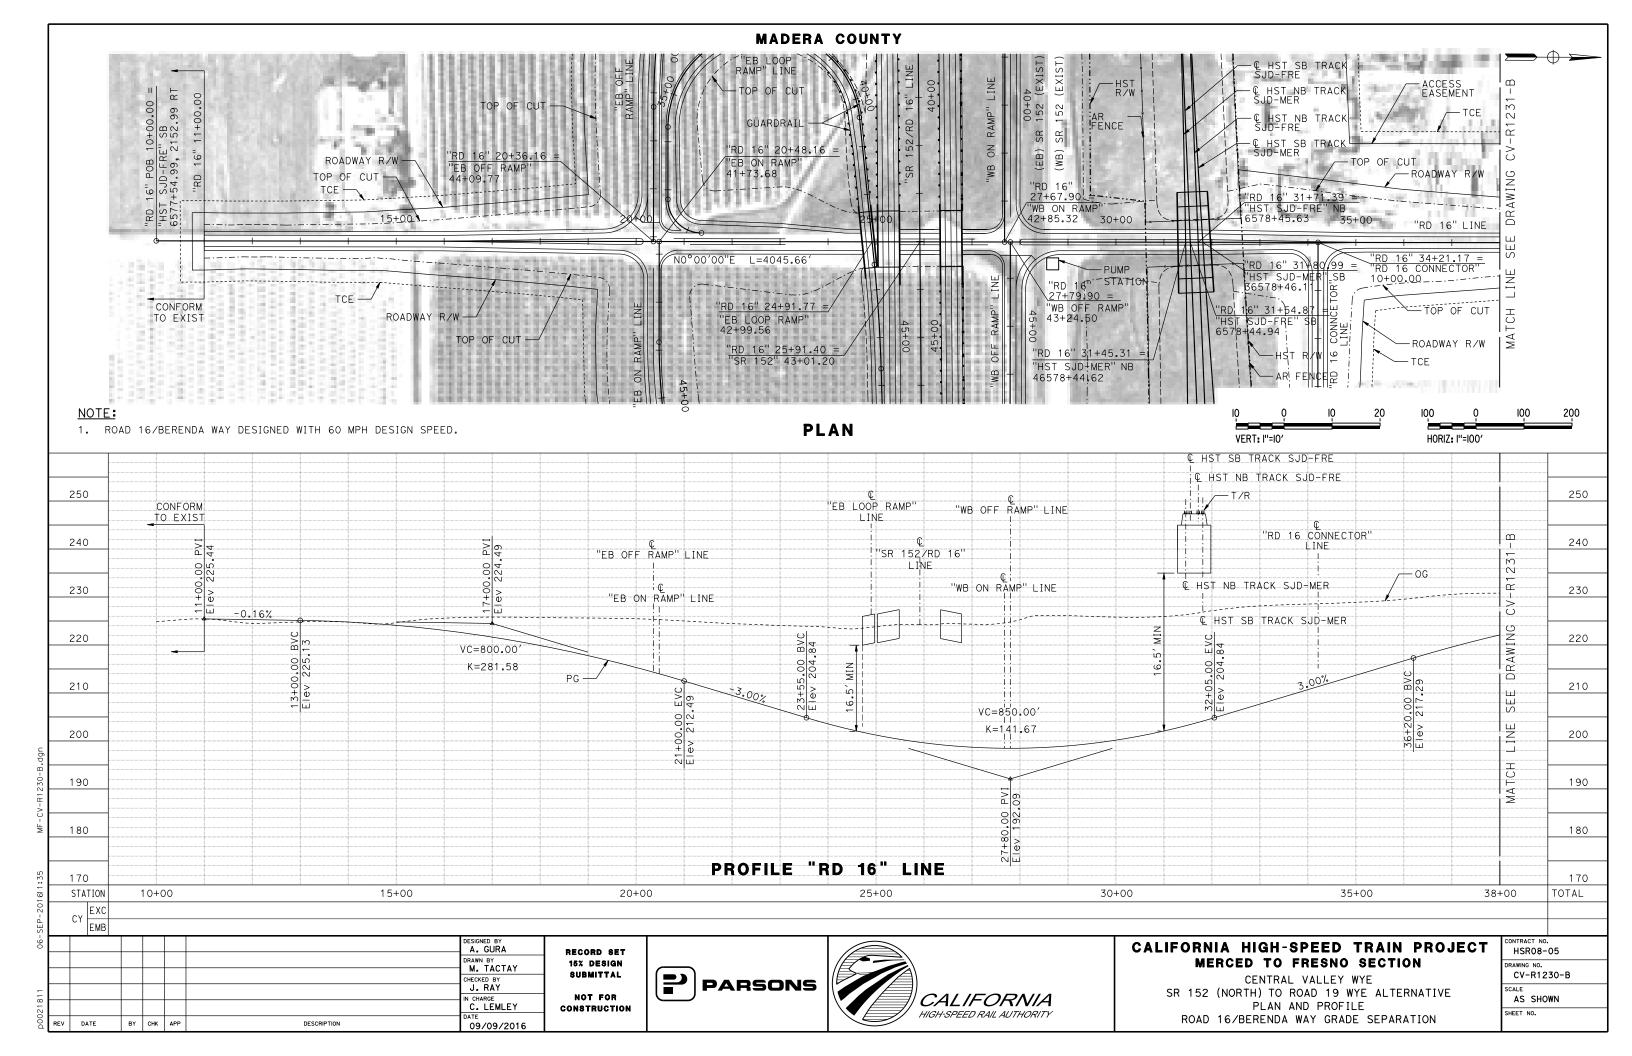

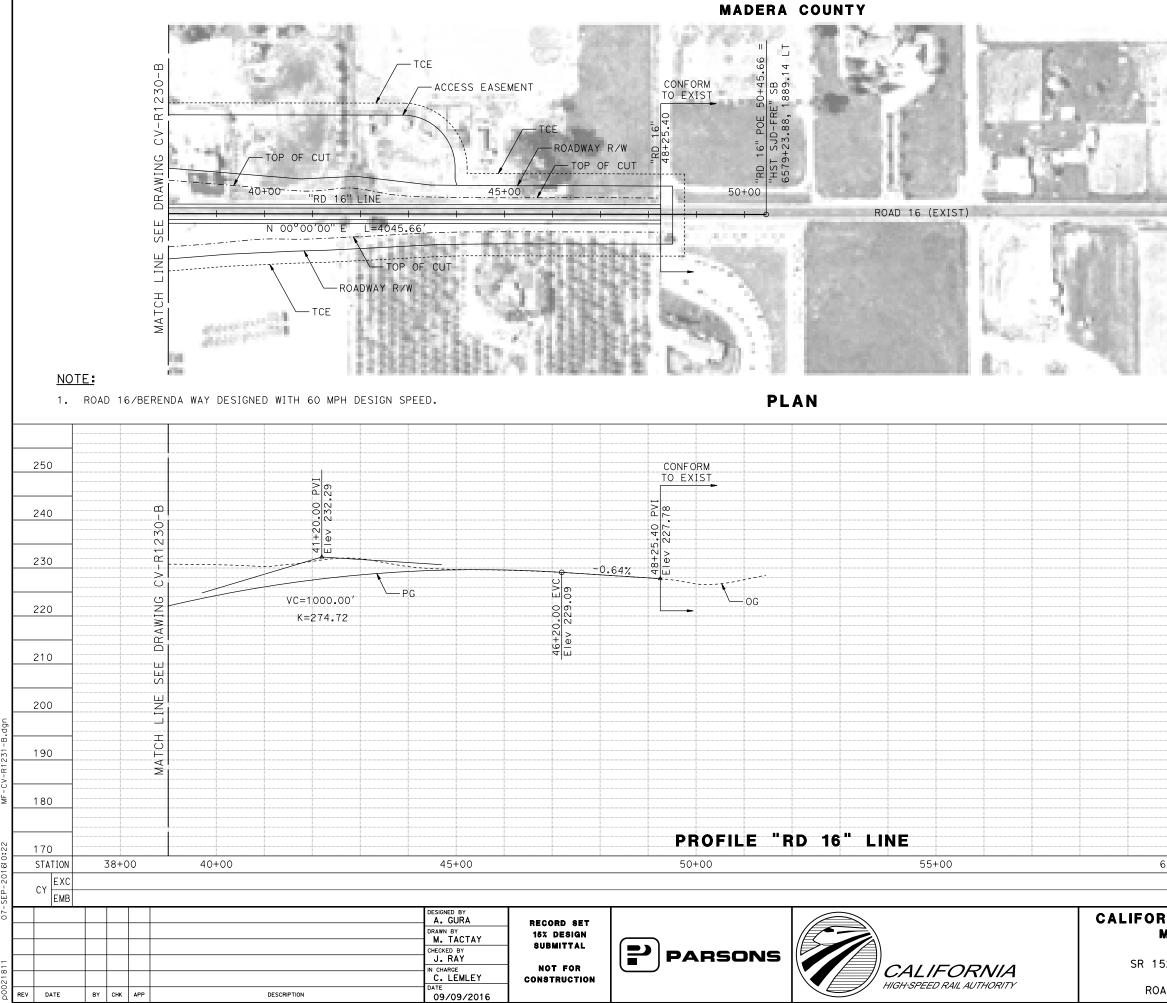
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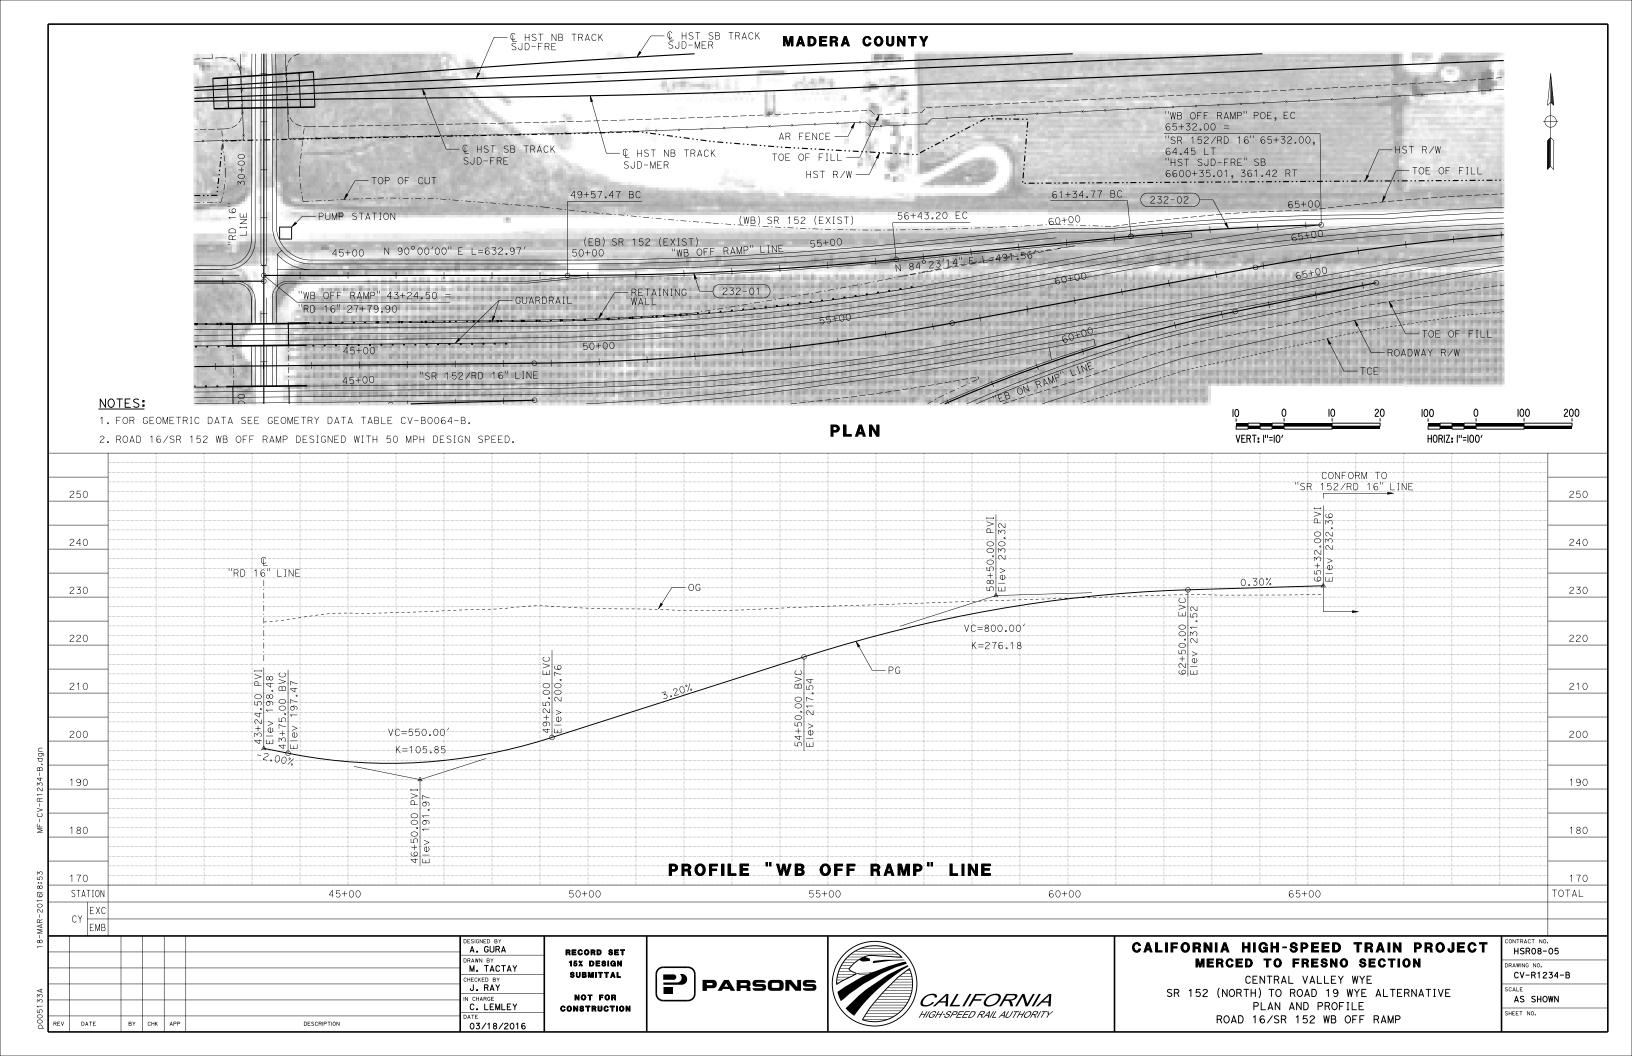



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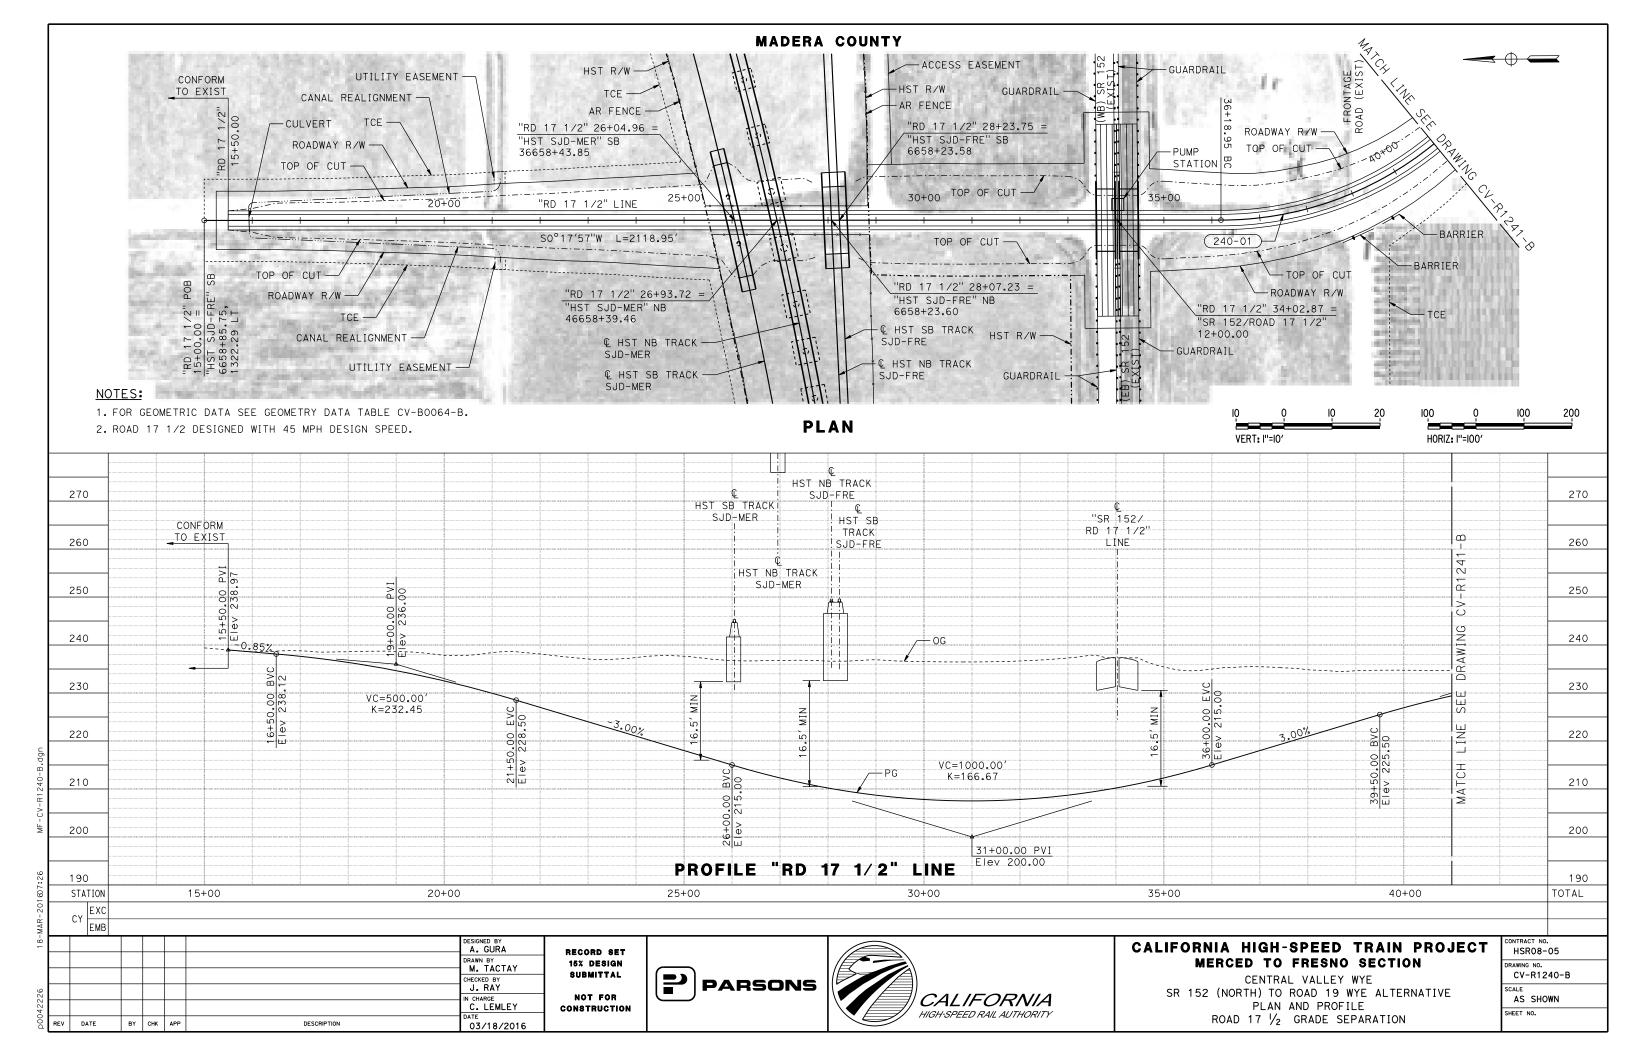
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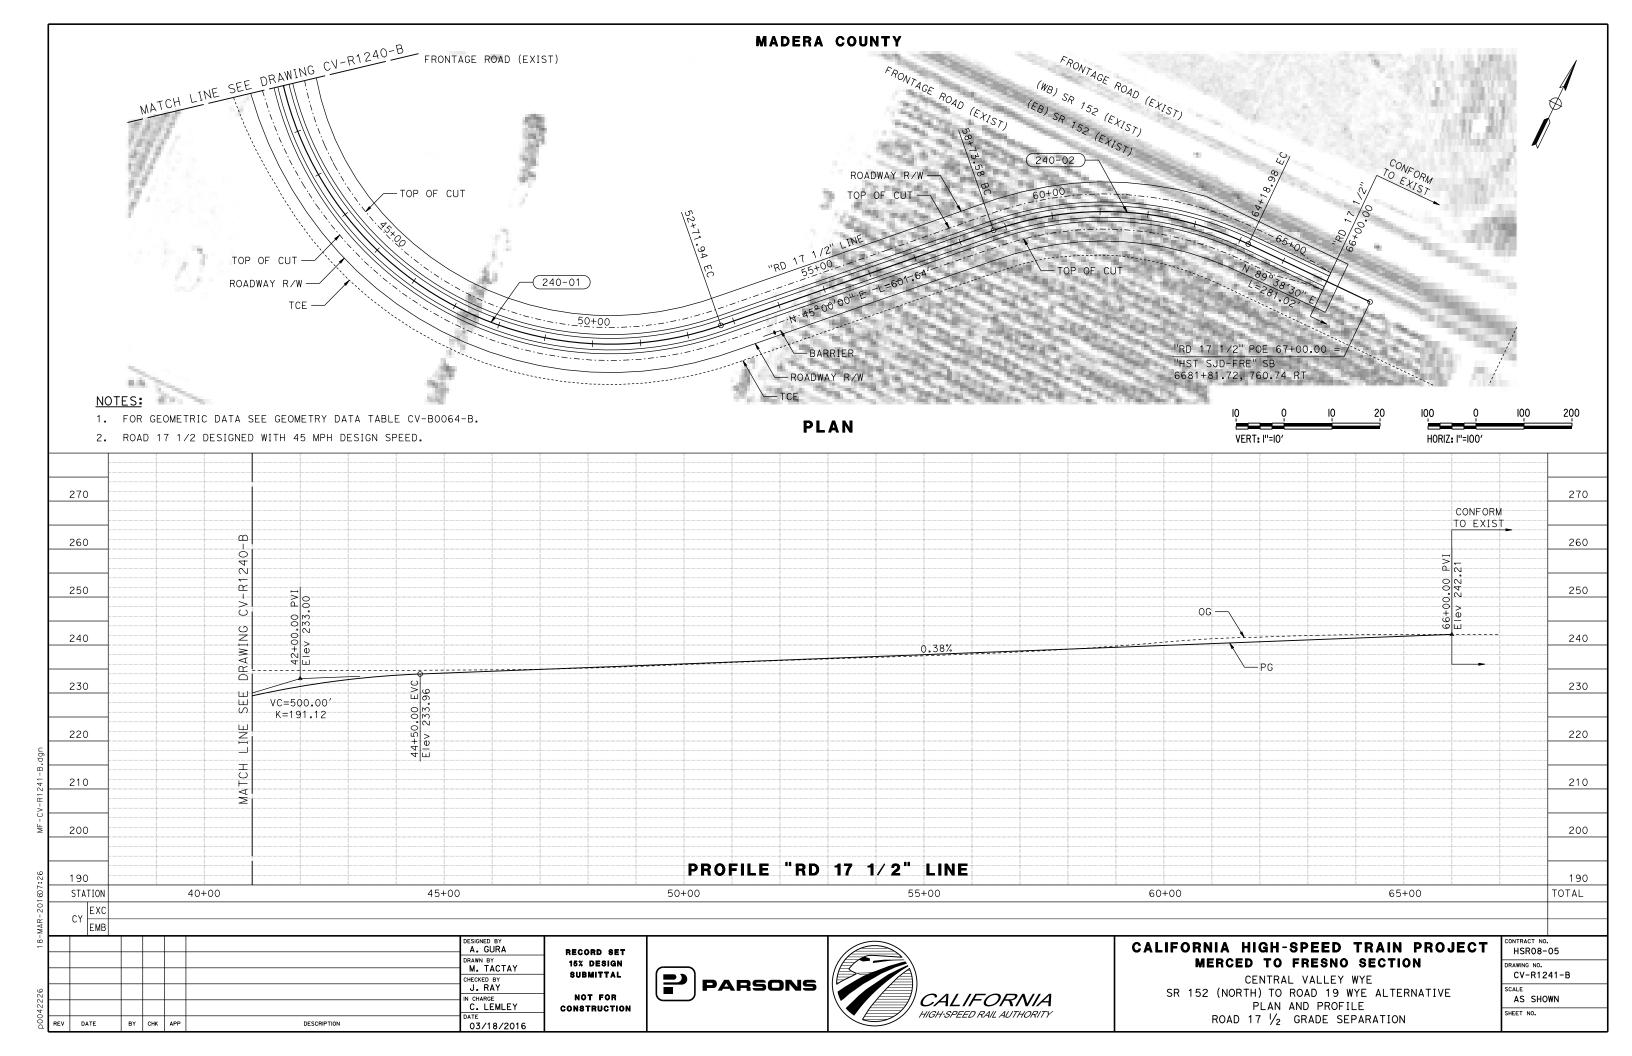
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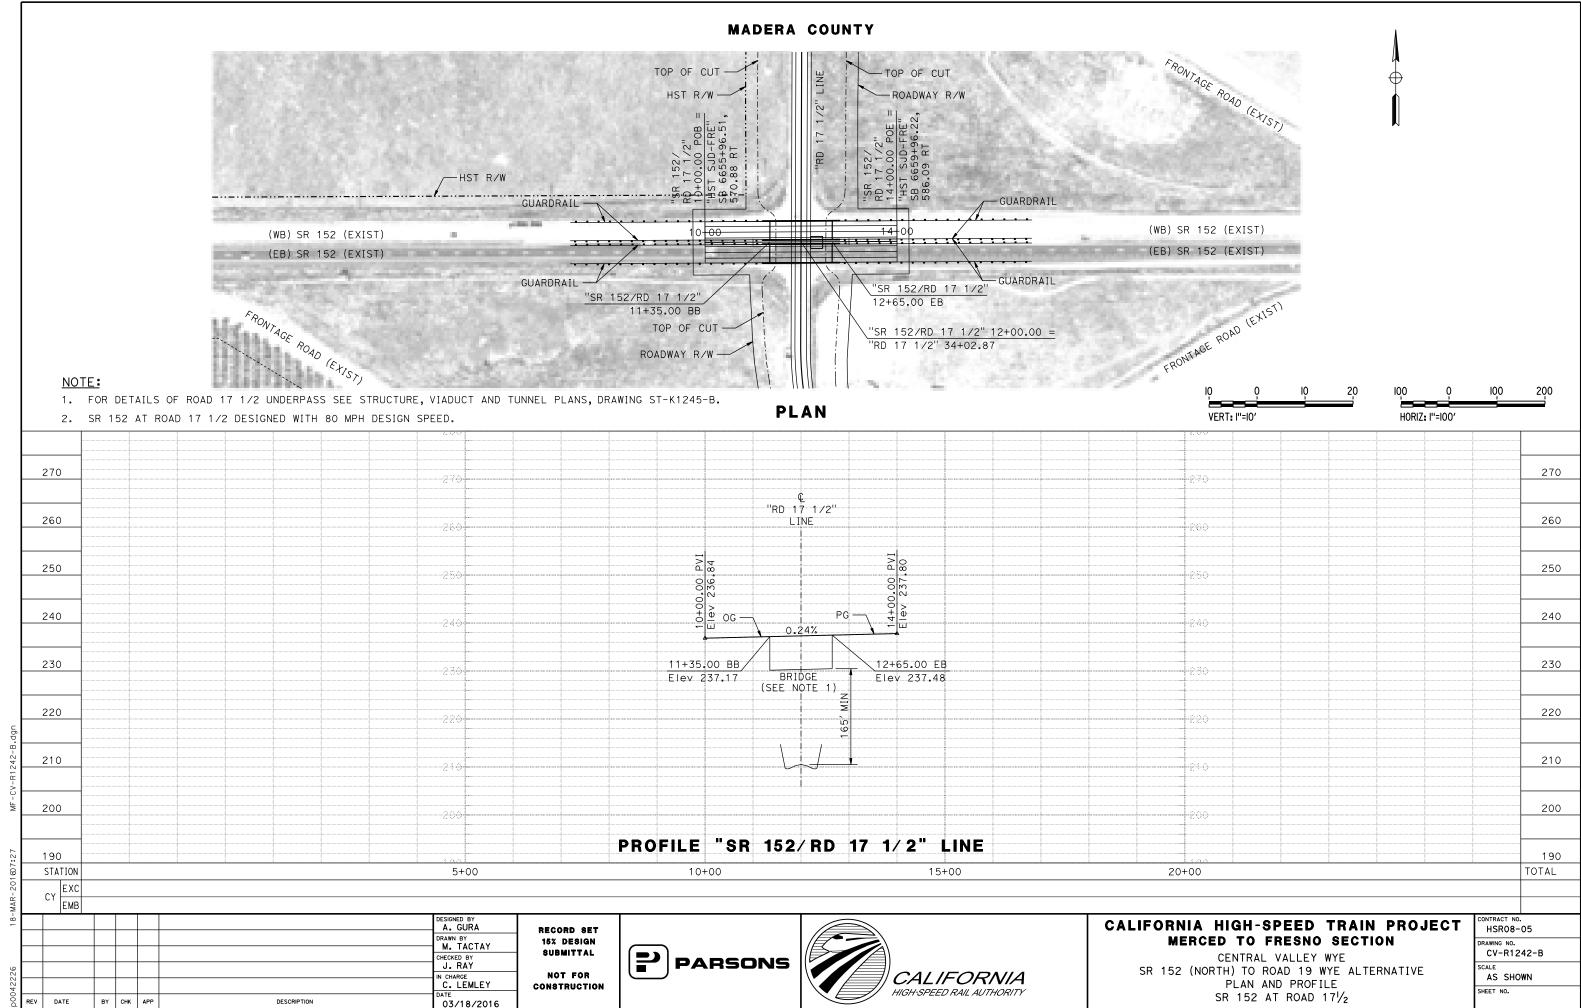











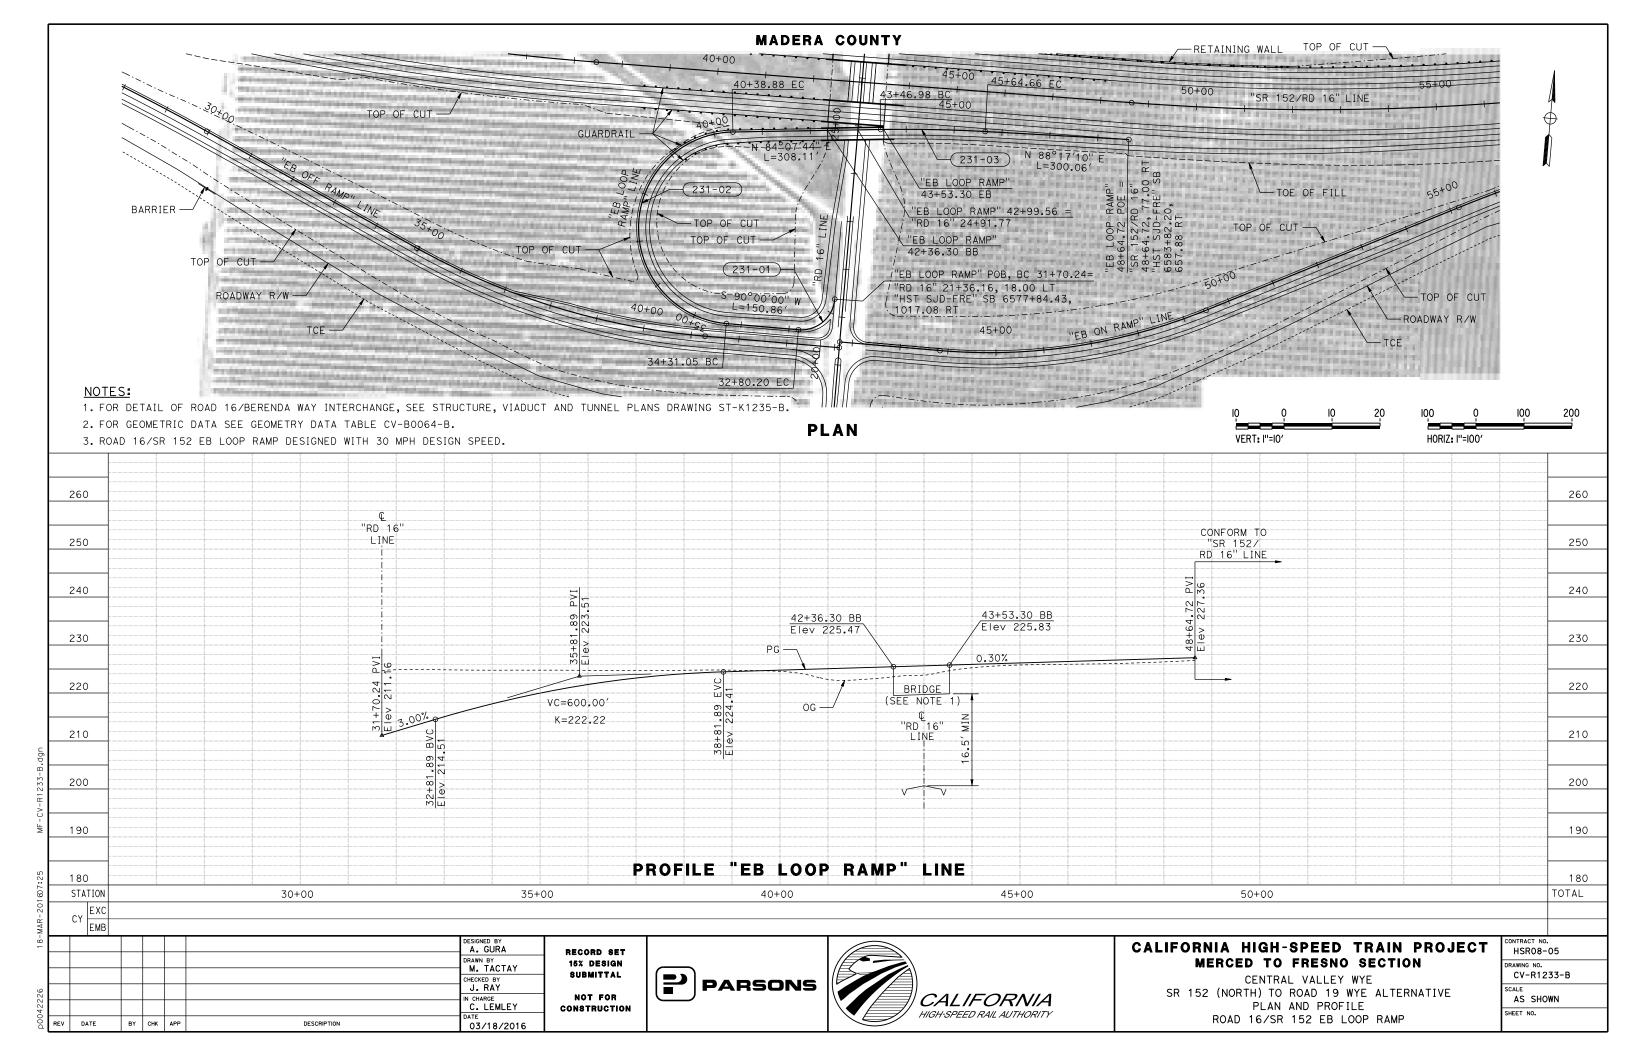


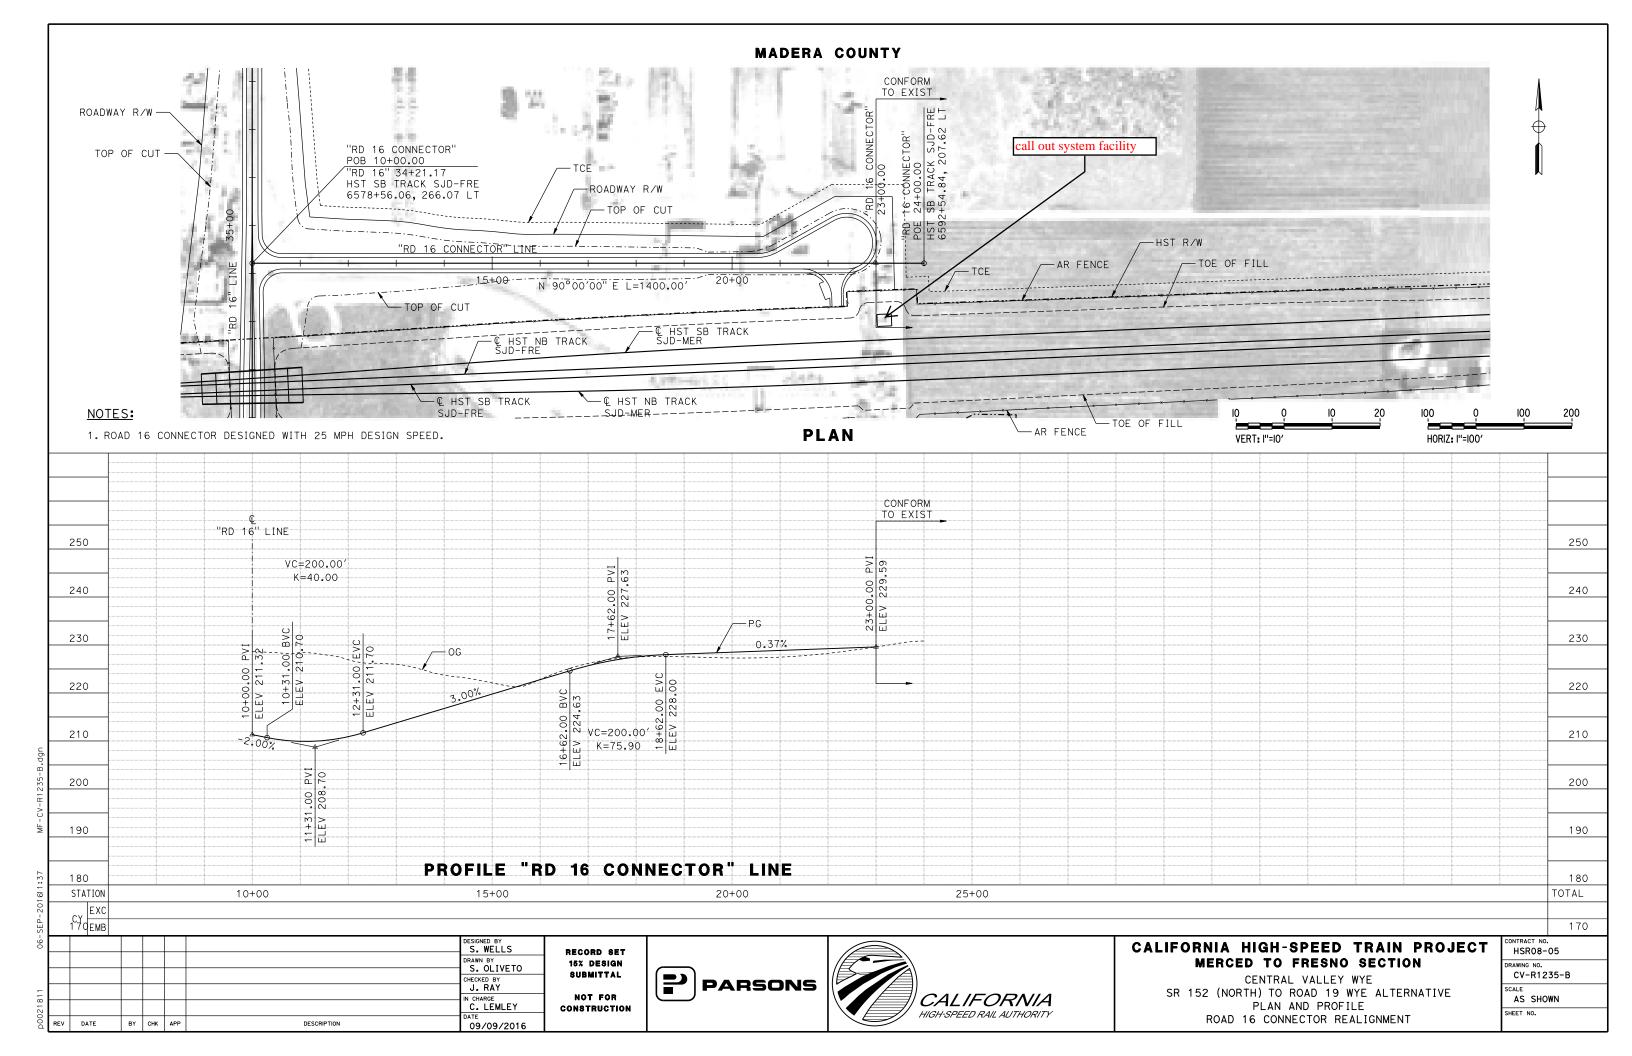


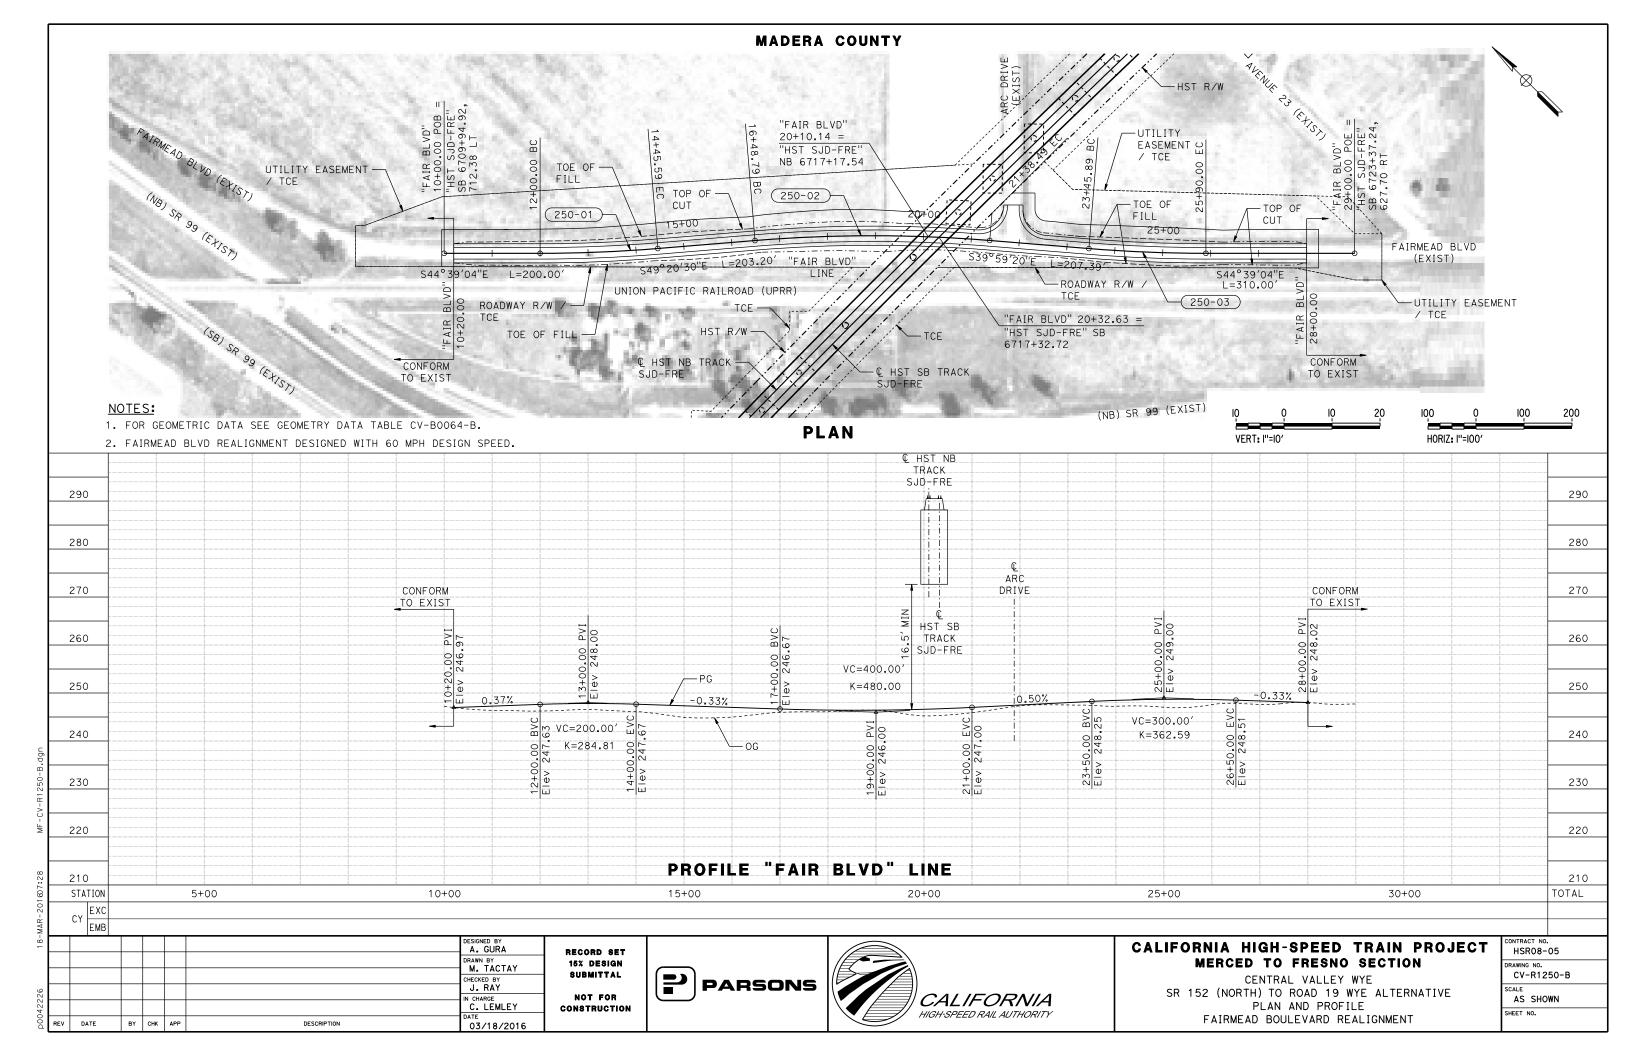


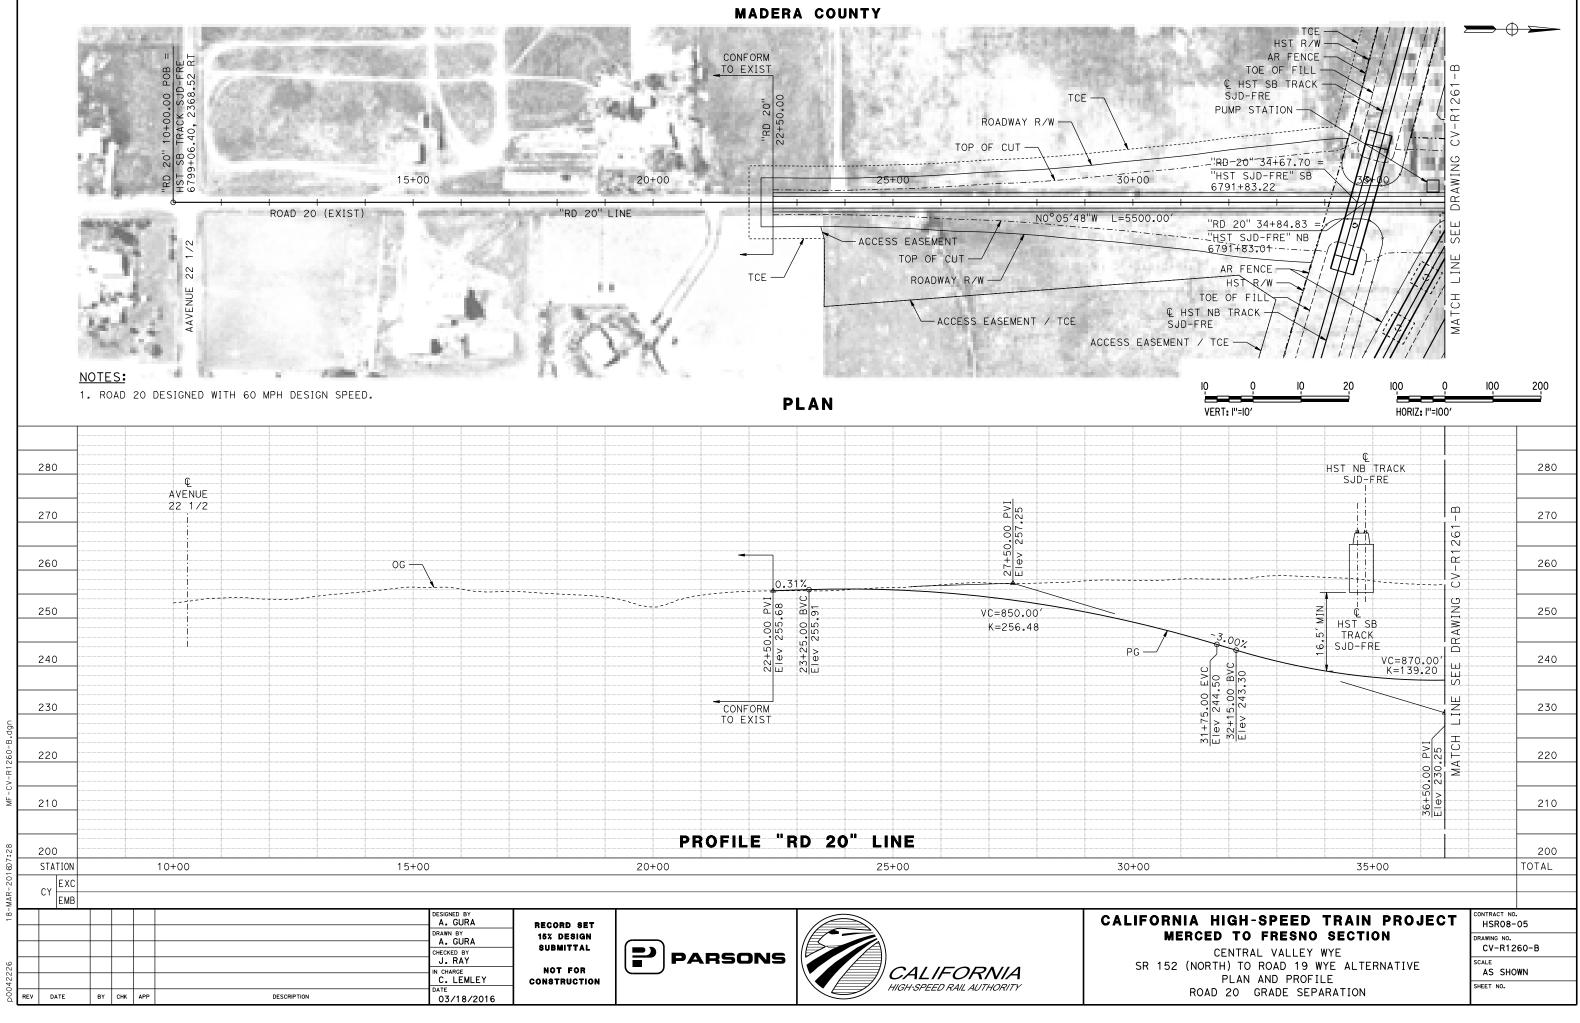


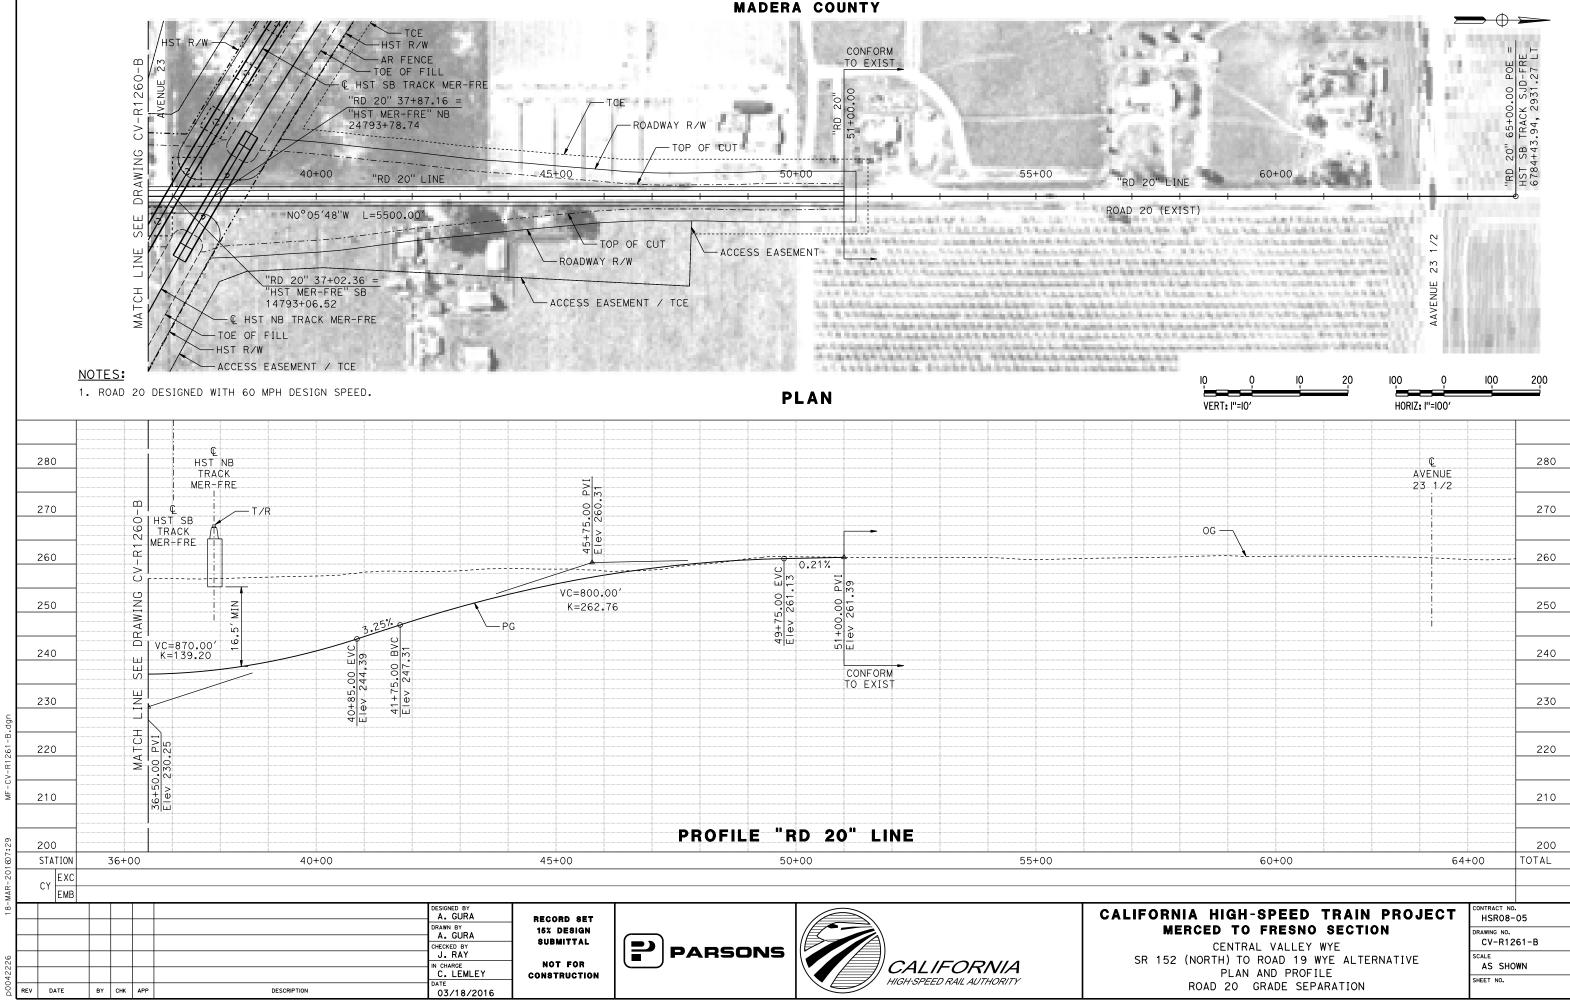


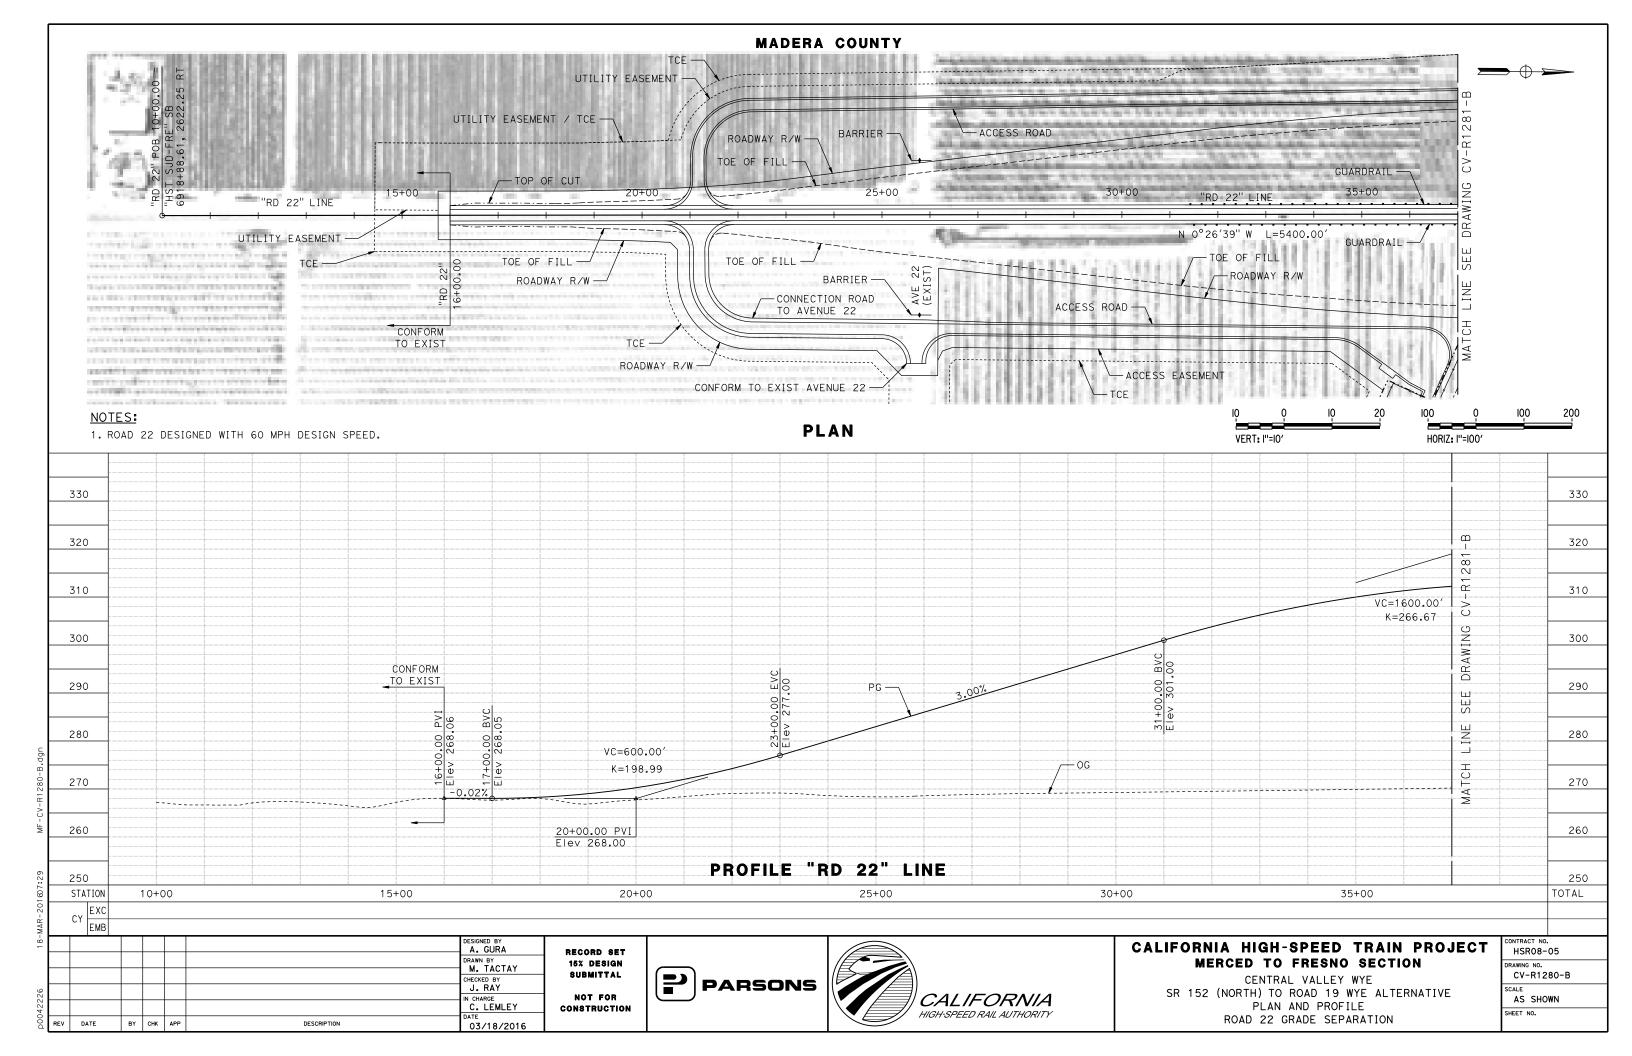


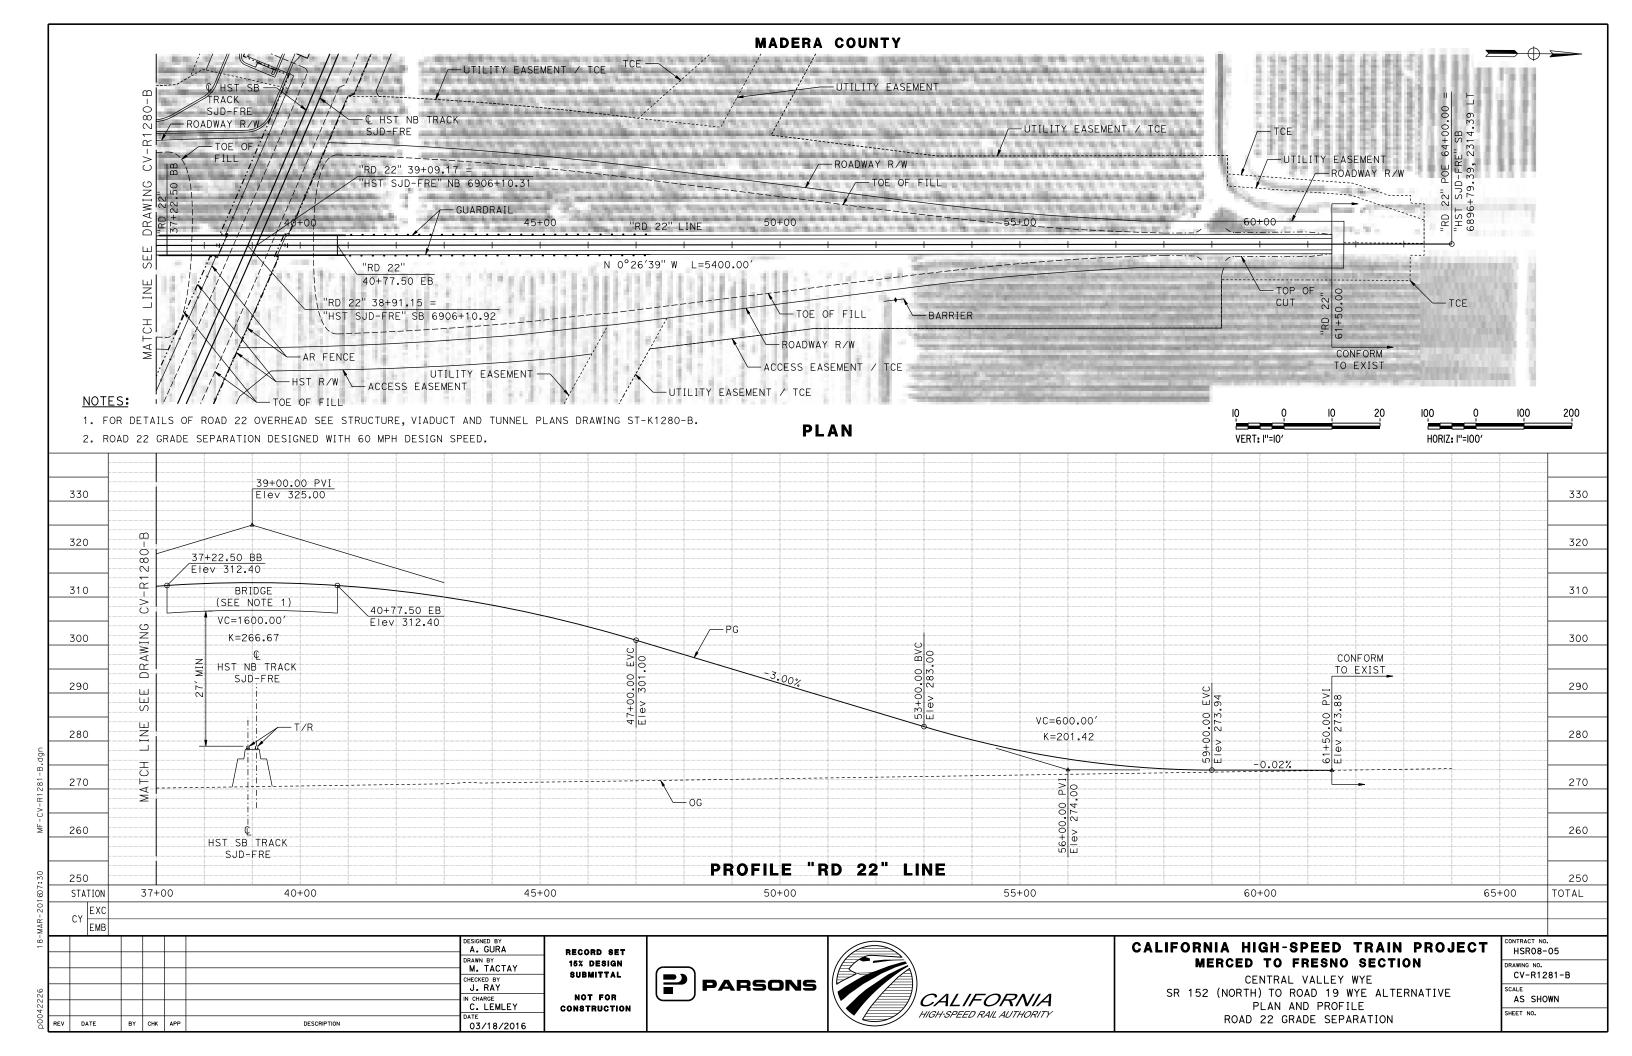


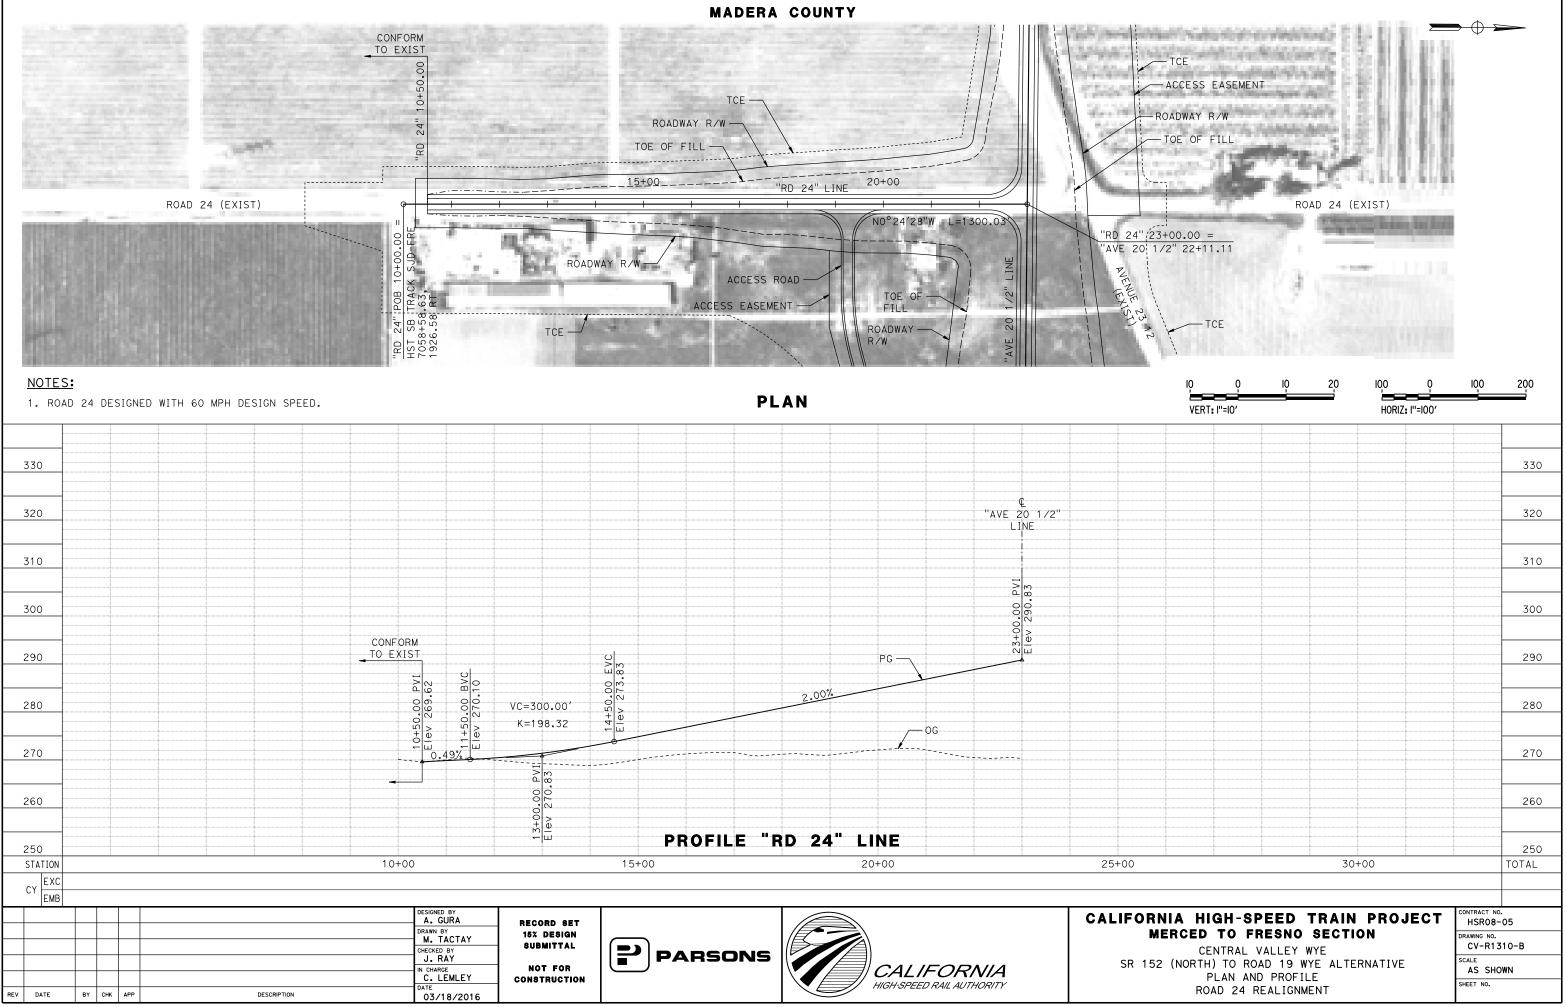

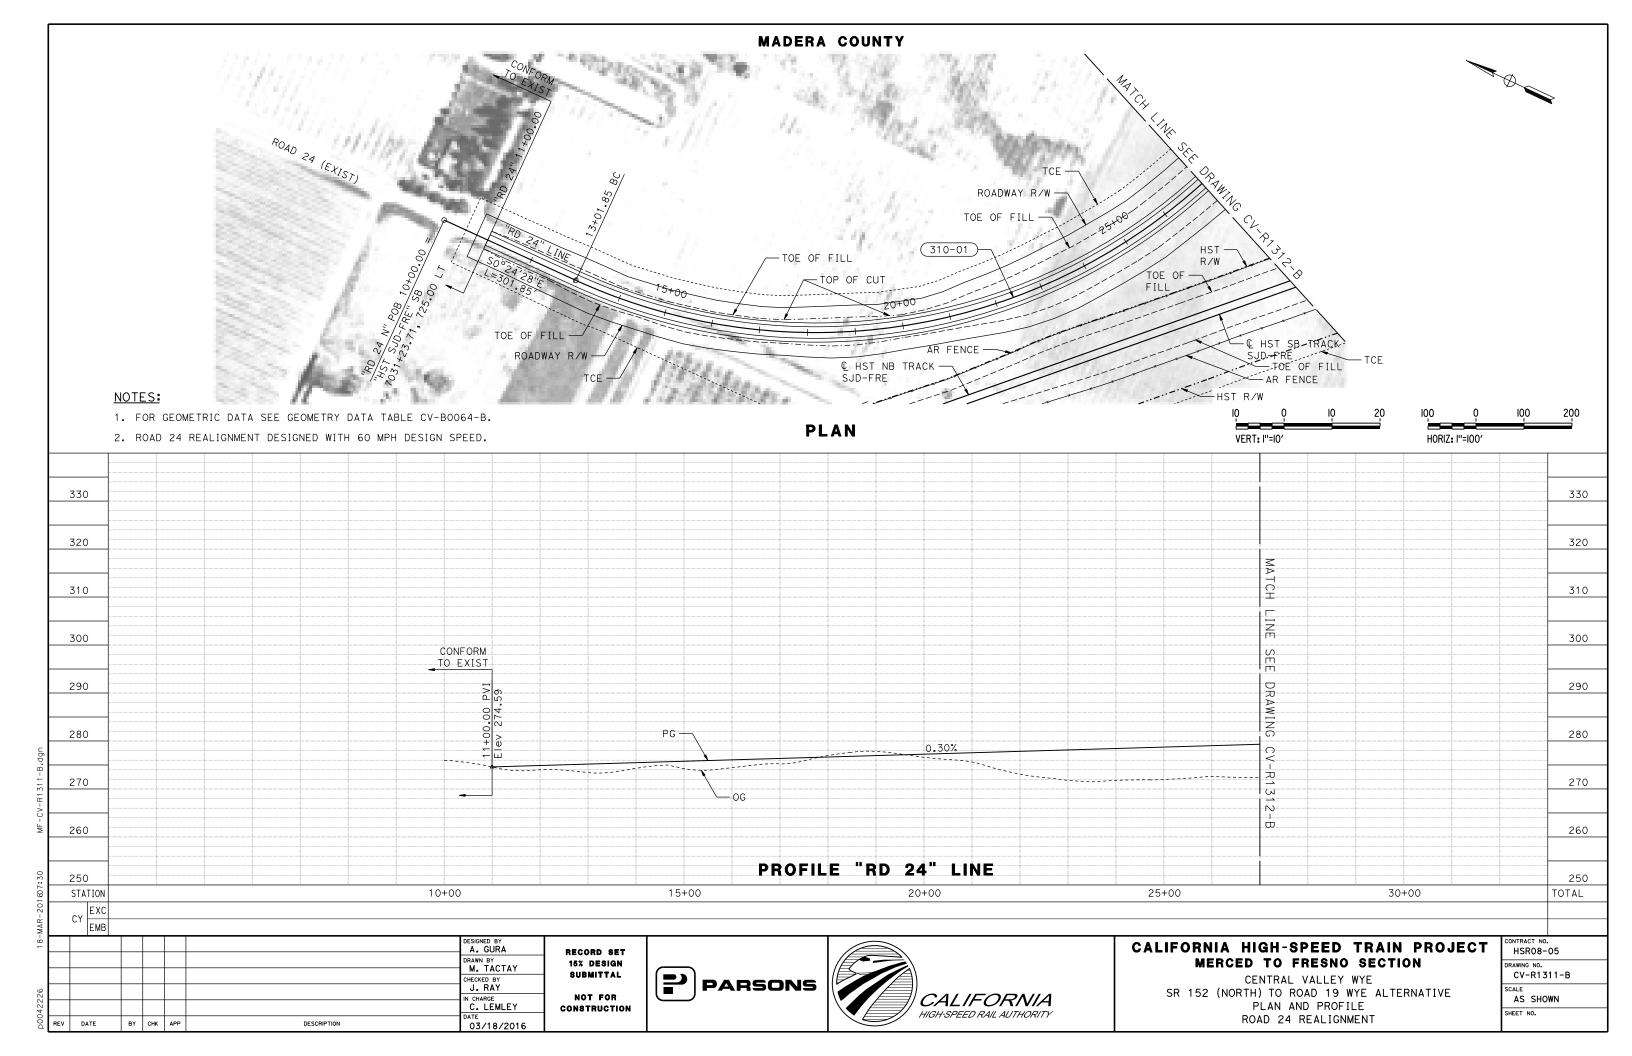


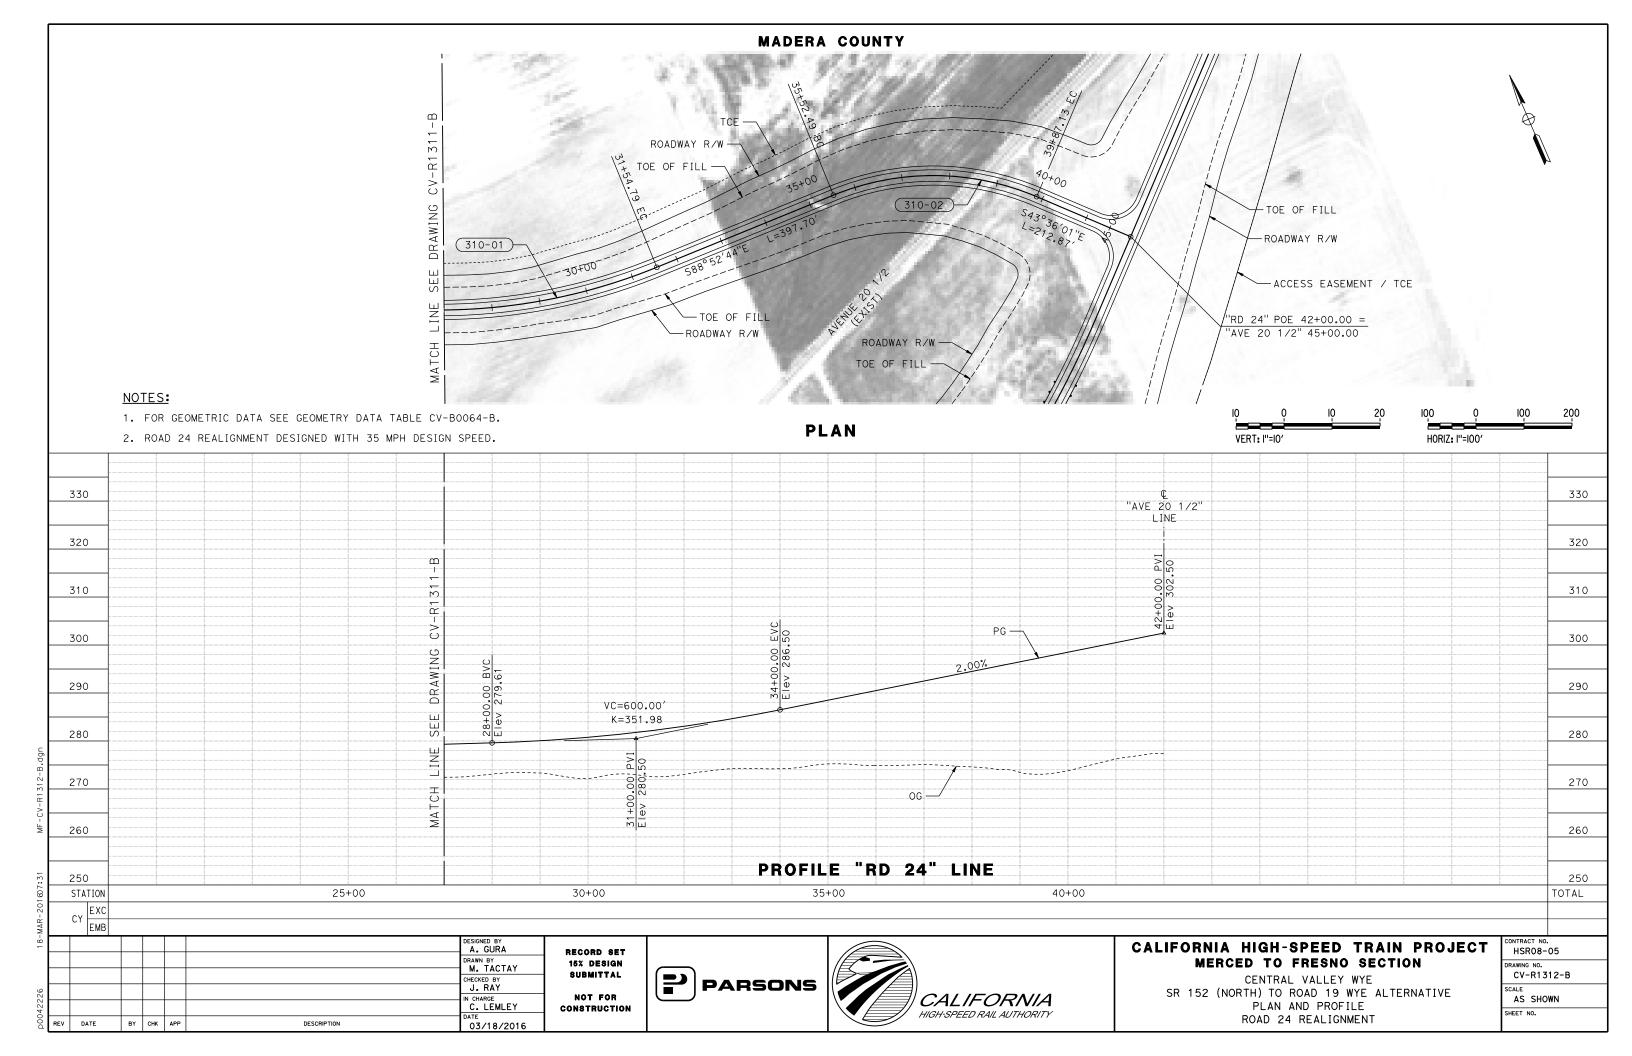

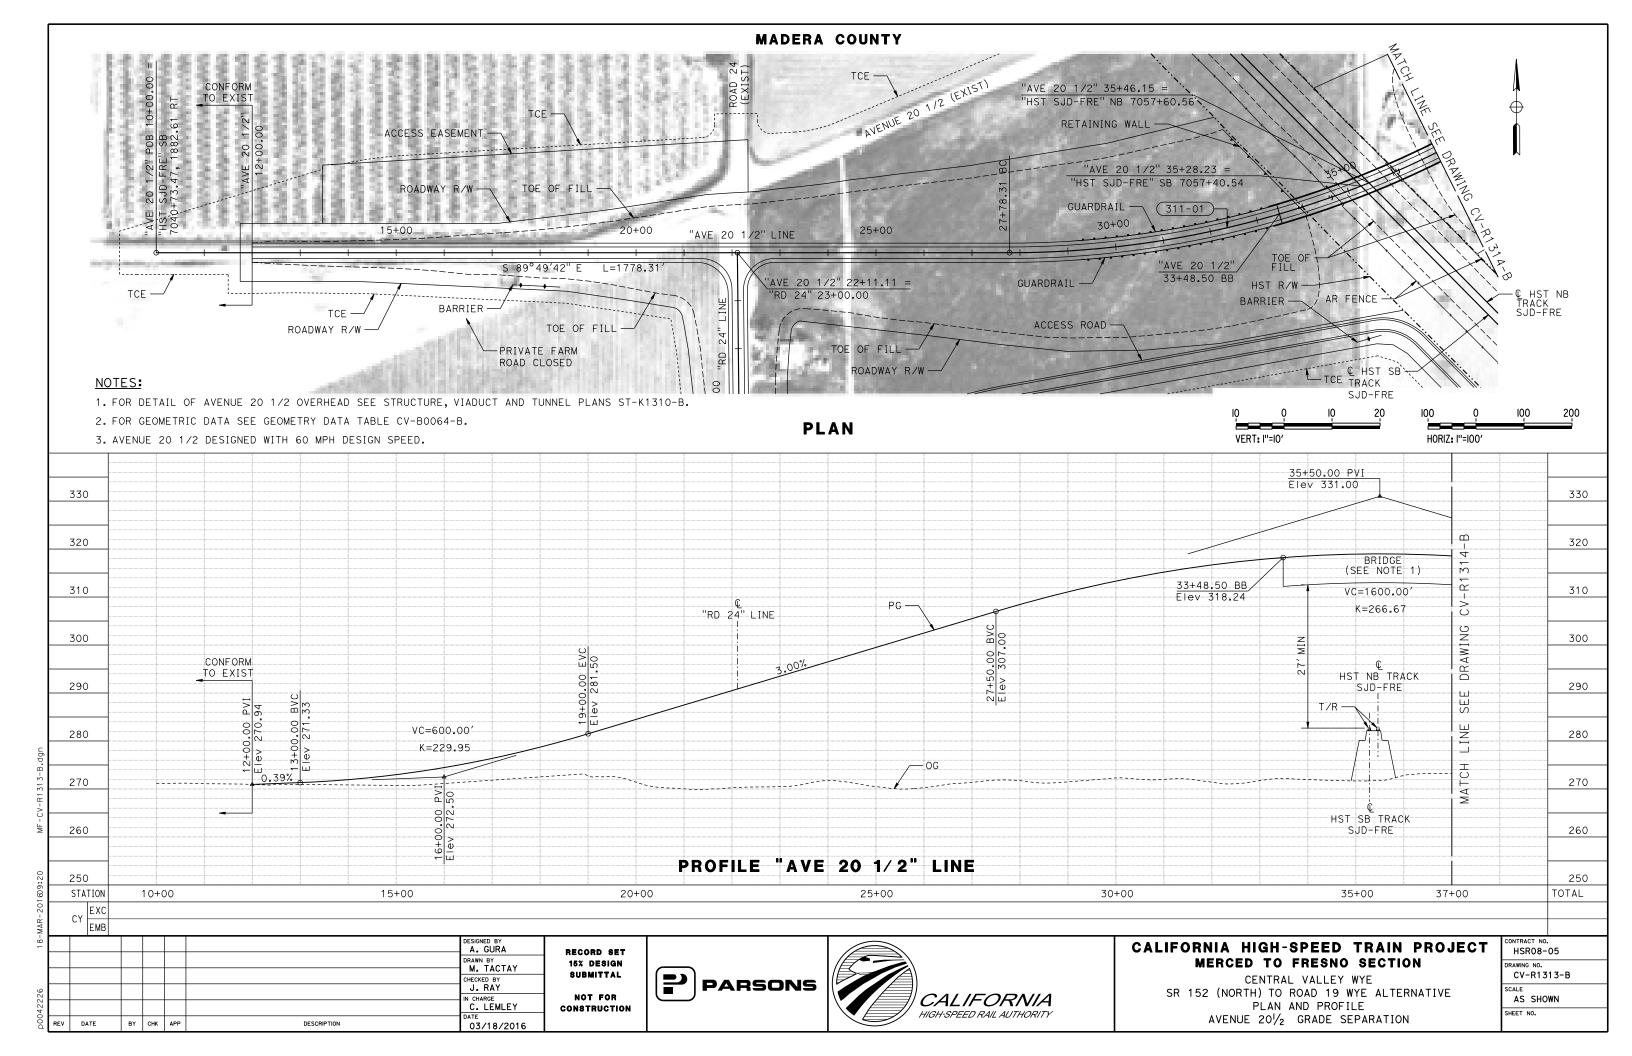


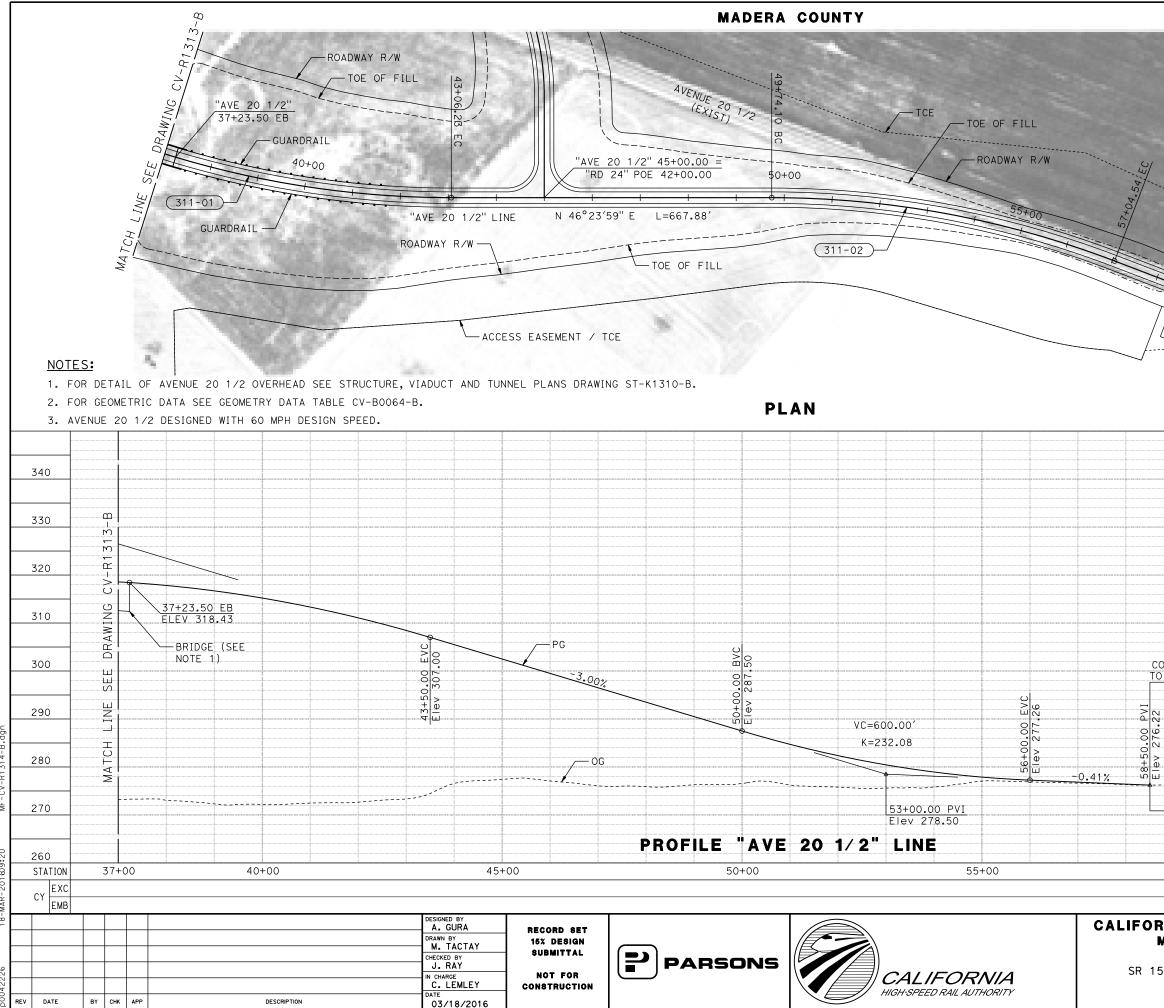

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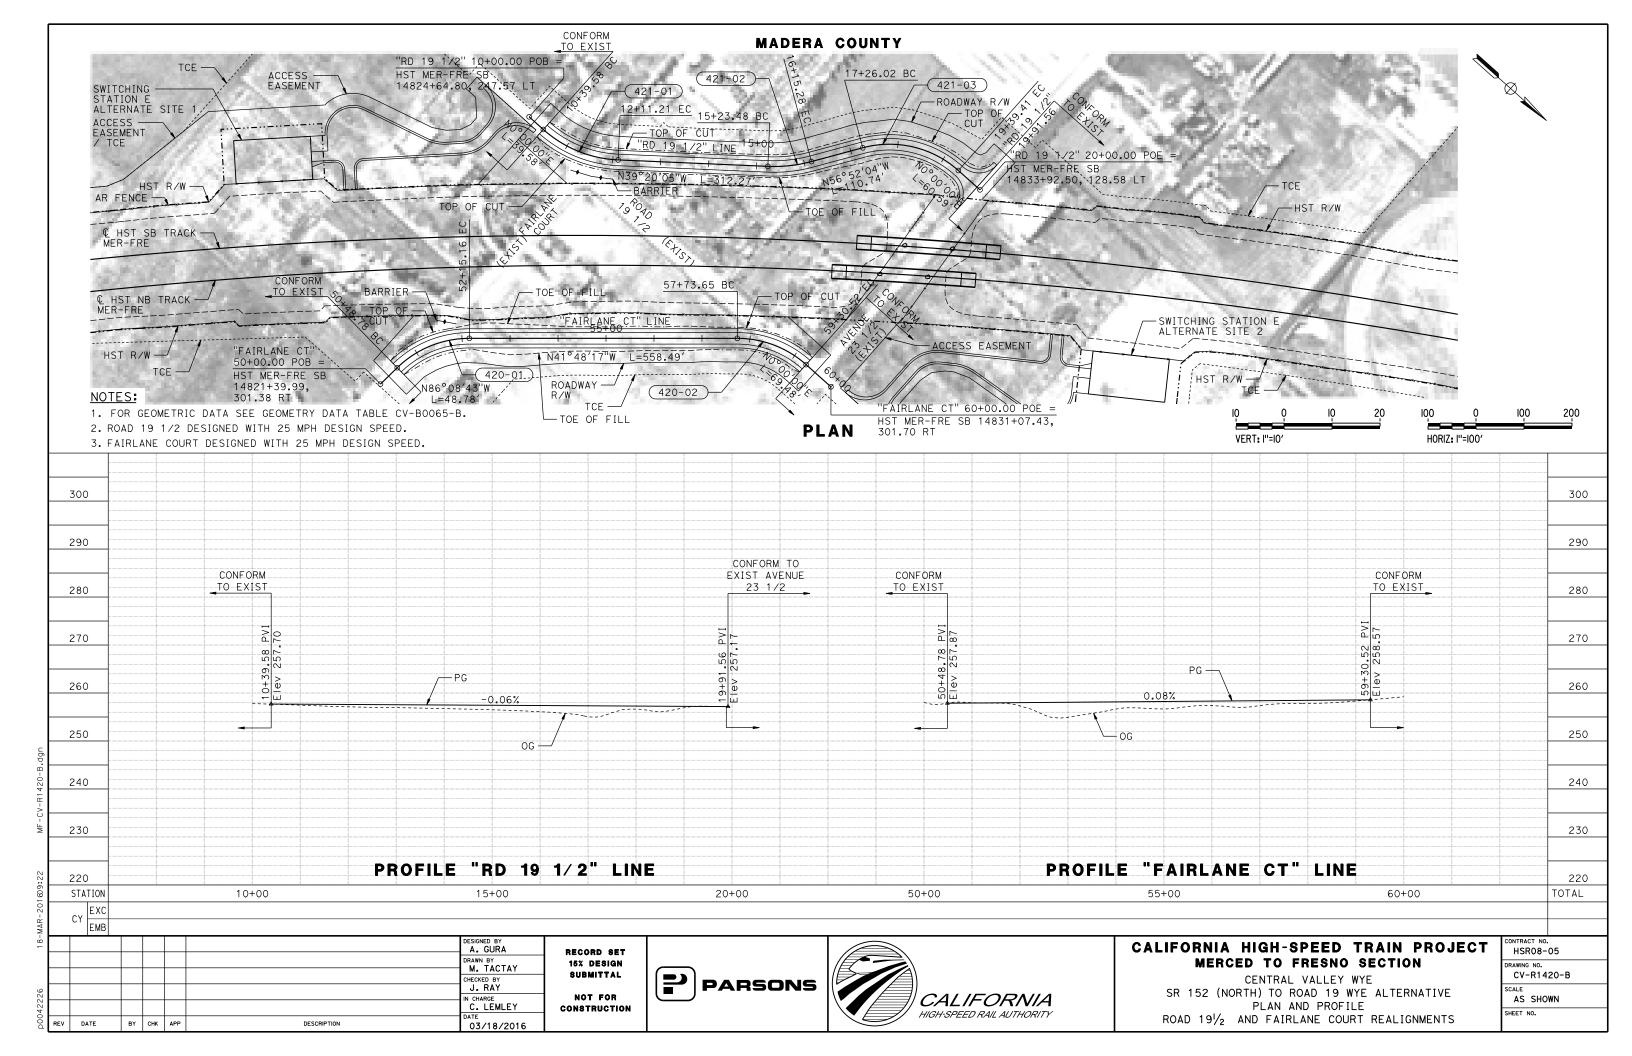


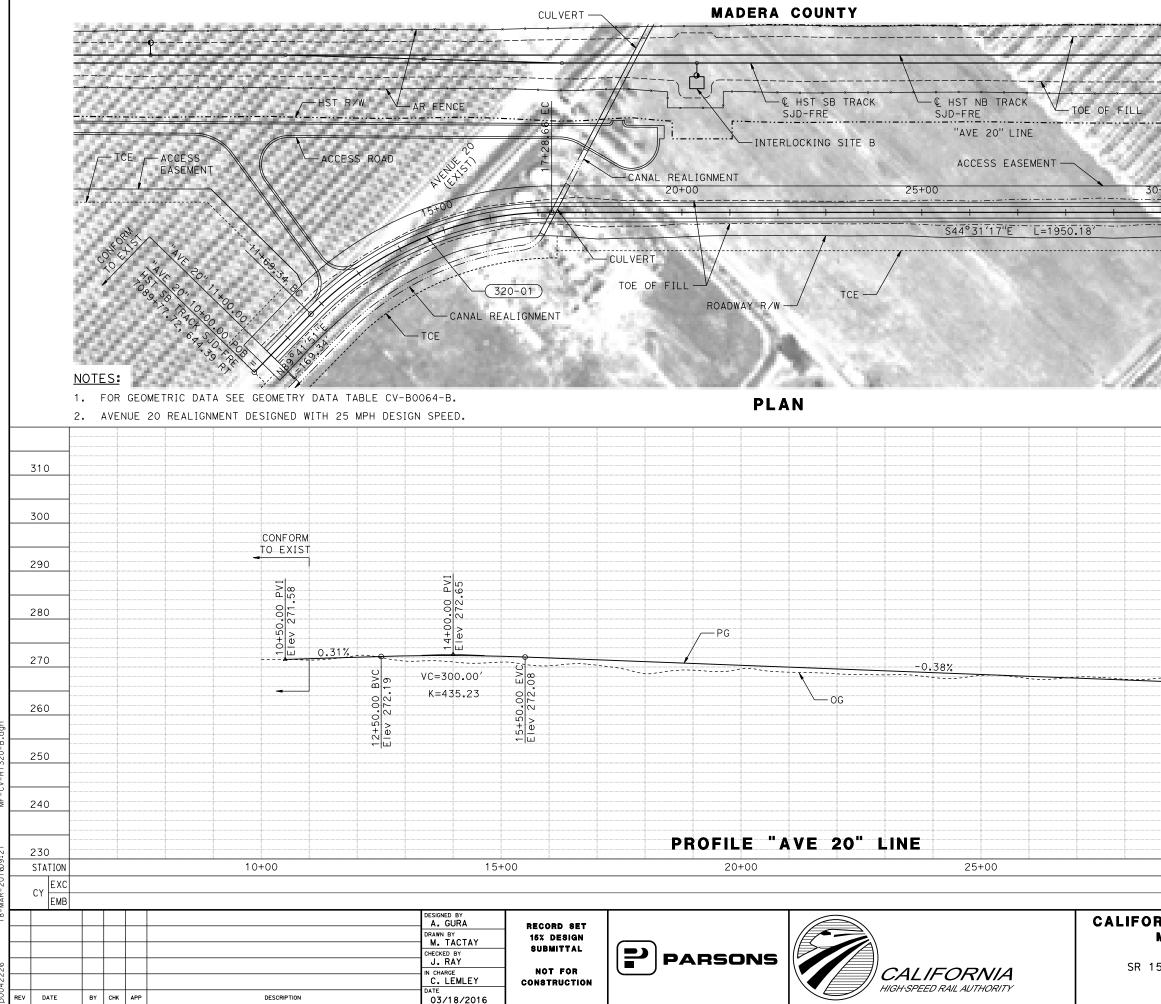
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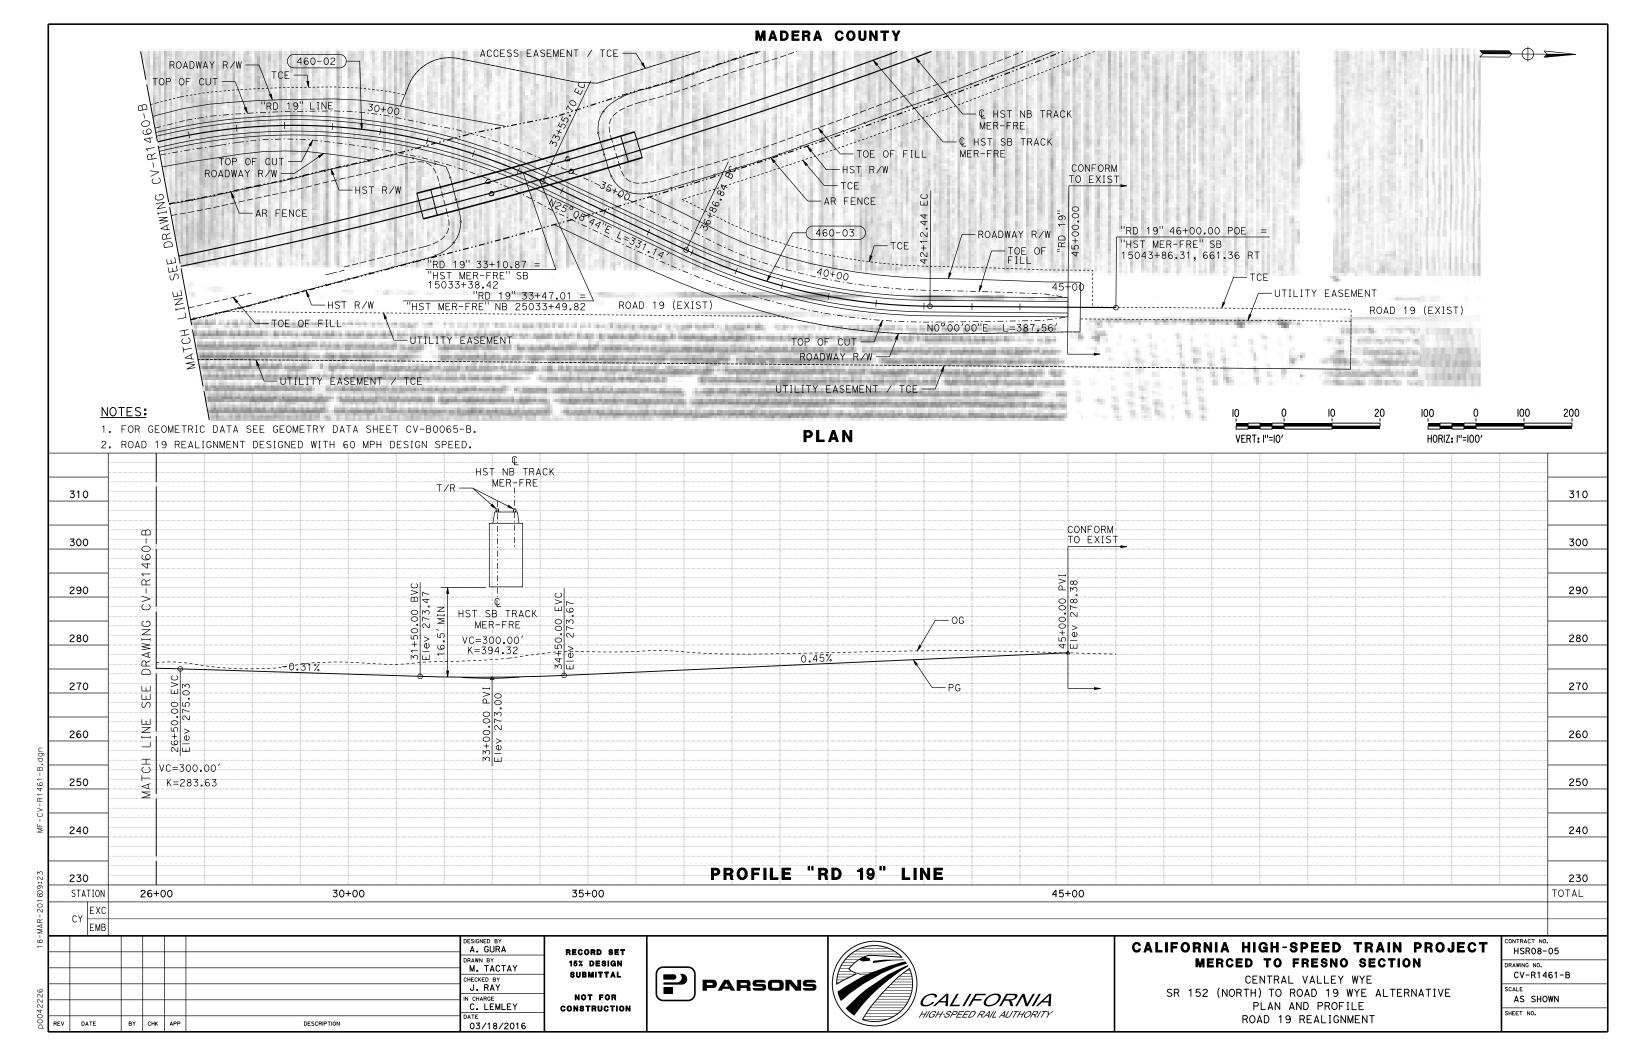



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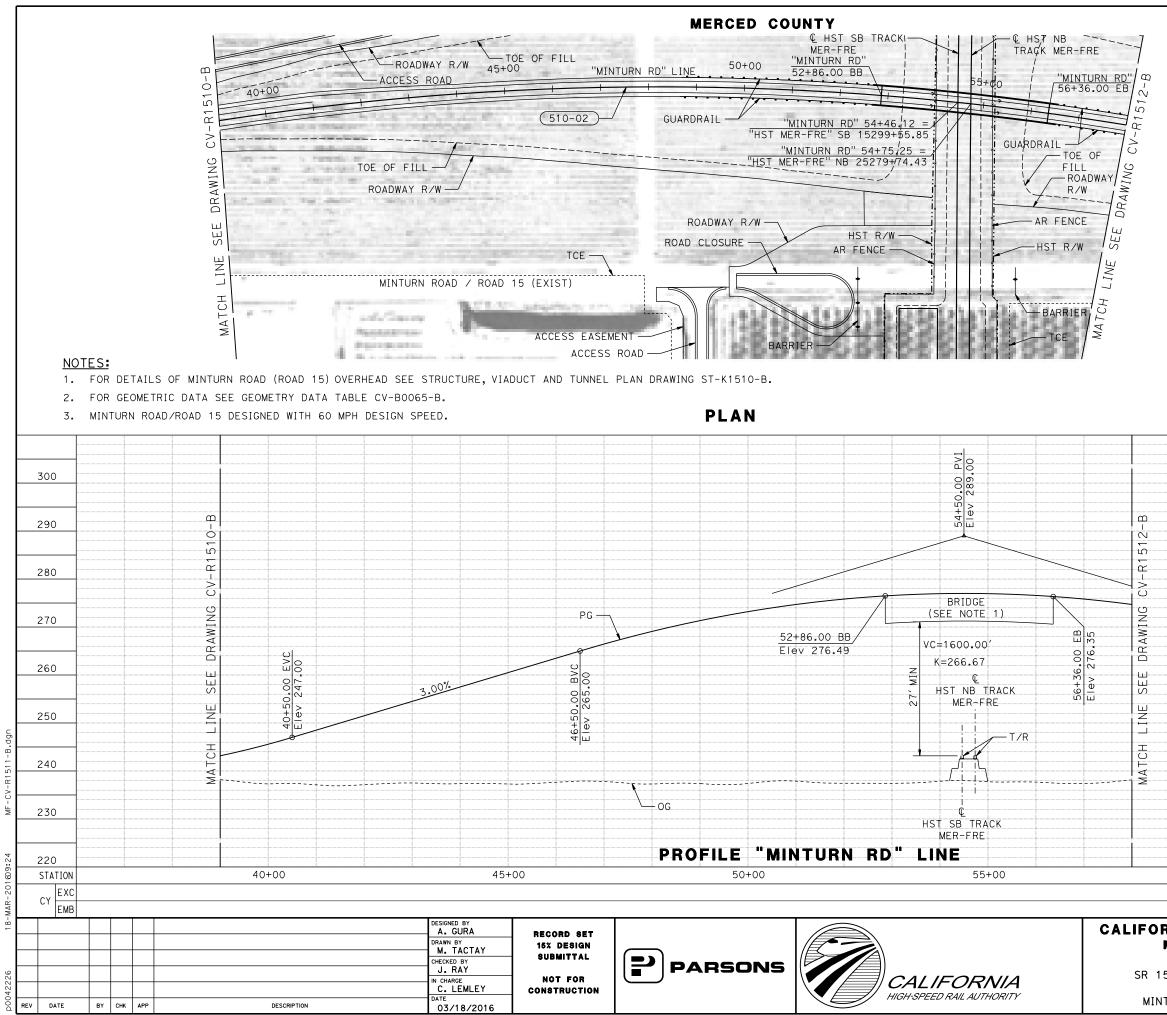
2. AVENUE 20 REALIGNMENT DESIGNED WITH 25 MPH DESIGN SPEED.

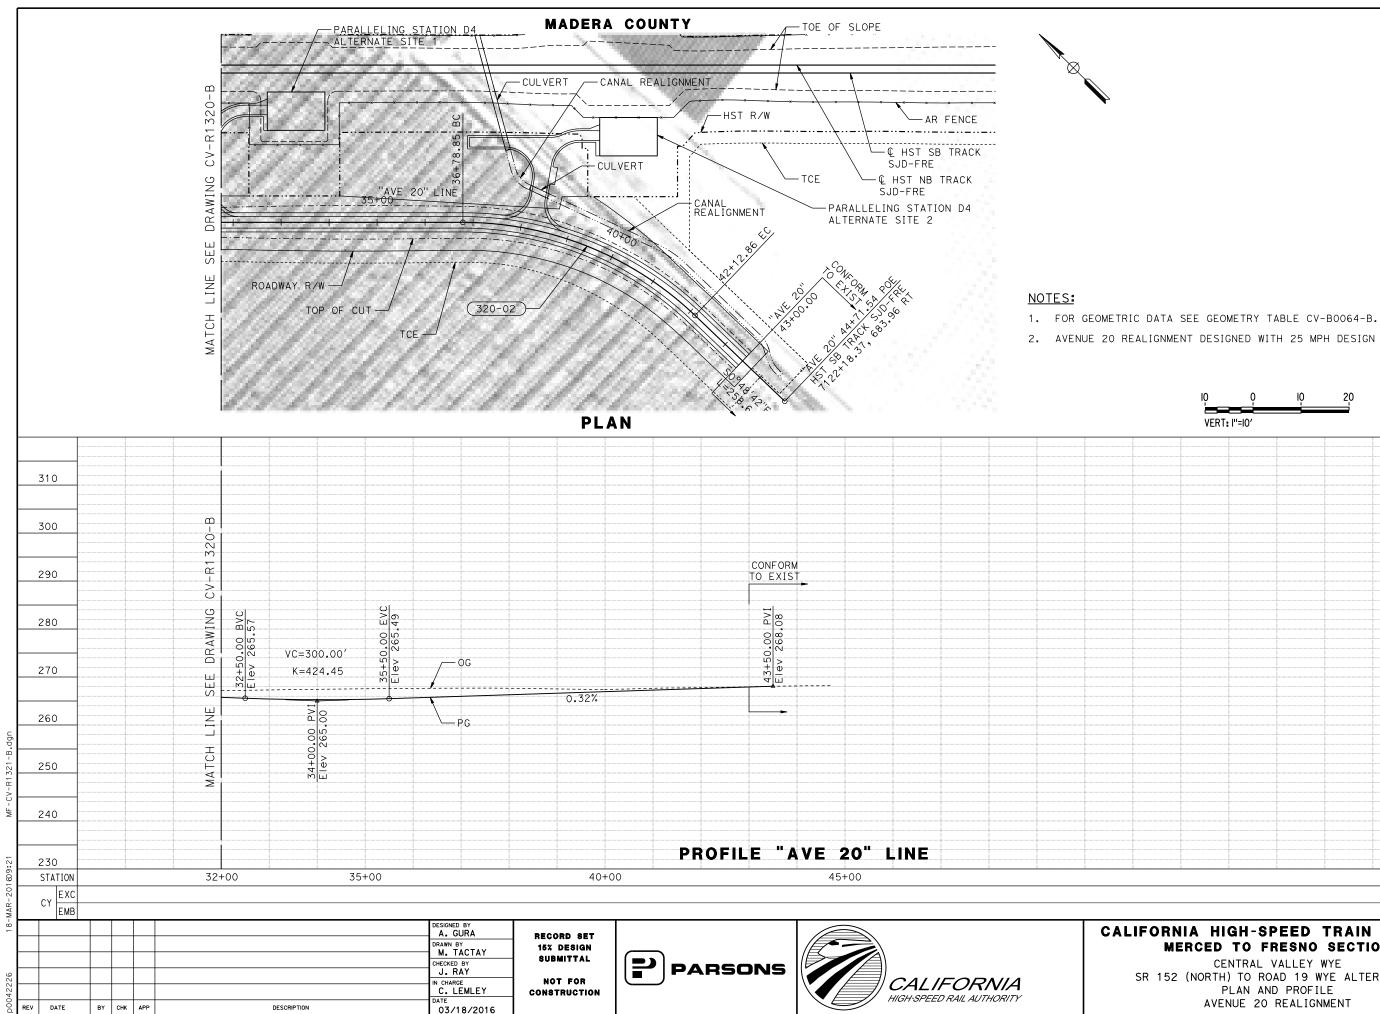







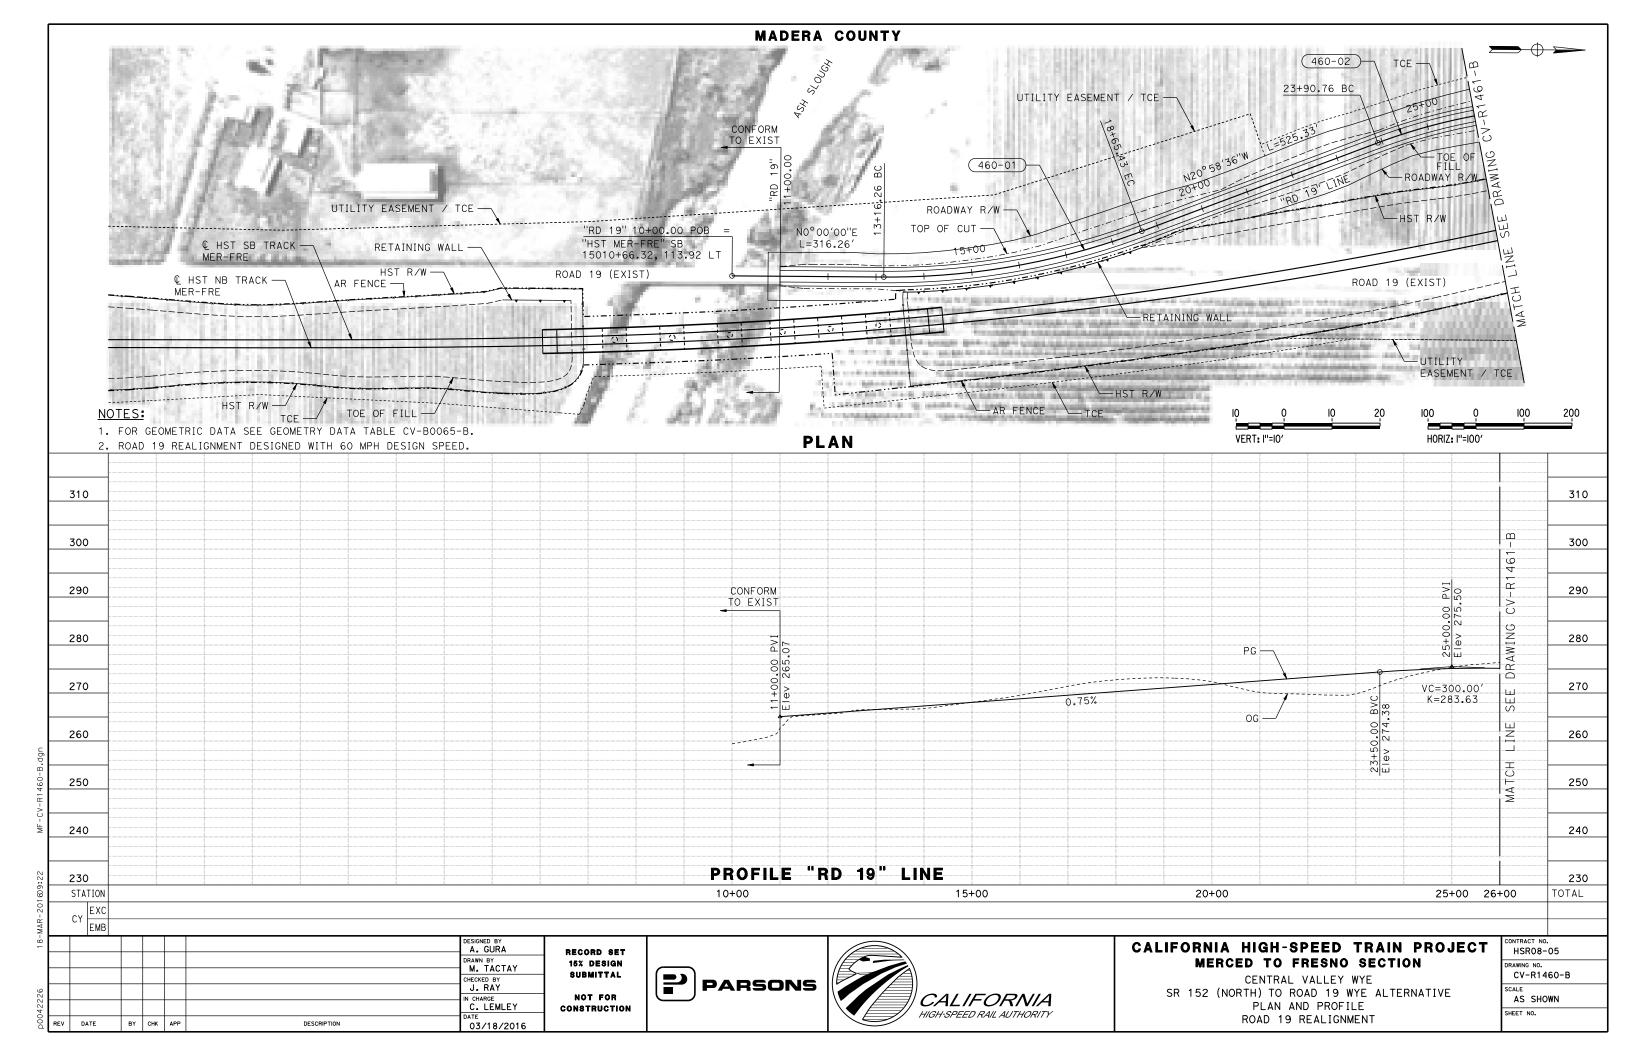

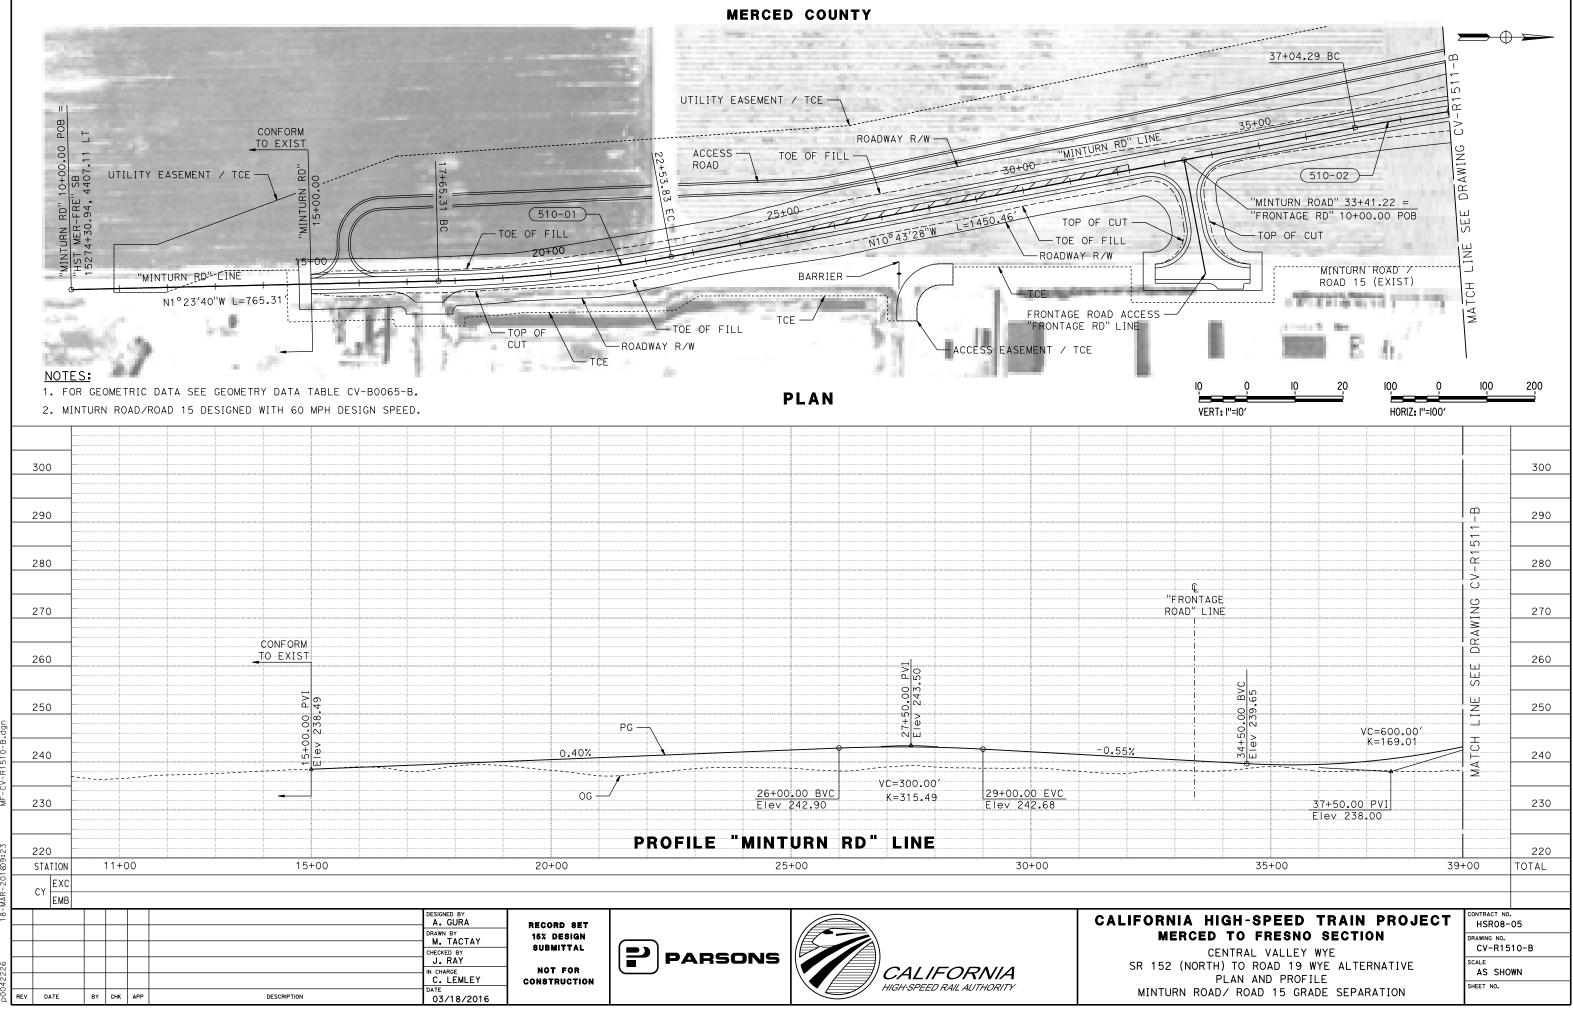

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REV DATE

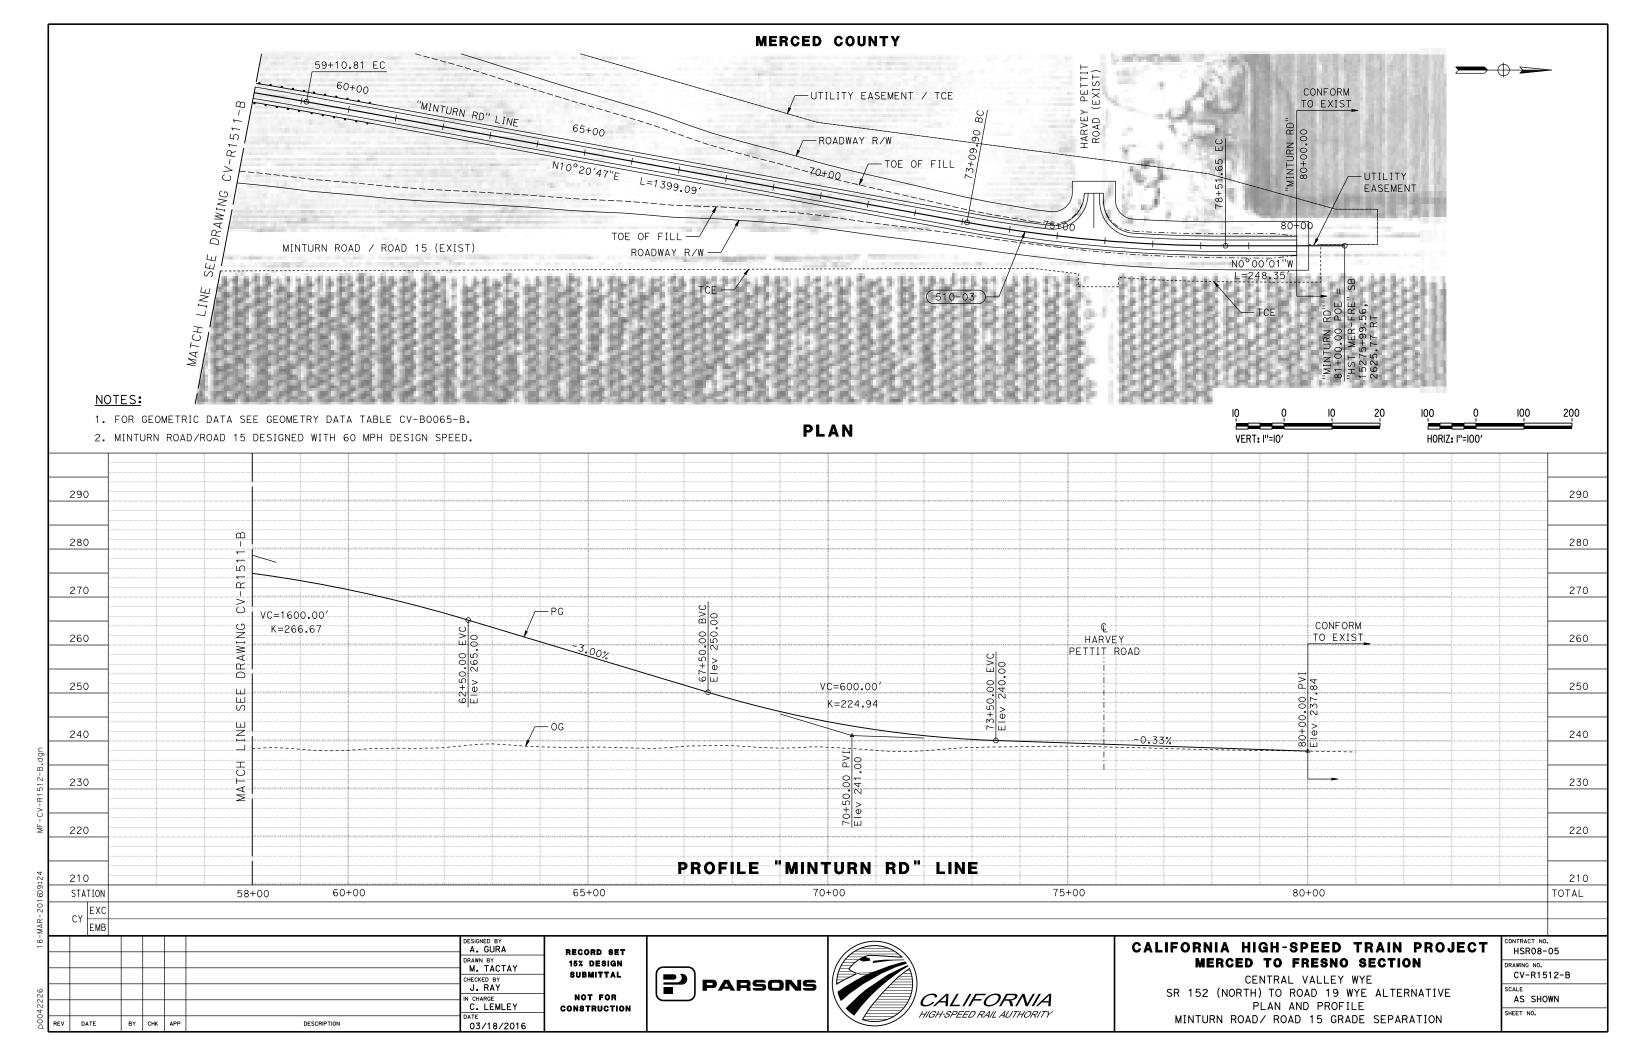BY CHK APP

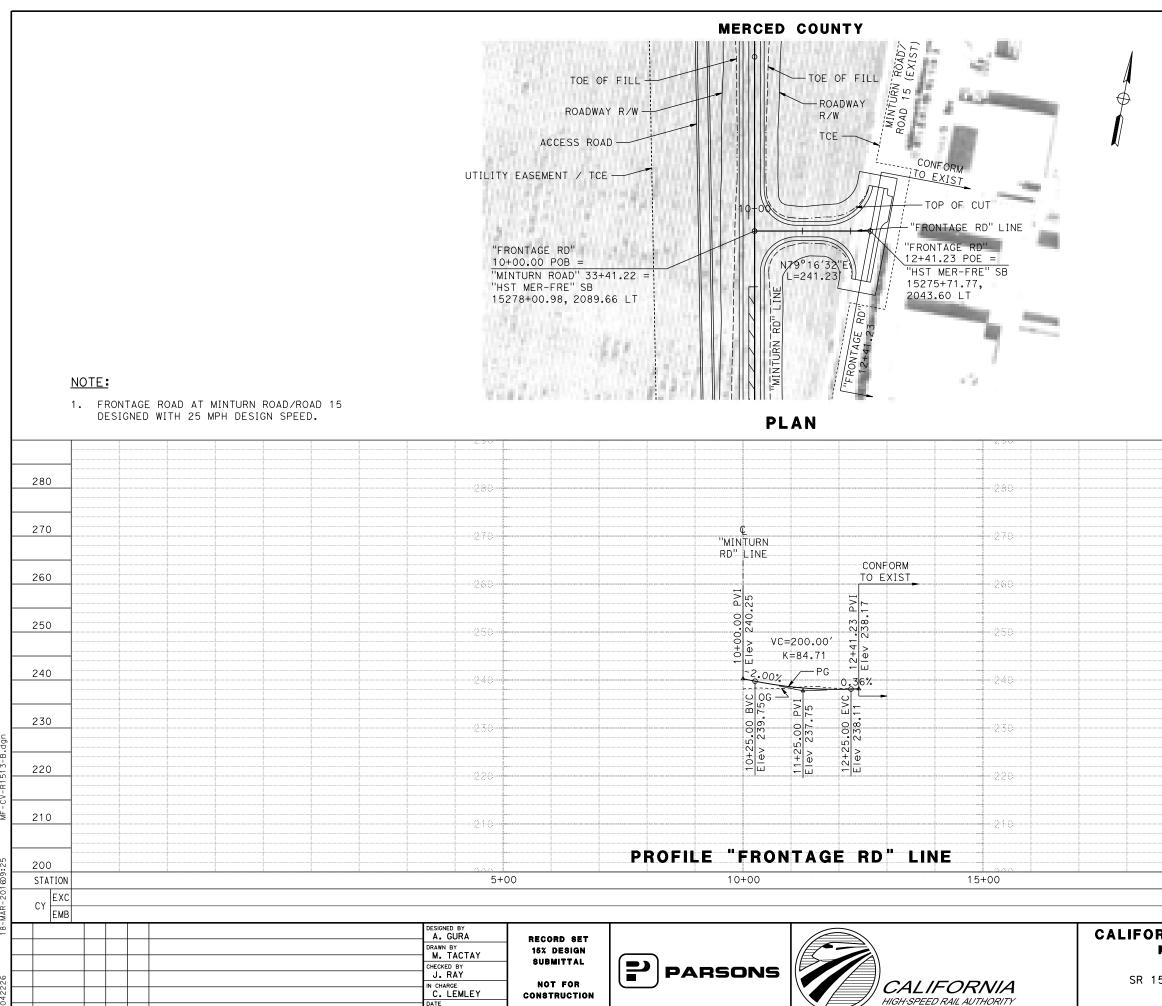DESCRIPTION

03/18/2016

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CONSTRUCTION STAGING

INDIANA ROAD DETOUR:

- 1. CONSTRUCT TEMPORARY ROAD ON NORTHWEST AND SOUTHWEST SIDE OF INDIANA ROAD.
- DURING CONSTRUCTION OF INDIANA RD GRADE SEPARATION, DIRECT TRAFFIC ONTO TEMPORARY 2. ROADWAY.
- RESTORE TRAFFIC TO INDIANA RD UPON 3. COMPLETION OF ROADWAY REALIGNMENT WORK.
- 4. REMOVE TEMPORARY ROADWAY.

SR 59 DETOUR:

1. FOR STAGE CONSTRUCTION DETAIL OF SR 59 SEE DRAWINGS CV-I4100-B TO CV-I4103-B.

ROAD 4 / LINCOLN ROAD DETOUR:

- DURING CONSTRUCTION OF RD 4 / LINCOLN RD 1. GRADE SEPARATION, DETOUR NB TRAFFIC TO EB AVE 21, NB KINGWOOD RD, WB SR 152, NB RD 5 THEN WB MADISON RD.
- 2. DETOUR SB TRAFFIC TO EB MADISON RD, SB RD 5, EB SR 152, SB KINGWOOD RD, THEN WB AVE 21.
- 3. RESTORE TRAFFIC TO RD 4 / LINCOLN RD UPON COMPLETION OF GRADE SEPARATION WORK.

ROAD 9 / HEMLOCK ROAD DETOUR:

1. FOR STAGE CONSTRUCTION DETAIL OF RD 9 / HEMLOCK RD SEE DRAWINGS CV-I4160-B TO CV-I4163-B.

ROAD 12 DETOUR:

- DURING CONSTRUCTION OF RD 12 GRADE 1. SEPARATION, DETOUR NB TRAFFIC TO EB AVE 22 1/2, NB RD 13, THEN WB AVE 24.
- DETOUR SB TRAFFIC TO EB AVE 24, SB RD 13, 2. THEN WB AVE 22 1/2.
- 3. RESTORE TRAFFIC TO RD 12 UPON COMPLETION OF GRADE SEPARATION WORK.

SR 233 / ROBERTSON BOULEVARD DETOUR:

FOR STAGE CONSTRUCTION DETAIL OF SR 233 / ROBERTSON BLVD INTERCHANGE SEE DRAWINGS CV-I4210-B TO CV-I4214-B.

ROAD 16 DETOUR:

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1. FOR STAGE CONSTRUCTION DETAIL OF RD 16 SEE DRAWINGS CV-14230-B TO CV-14233-B.

ROAD 17 1/2 DETOUR:

- 1. DURING CONSTRUCTION OF RD 17 1/2 GRADE SEPARATION, DETOUR SE TRAFFIC TO WE AVE 23 1/2, SE RD 17, EE SR 152, SE SR 99, WE AVE 21 1/2, THEN NE RD 19.
- 2. DETOUR NB TRAFFIC TO SB RD 19, EB AVE 21 1/2, NB SR 99, WB SR 152, NB RD 17, THEN EB AVE 23 1/2.
- 3. CONSTRUCT TEMPORARY FOUR-LANE ROADWAY NORTH OF THE EXISTING SR 152.
- SHIFT SR 152 TRAFFIC ONTO TEMPORARY 4. ROAD AND CONSTRUCT UNDERCROSSING.
- RESTORE TRAFFIC TO SR 152 AND RD 17 1/2 5. UPON COMPLETION OF GRADE SEPARATION.
- 6. REMOVE TEMPORARY ROADWAY.

ROAD 20 DETOUR:

- 1. DURING CONSTRUCTION OF RD 20 GRADE SEPARATION, DETOUR NB TRAFFIC TO WB AVE 22 1/2, THEN NB RD 19 1/2, THEN TO EB AVE 23 1/2.
- 2. DETOUR SB TRAFFIC TO WB AVE 23 1/2, THEN SB RD 19 1/2, THEN EB AVE 22 1/2.
- 3. RESTORE TRAFFIC TO RD 20 UPON COMPLETION OF GRADE SEPARATION WORK.

ROAD 22 DETOUR:

- 1. DURING CONSTRUCTION OF RD 22 GRADE SEPARATION, DETOUR NB TRAFFIC TO NB FAIRMEAD BLVD, EB AVE 22, NB RD 20, THEN EB AVE 24.
- 2. DETOUR SB TRAFFIC TO WB AVE 24, SB RD 20, WB AVE 22, THEN SB FAIRMEAD BLVD.
- BUILD TEMPORARY ROADWAY ON SOUTH SIDE OF 3. AVE 22, CONNECTING AVE 22 TRAFFIC TO ROAD 22.
- 4. RESTORE TRAFFIC TO RD 22 AND AVE 22 UPON COMPLETION OF GRADE SEPARATION WORK.
- 5. REMOVE TEMPORARY ROADWAY.

ROAD 24 AND AVE 20 1/2 DETOUR:

- CONSTRUCT TEMPORARY ROAD ON WEST SIDE OF 1. RD 24 AND SOUTH SIDE OF AVE 20 1/2
- DURING CONSTRUCTION OF RD 24 AND AVE 20 1/2 2. REALIGNMENT, DIRECT TRAFFIC ONTO TEMPORARY ROADWAYS.
- RESTORE TRAFFIC TO RD 24 AND AVE 20 1/2 3. UPON COMPLETION OF ROADWAY REALIGNMENT WORK.
- 4. REMOVE TEMPORARY ROADWAY.

CALIFORNIA HIGH-SPEED TRAIN PROJECT A. GURA RECORD SET 15% DESIGN **MERCED TO FRESNO SECTION** M. TACTAY SUBMITTAL CENTRAL VALLEY WYE CHECKED BY PARSONS J. RAY SR 152 (NORTH) TO ROAD 19 WYE ALTERNATIVE NOT FOR CALIFORNIA C. LEMLEY STAGE CONSTRUCTION PLAN CONSTRUCTION HIGH-SPEED RAIL AUTHORITY GENERAL NOTES REV DATE BY CHK APP DESCRIPTION 10/30/2015

CUT-AND-COVER TUNNEL AT SR 99 STAGING:

1. FOR STAGE CONSTRUCTION DETAIL OF SR 99 CUT-AND-COVER TUNNEL SEE DRAWINGS CV-14520-B TO CV-14523-B.

CUT-AND-COVER TUNNEL AT SANDY MUSH STAGING:


1. MAINTAIN ONE LANE IN EACH DIRECTION AT ALL TIMES DURING CONSTRUCTION OF CUT-AND-COVER TUNNEL.

NTRACT N HSR08-05


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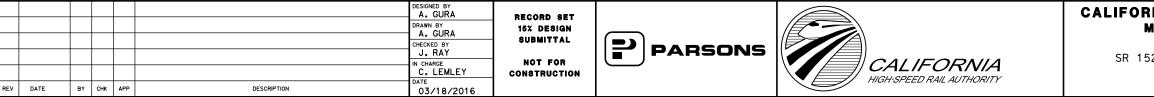
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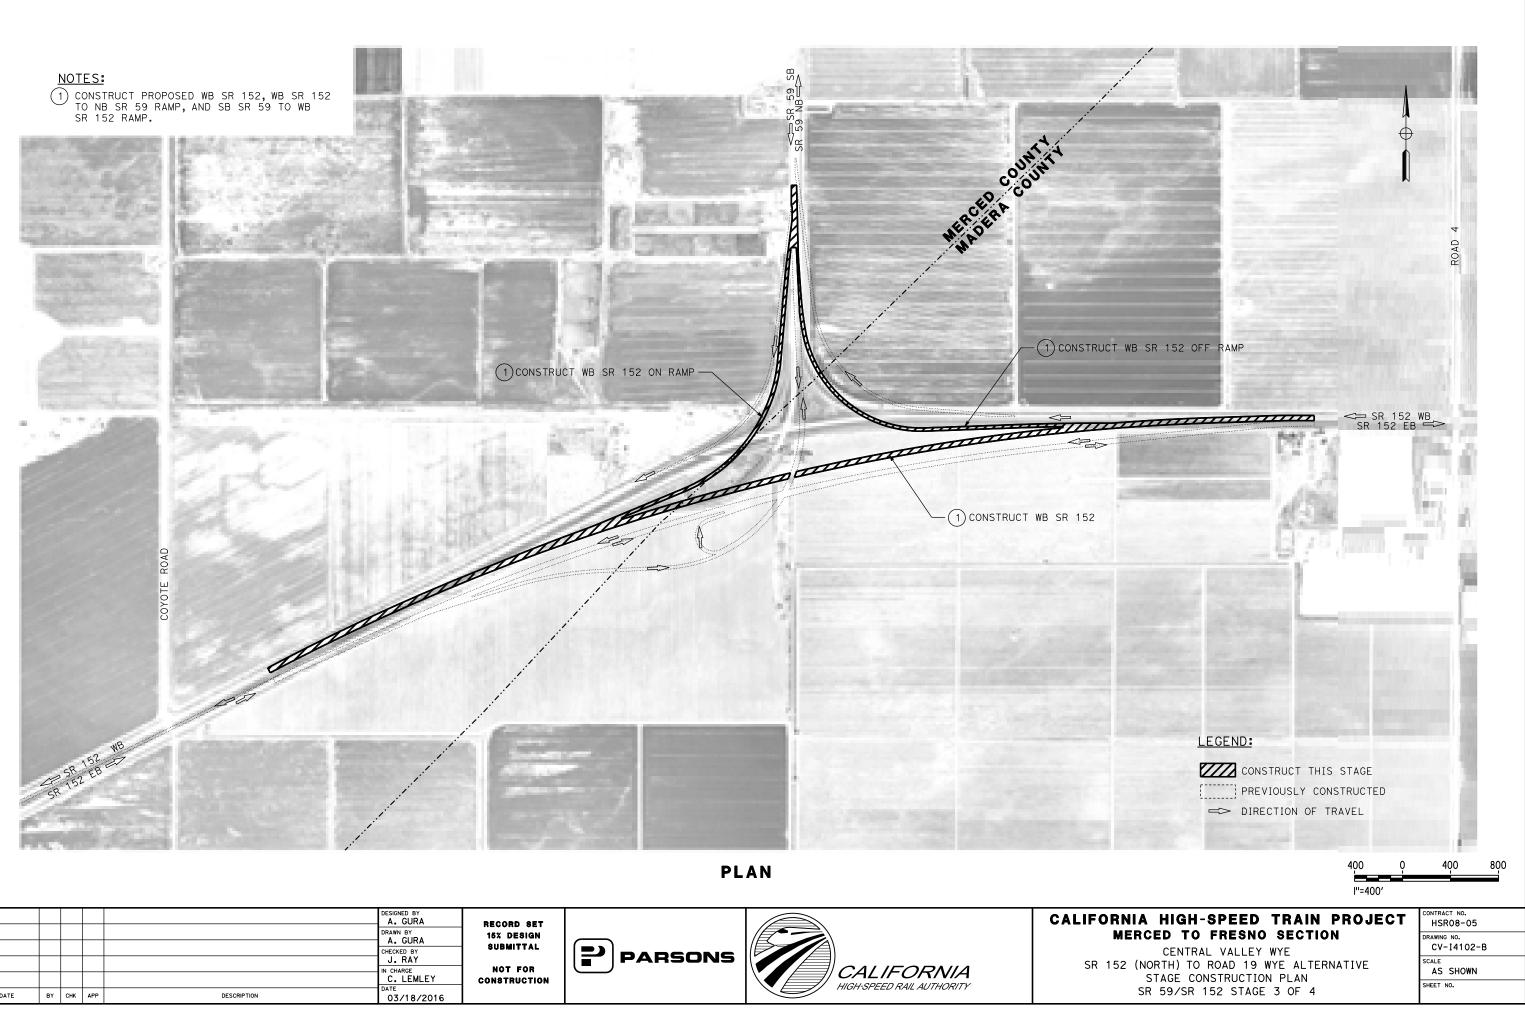
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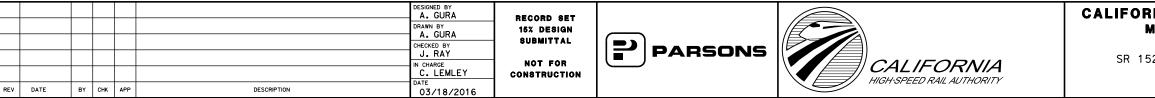



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REV.	DATE	ВҮ	СНК	APP DESCRIPTION	CHECKED BY J. RAY IN CHARGE C. LEMLEY DATE 03/18/2016	SUBMITTAL Not for Construction	PARSONS	CALIFORNIA HIGH-SPEED RAIL AUTHORITY	SR 152



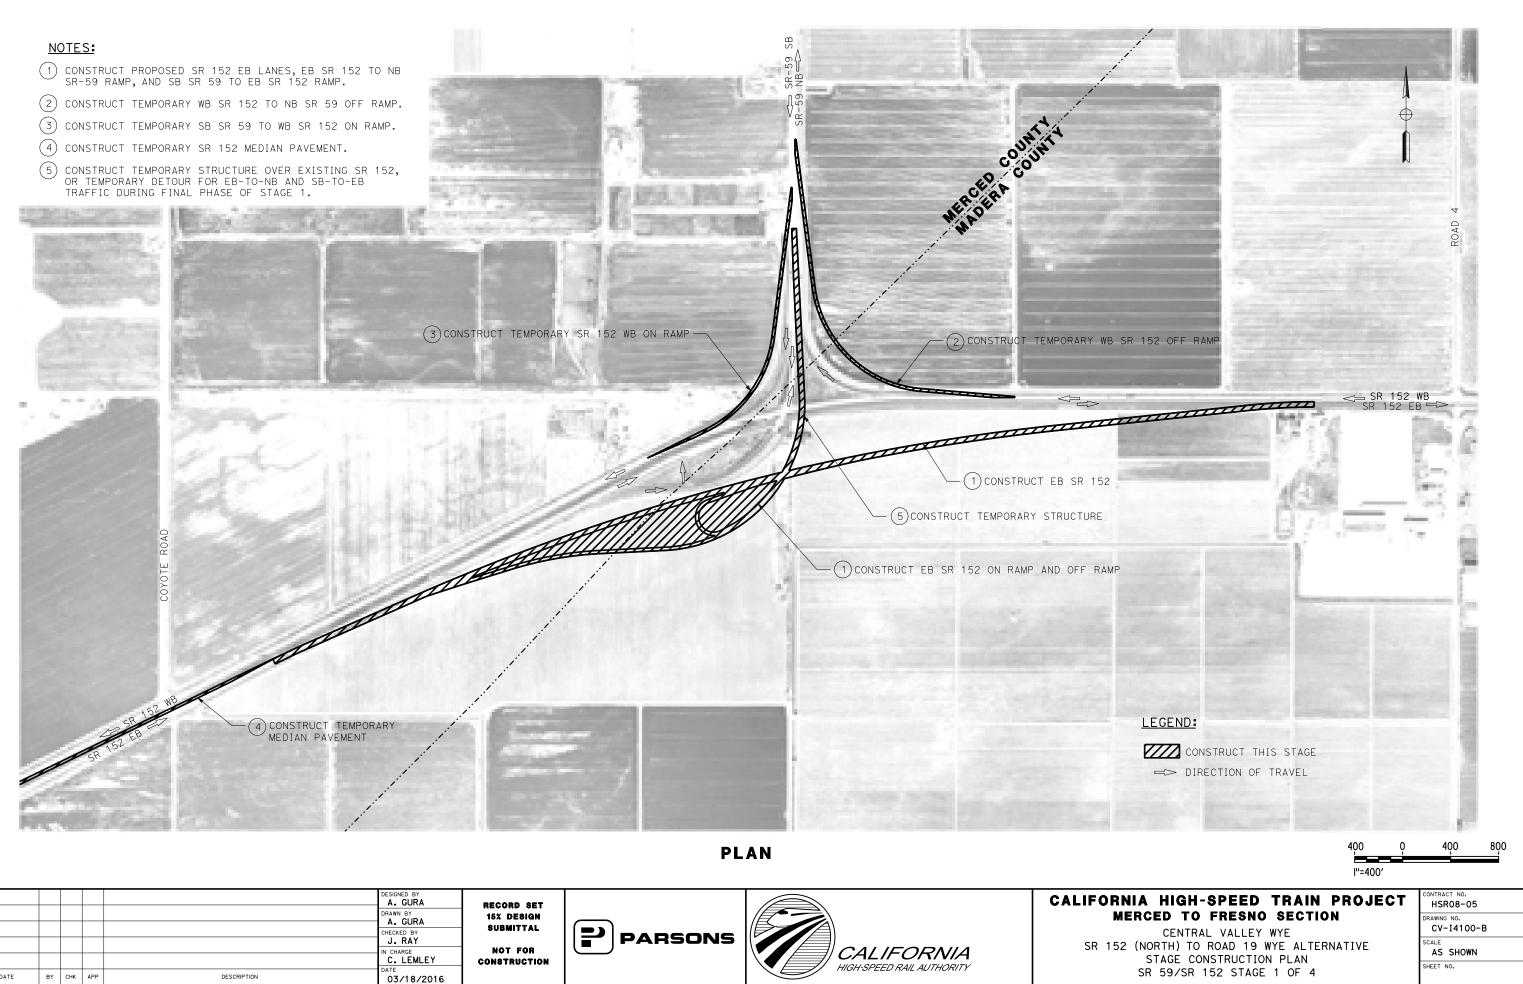



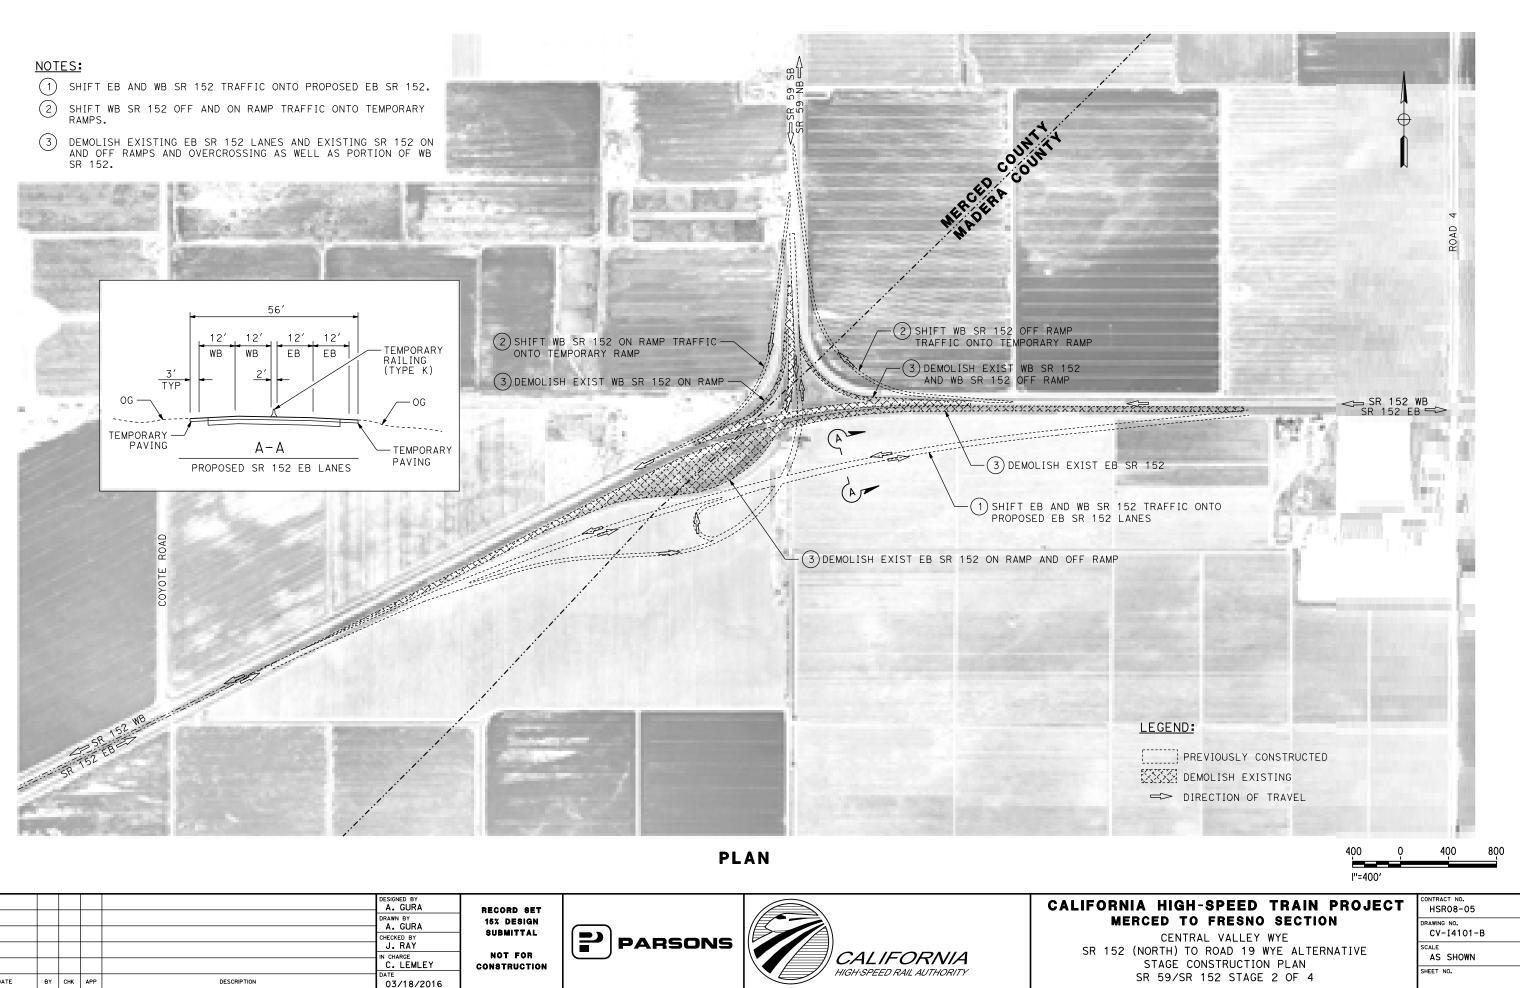

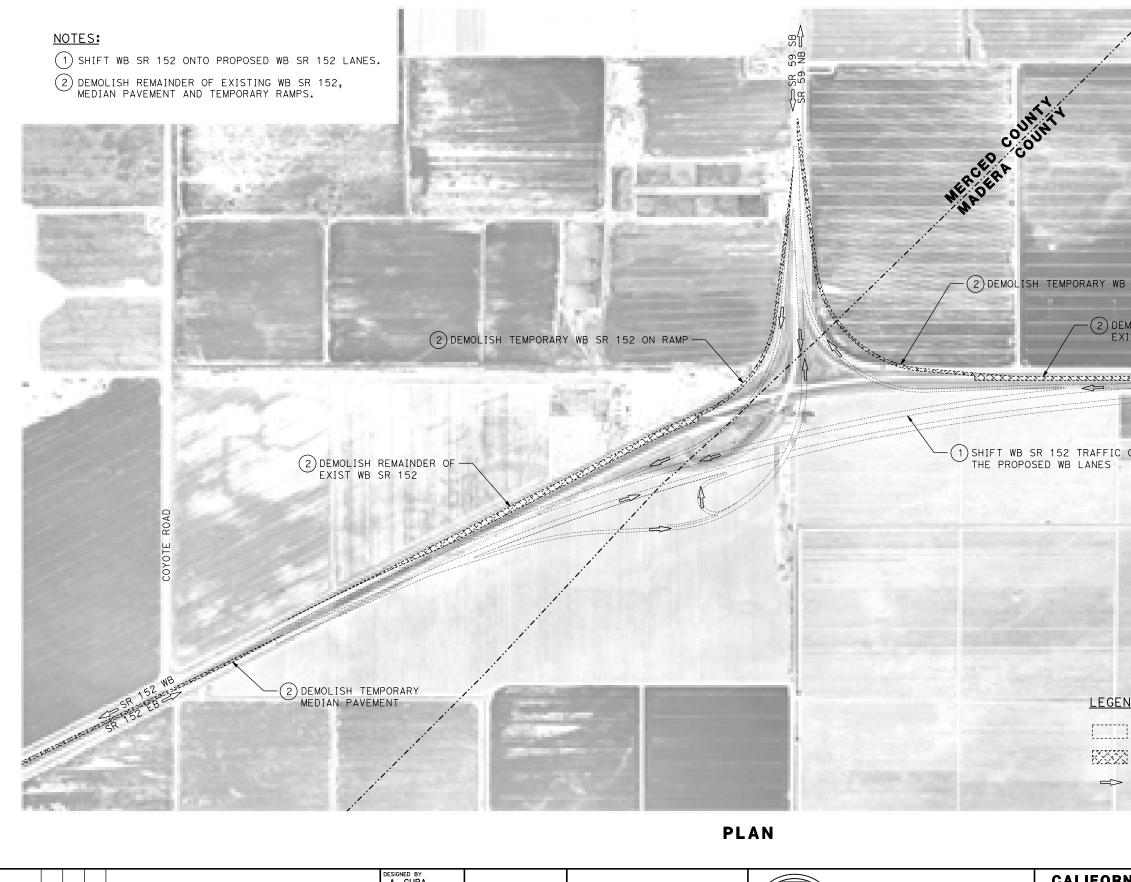


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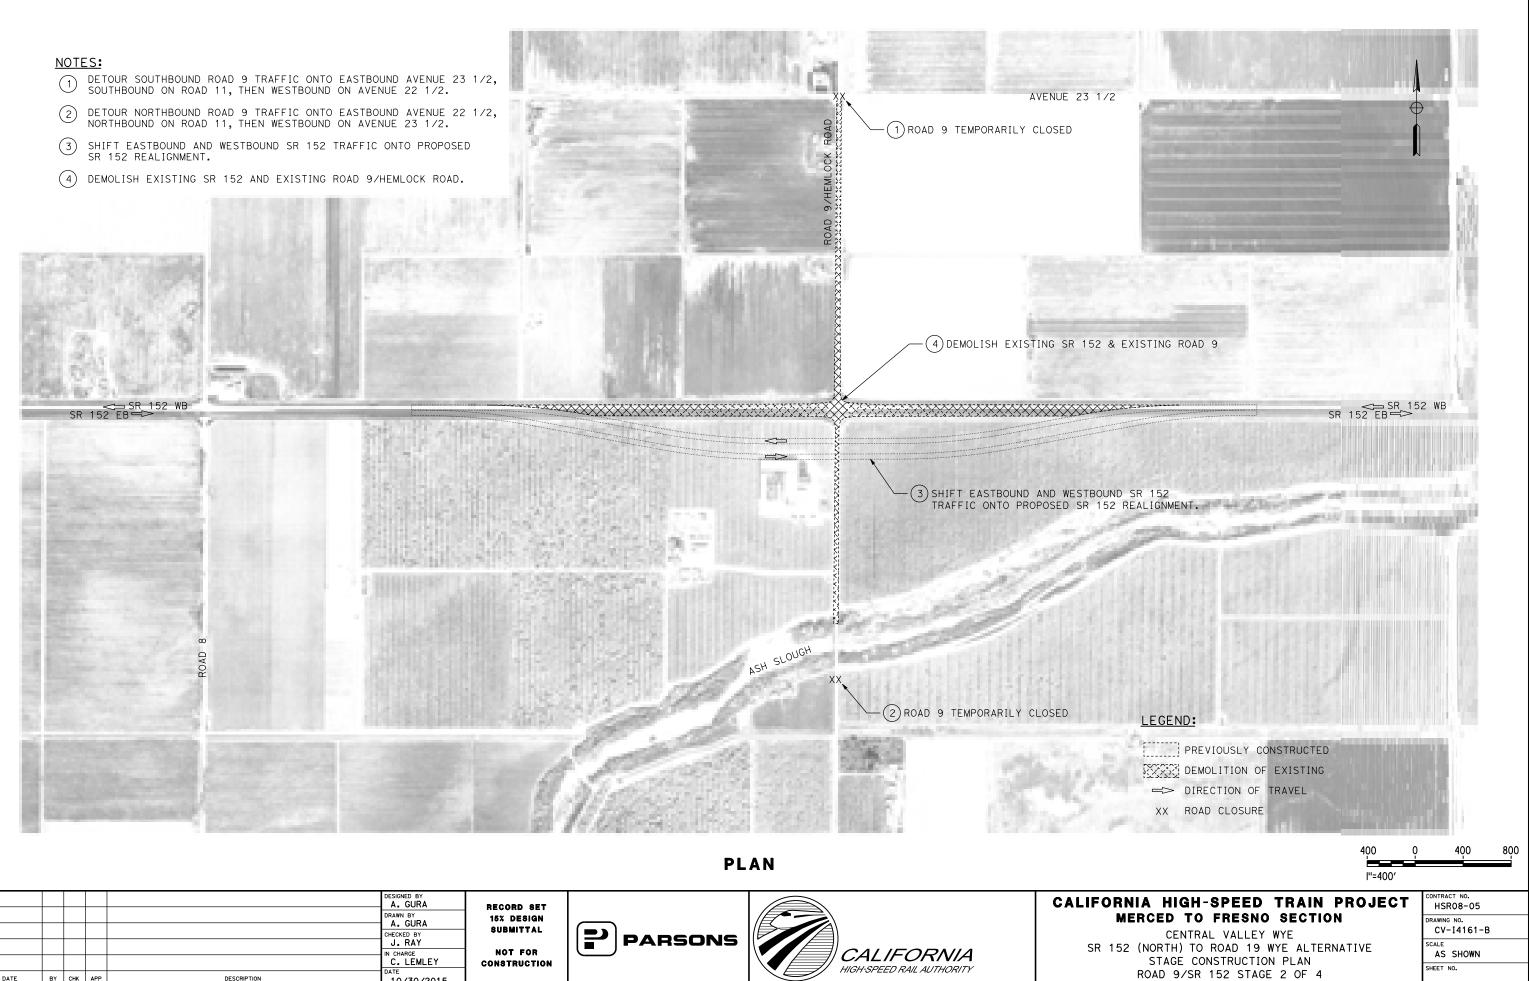
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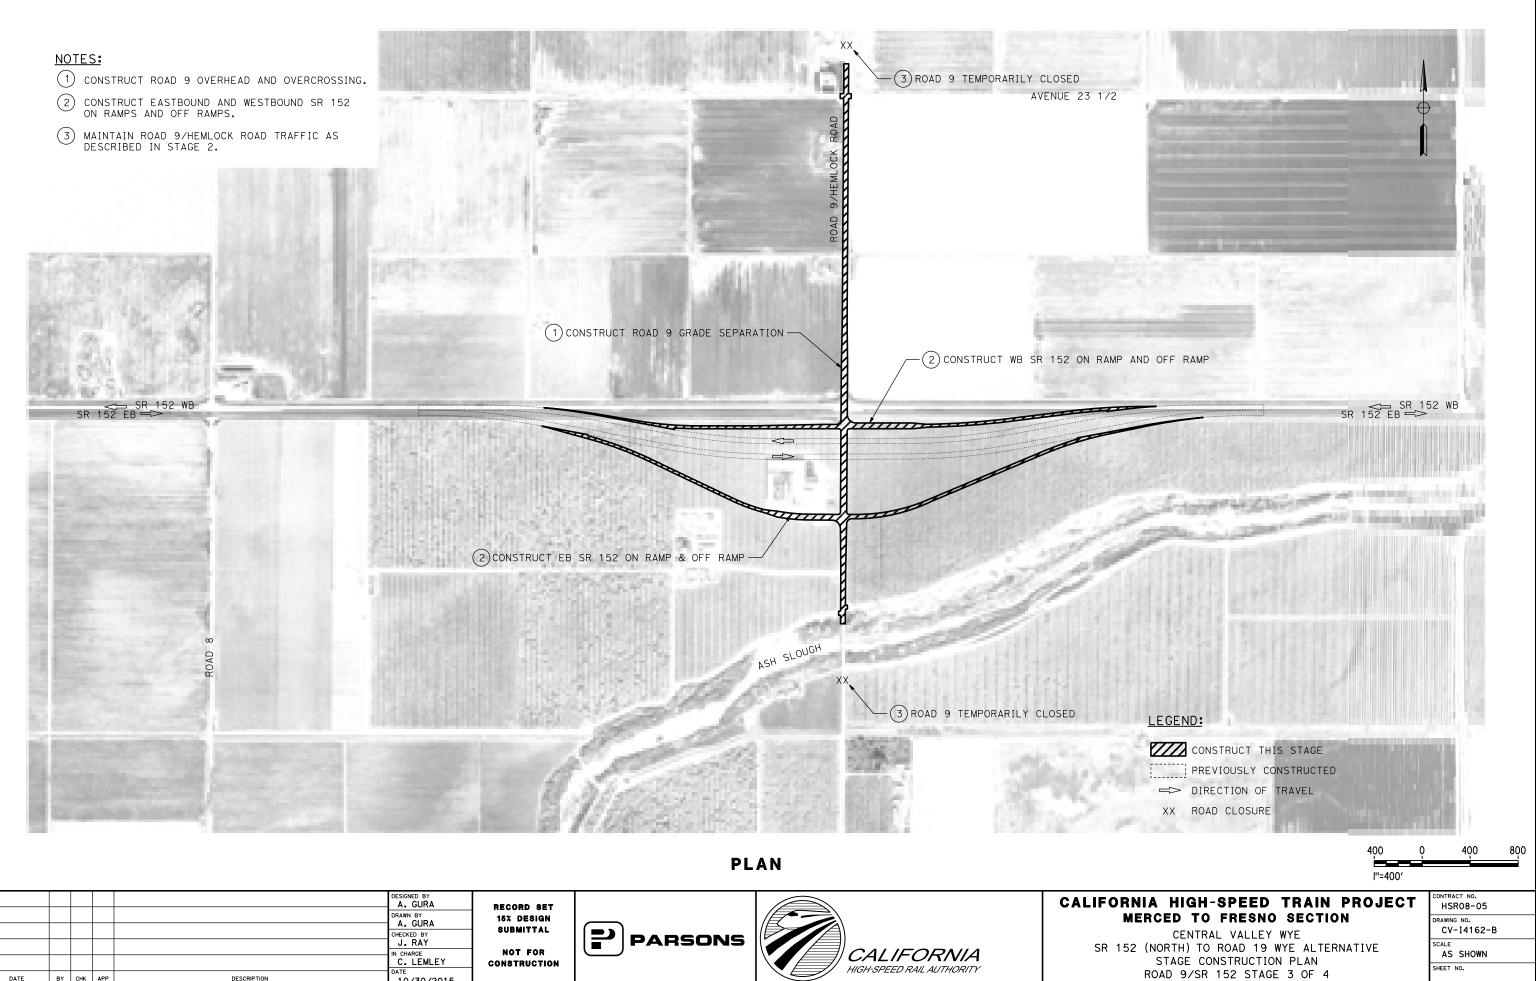
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52 (NORTH) TO ROAD 19 WYE STAGE CONSTRUCTION I	E ALTERNATIVE		ALE AS SHOWN	
SR 59/SR 152 STAGE 4		SHE	ET NO.	




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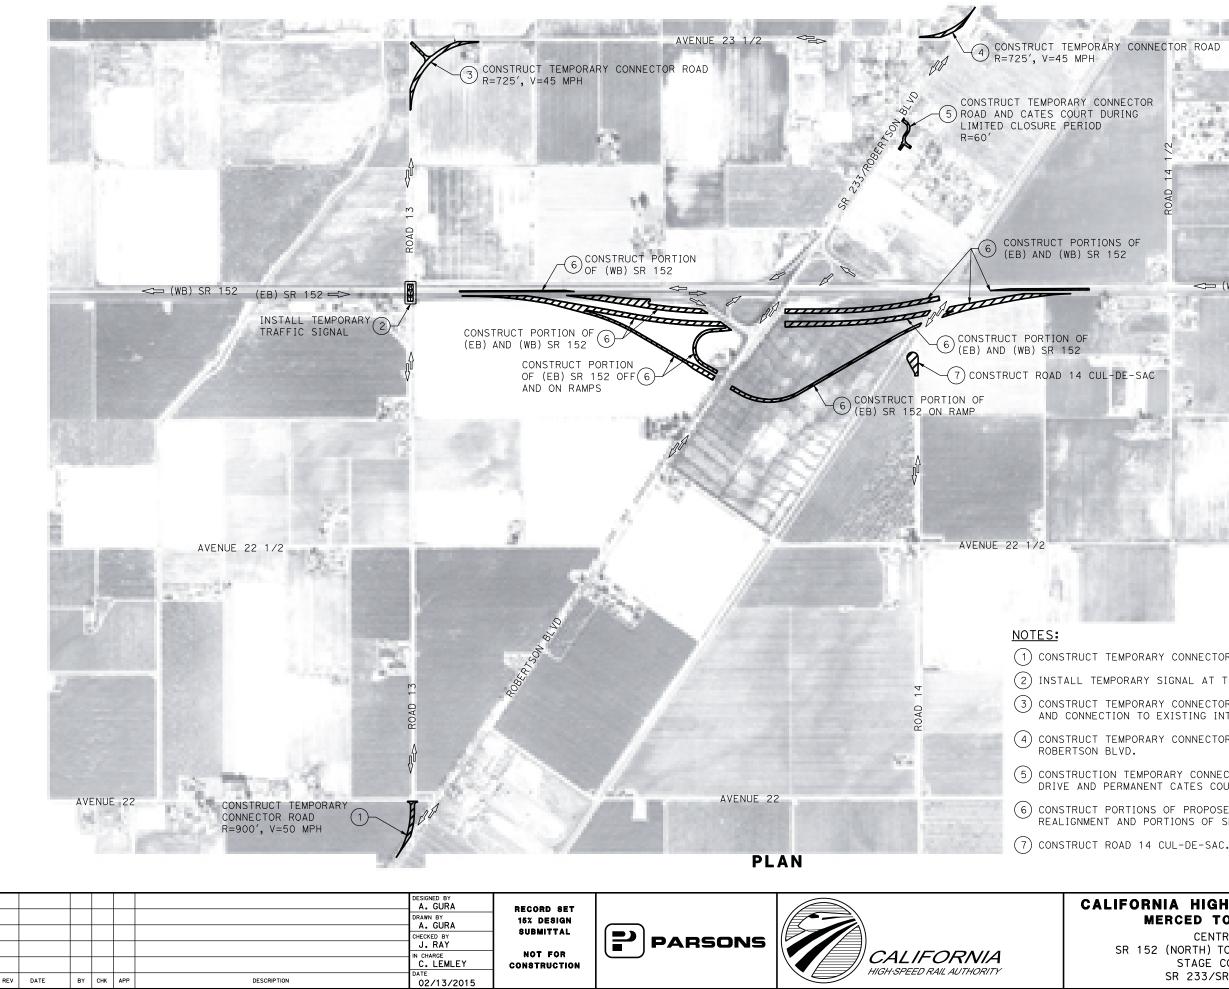
DATE BY CHK APP 10/30/2015

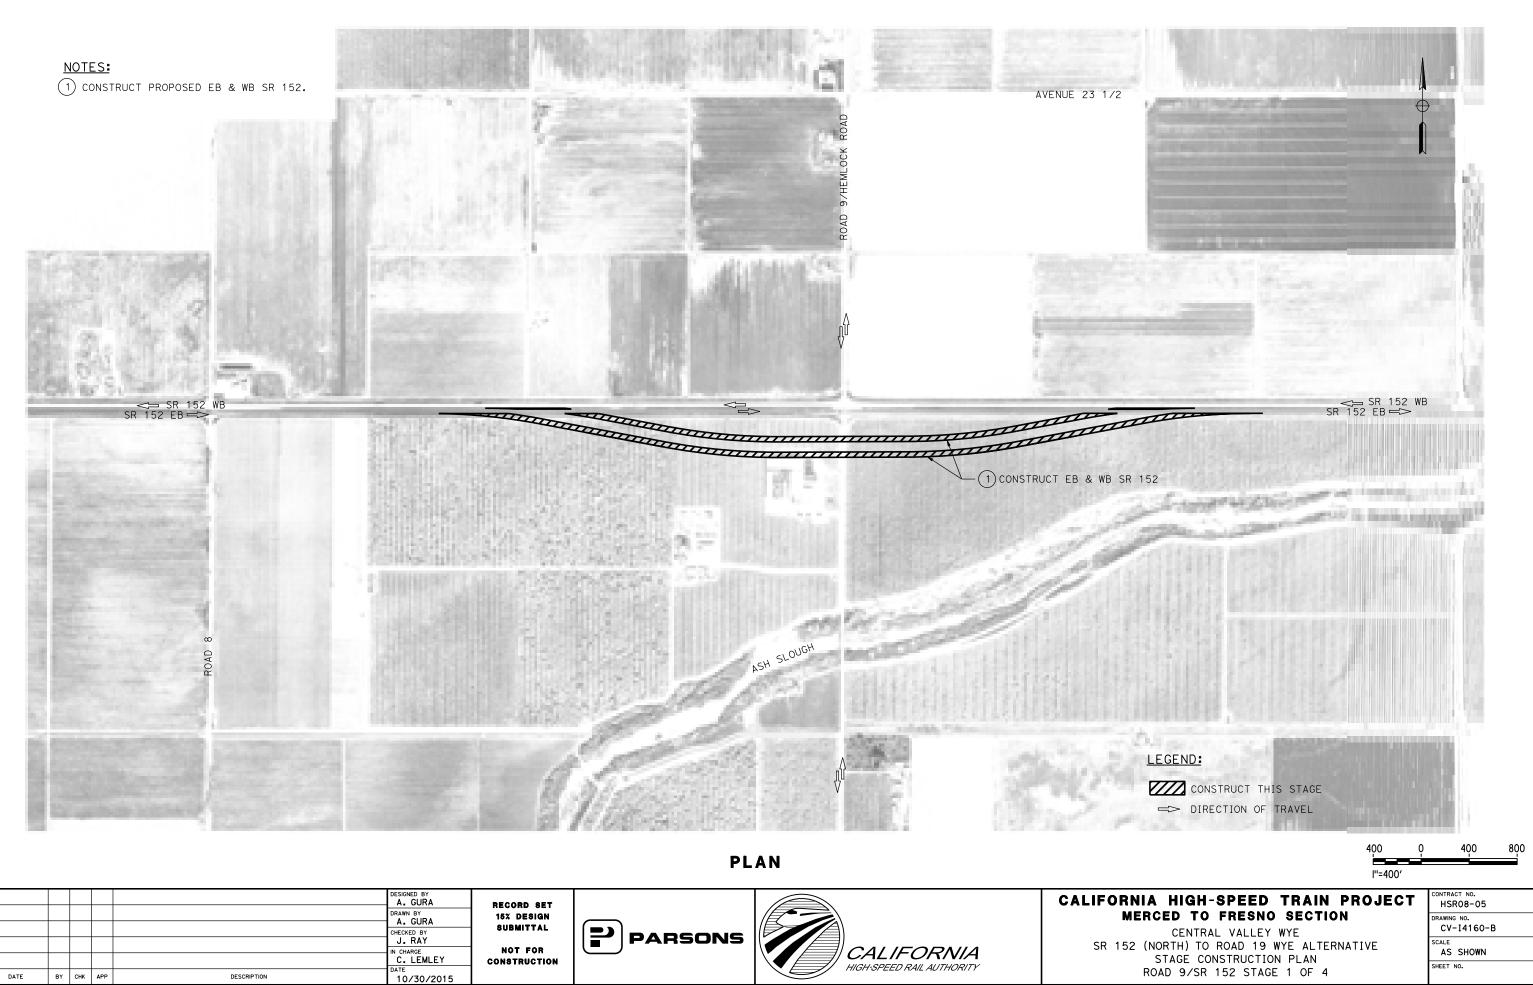

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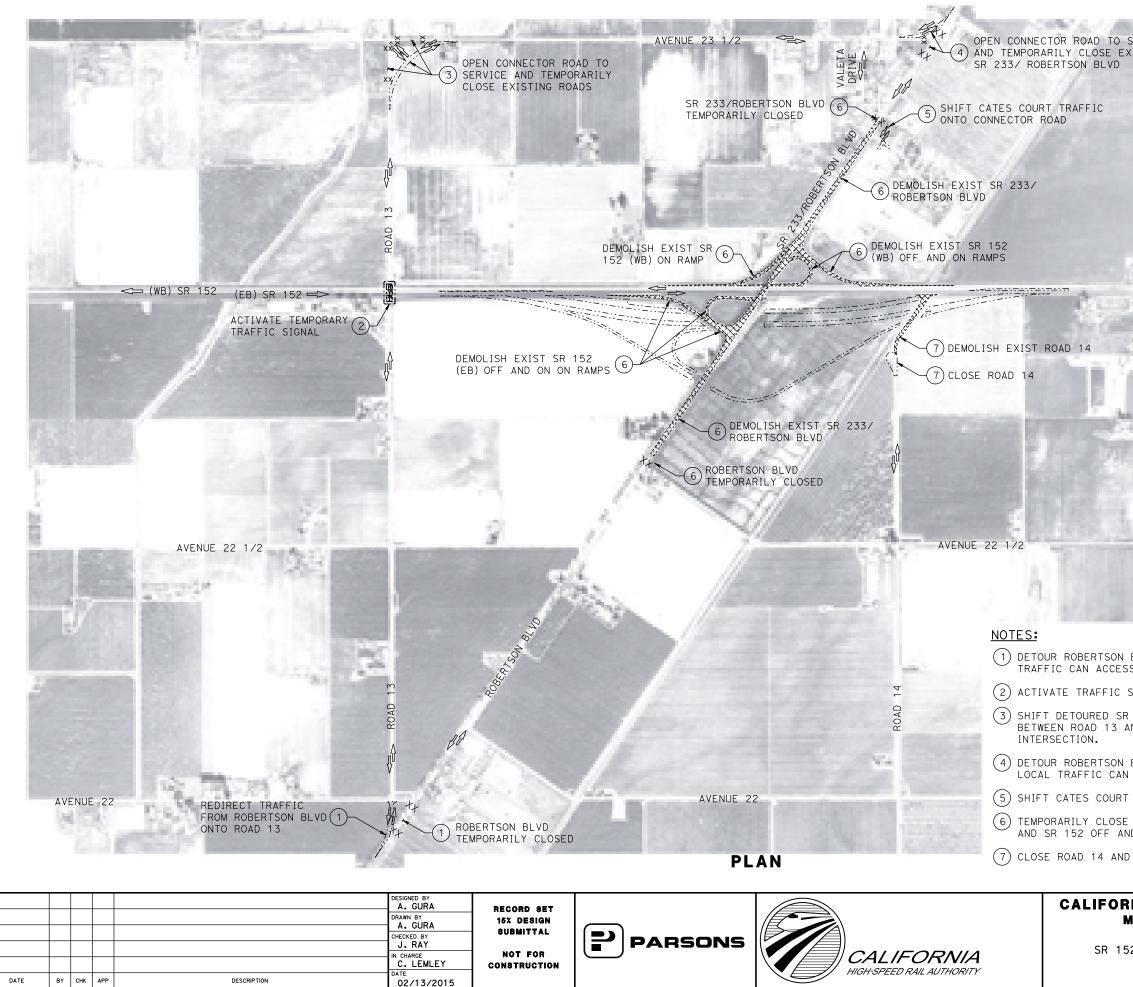


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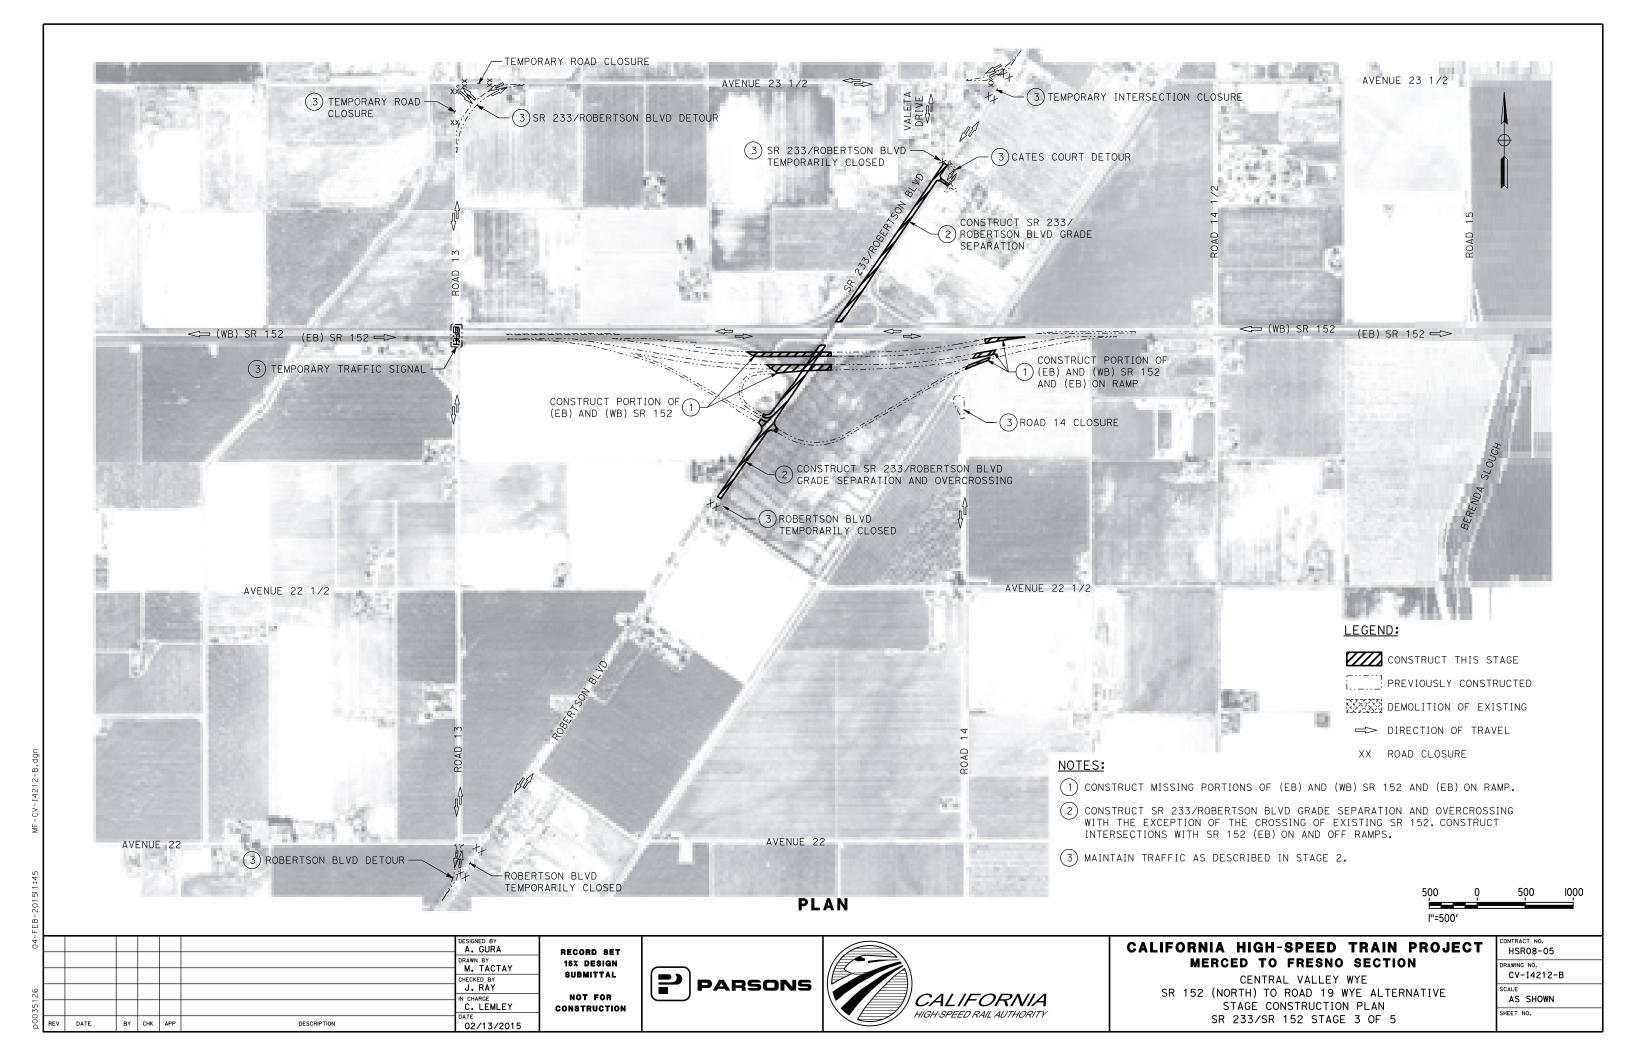
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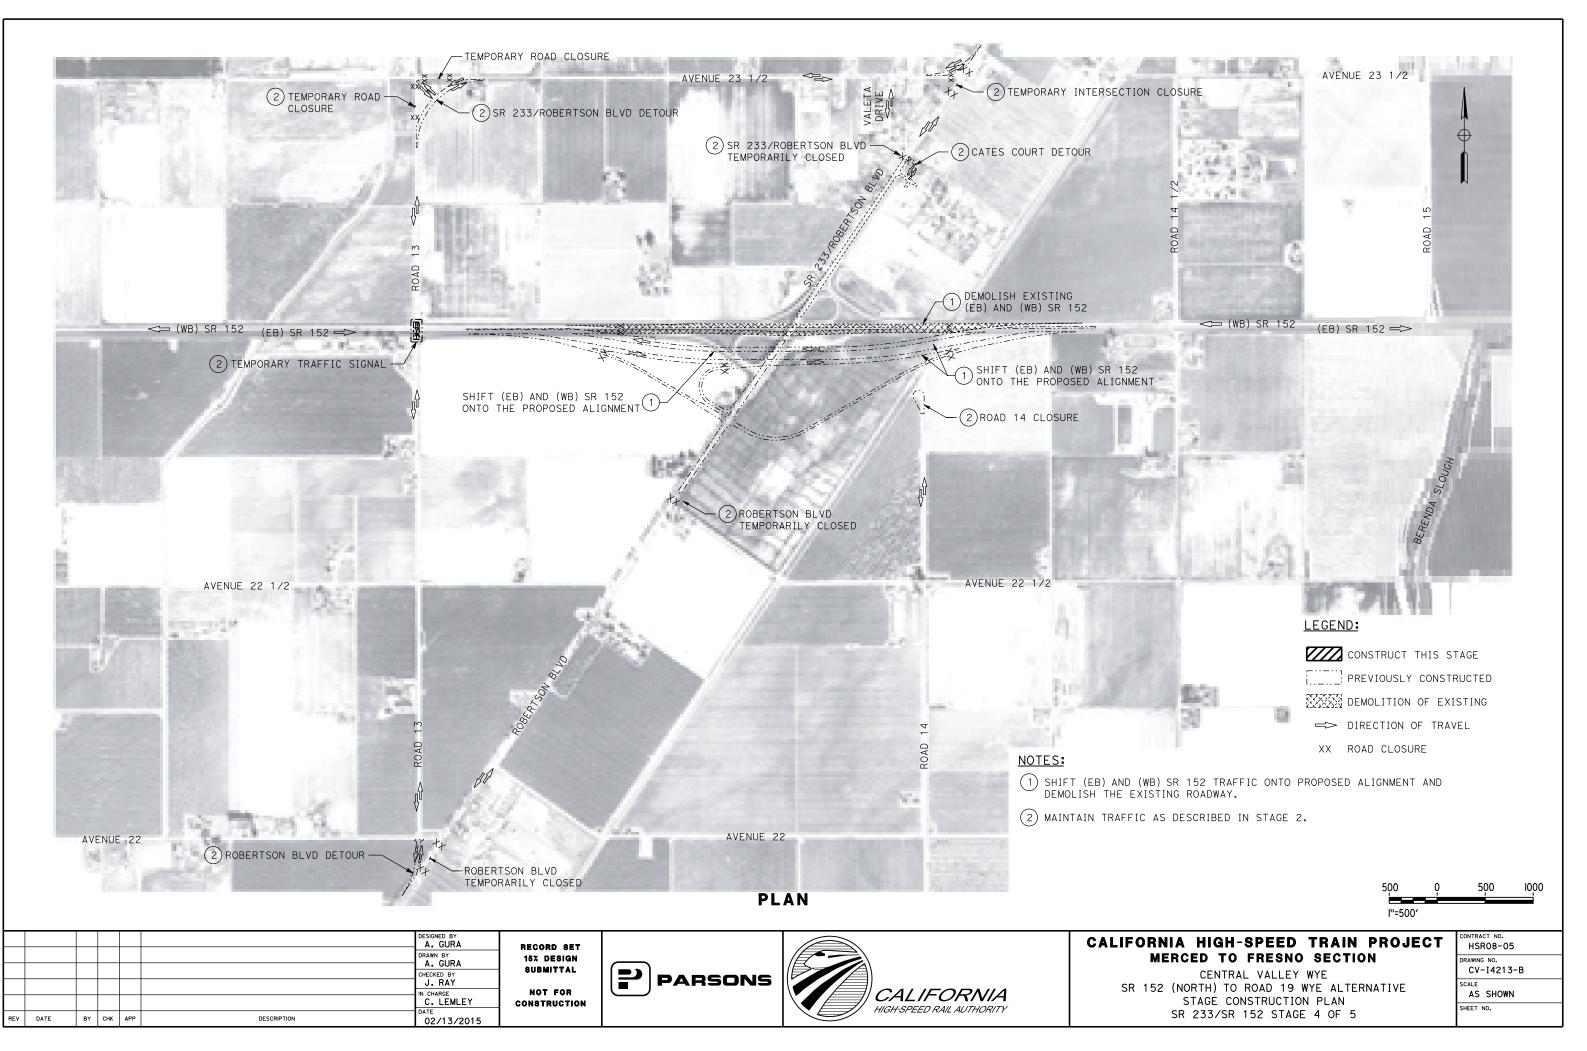
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MERCED TO FRESNO SECTIO Central Valley Wye	N		DRAWING NO. CV-I4210-B	
52 (NORTH) TO ROAD 19 WYE ALTEF STAGE CONSTRUCTION PLAN	RNATIVE		SCALE AS SHOWN	
SR 233/SR 152 STAGE 1 OF 5			SHEET NO.	

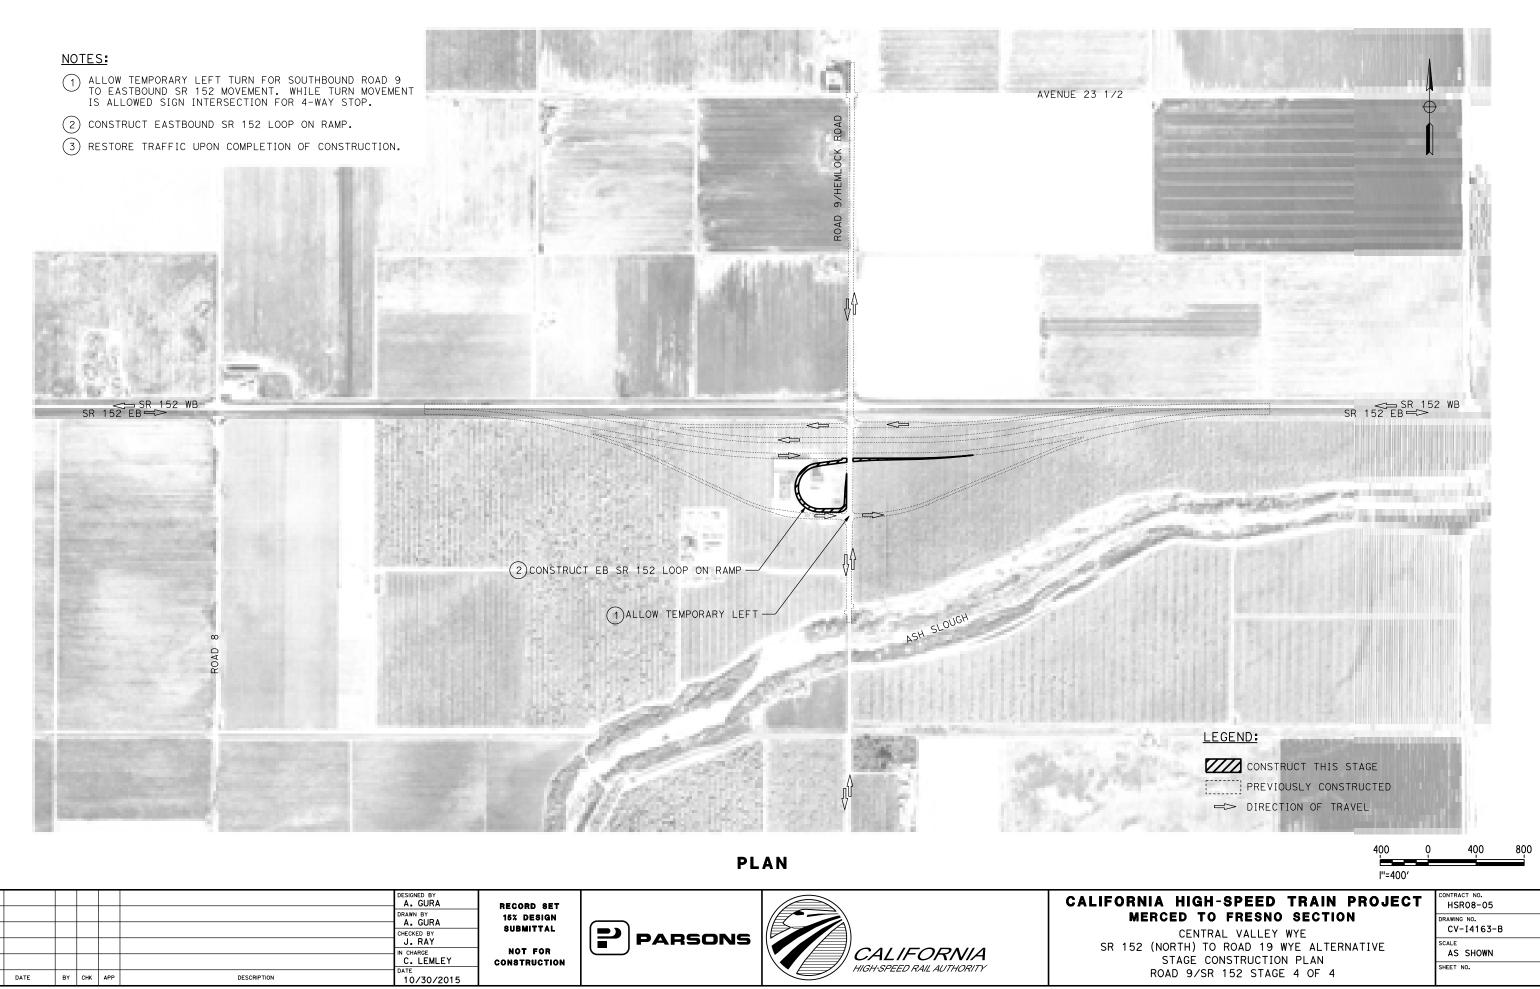


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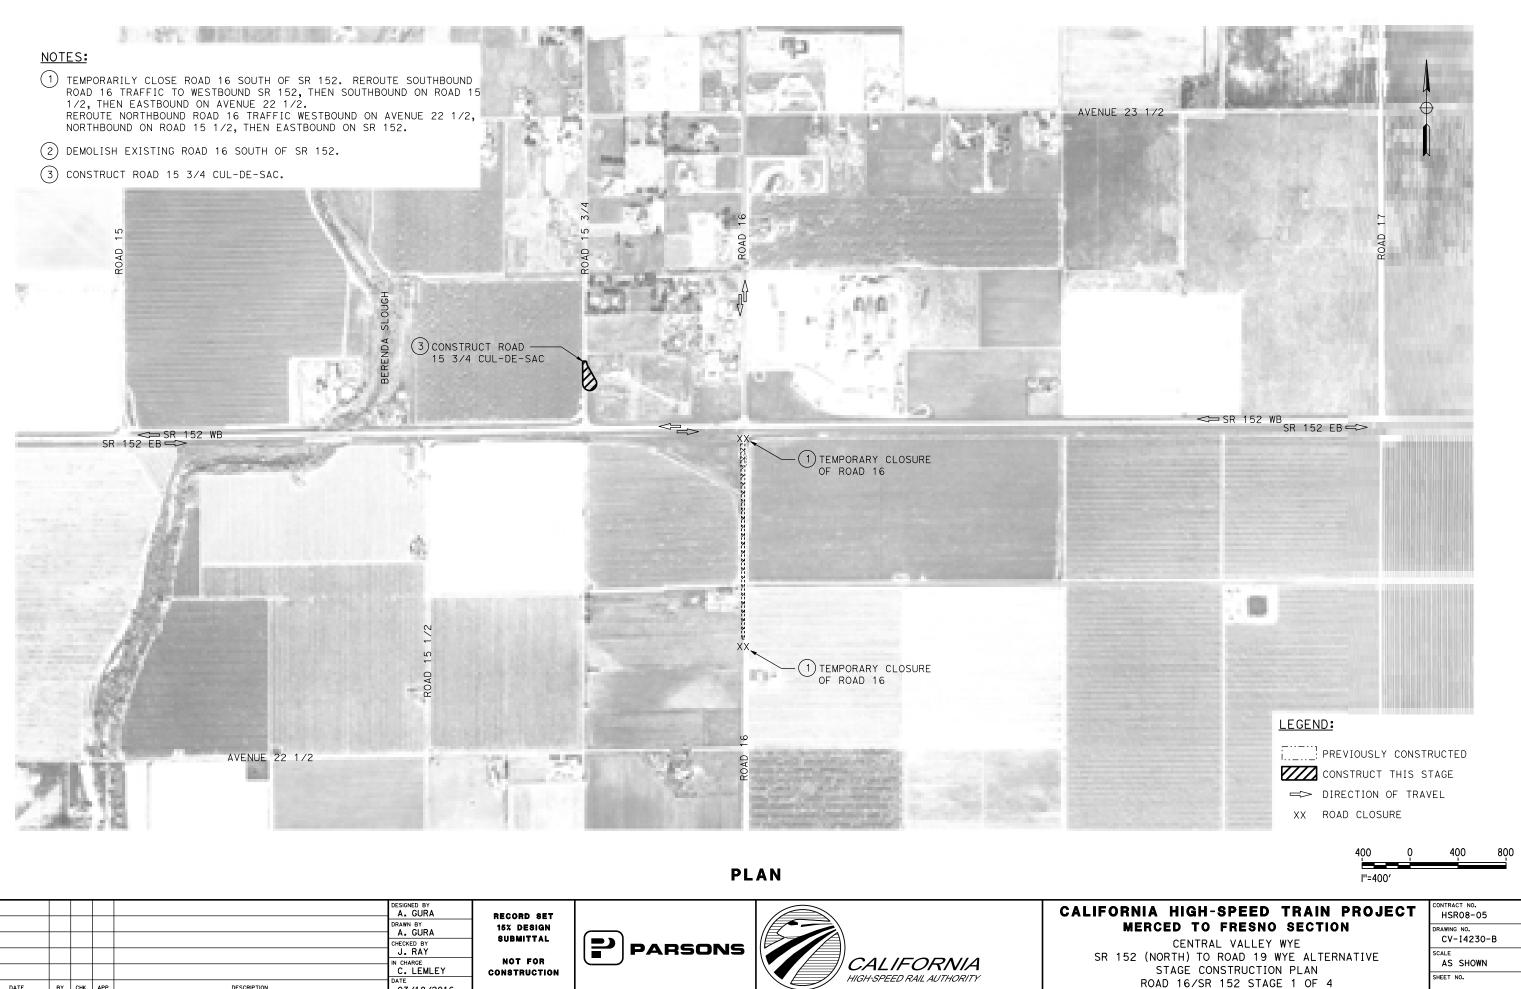
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AERCED TO FRESNO SECTION CENTRAL VALLEY WYE	DRAWING NO. CV-I4211-B
2 (NORTH) TO ROAD 19 WYE ALTERNATIVE	SCALE AS SHOWN
STAGE CONSTRUCTION PLAN SR 233/SR 152 STAGE 2 OF 5	SHEET NO.






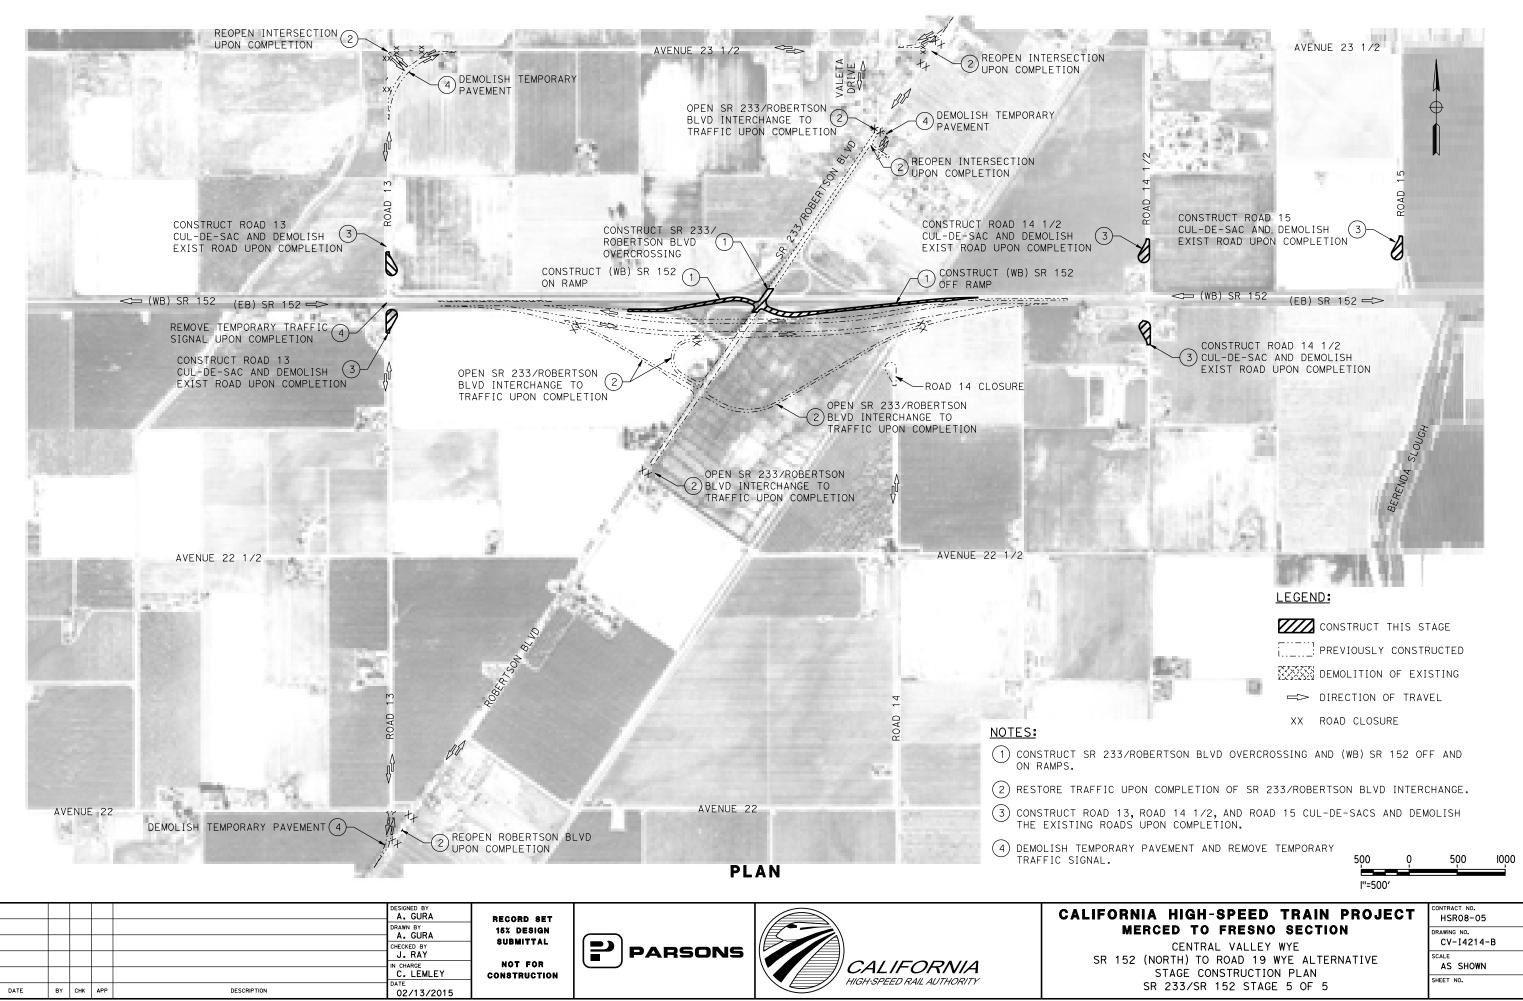


RNIA HIGH-SPEED TRAIN PROJECT	HSR08-05
MERCED TO FRESNO SECTION	DRAWING NO.
CENTRAL VALLEY WYE	CV-14214-B
52 (NORTH) TO ROAD 19 WYE ALTERNATIVE	SCALE
STAGE CONSTRUCTION PLAN	AS SHOWN
SR 233/SR 152 STAGE 5 OF 5	SHEET NO.




REV DATE ВҮ СНК АРР DESCRIPTION 03/18/2016

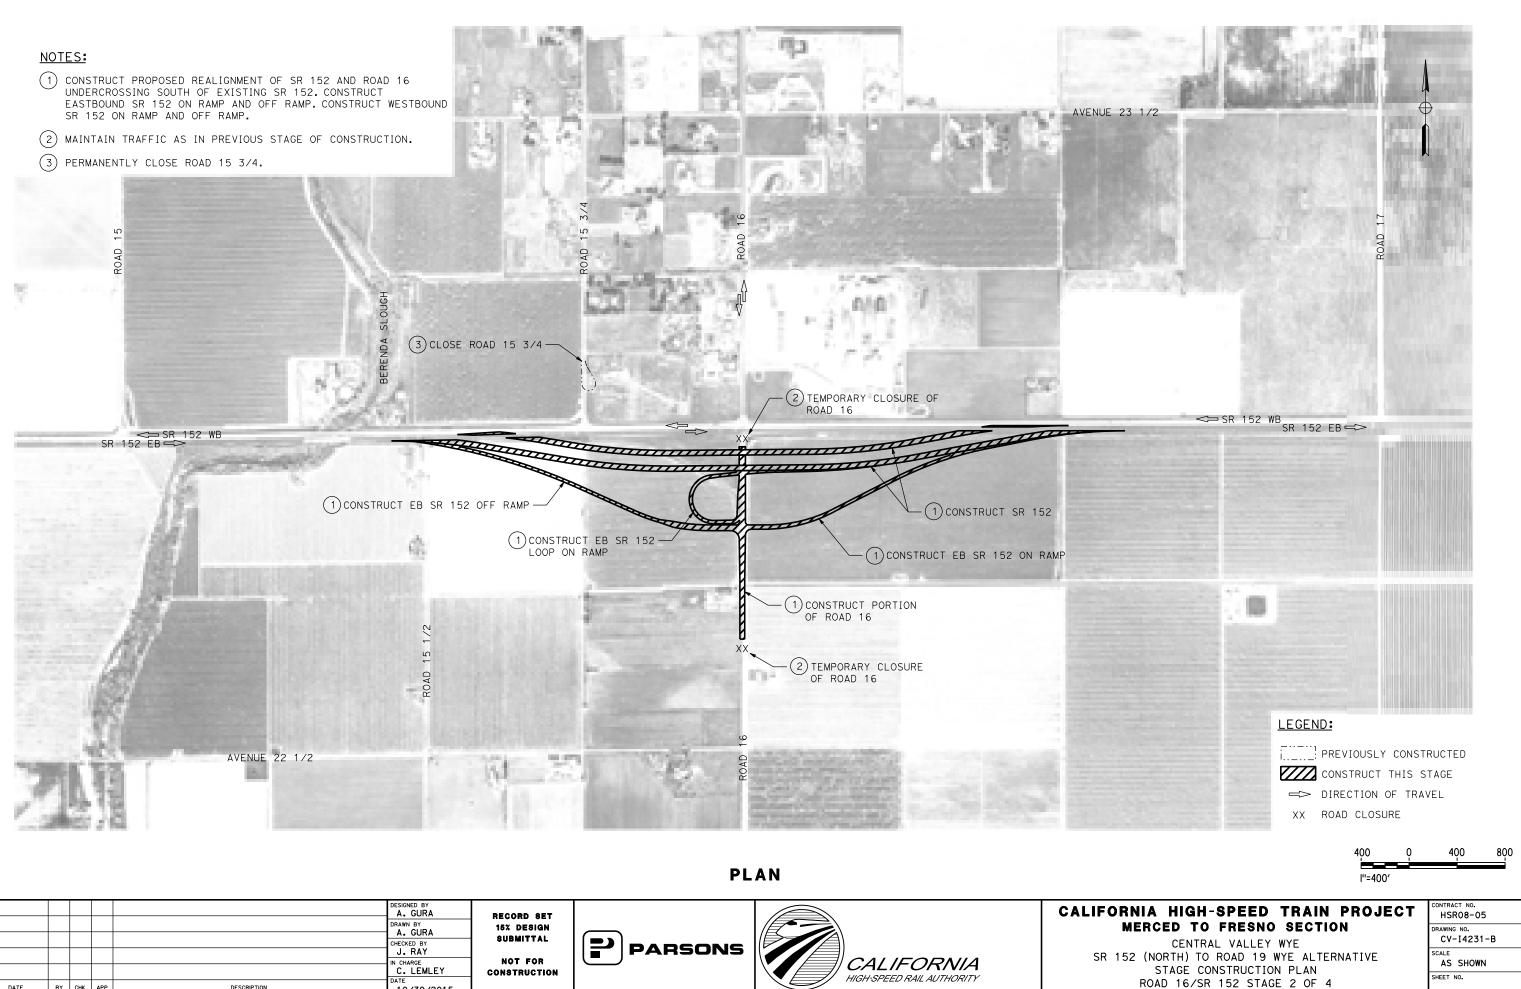


REV DATE BY CHK APP DESCRIPTION 10/30/2015

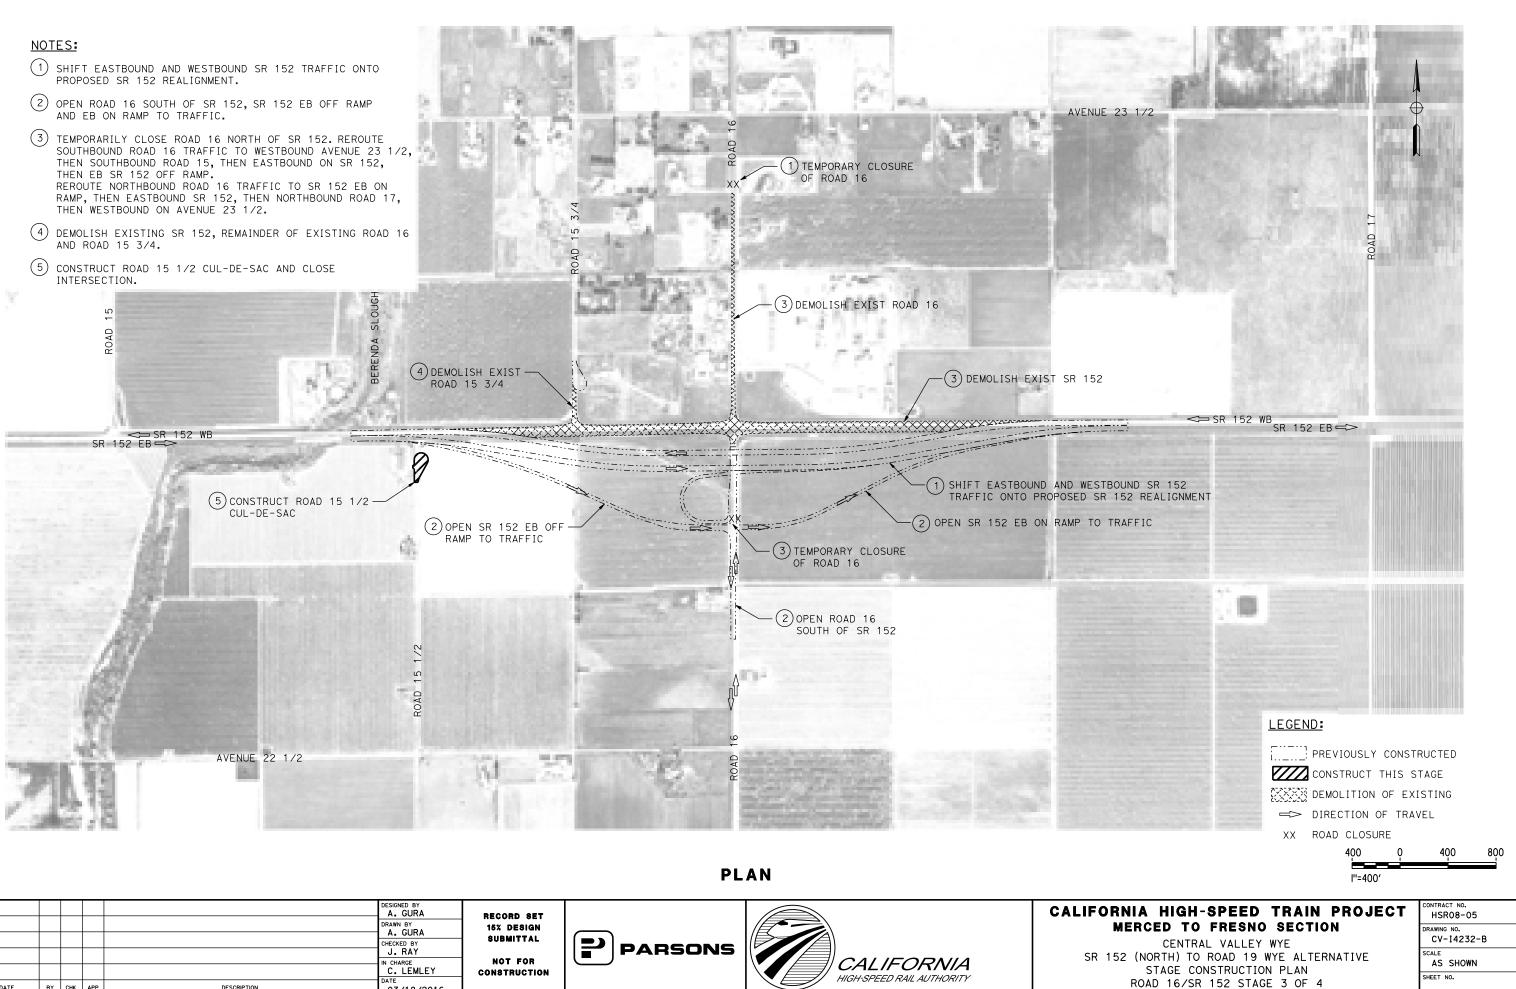


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HIGH-SPEED RAIL AUTHORITY REV DATE ВҮ СНК АРР DESCRIPTION 03/18/2016

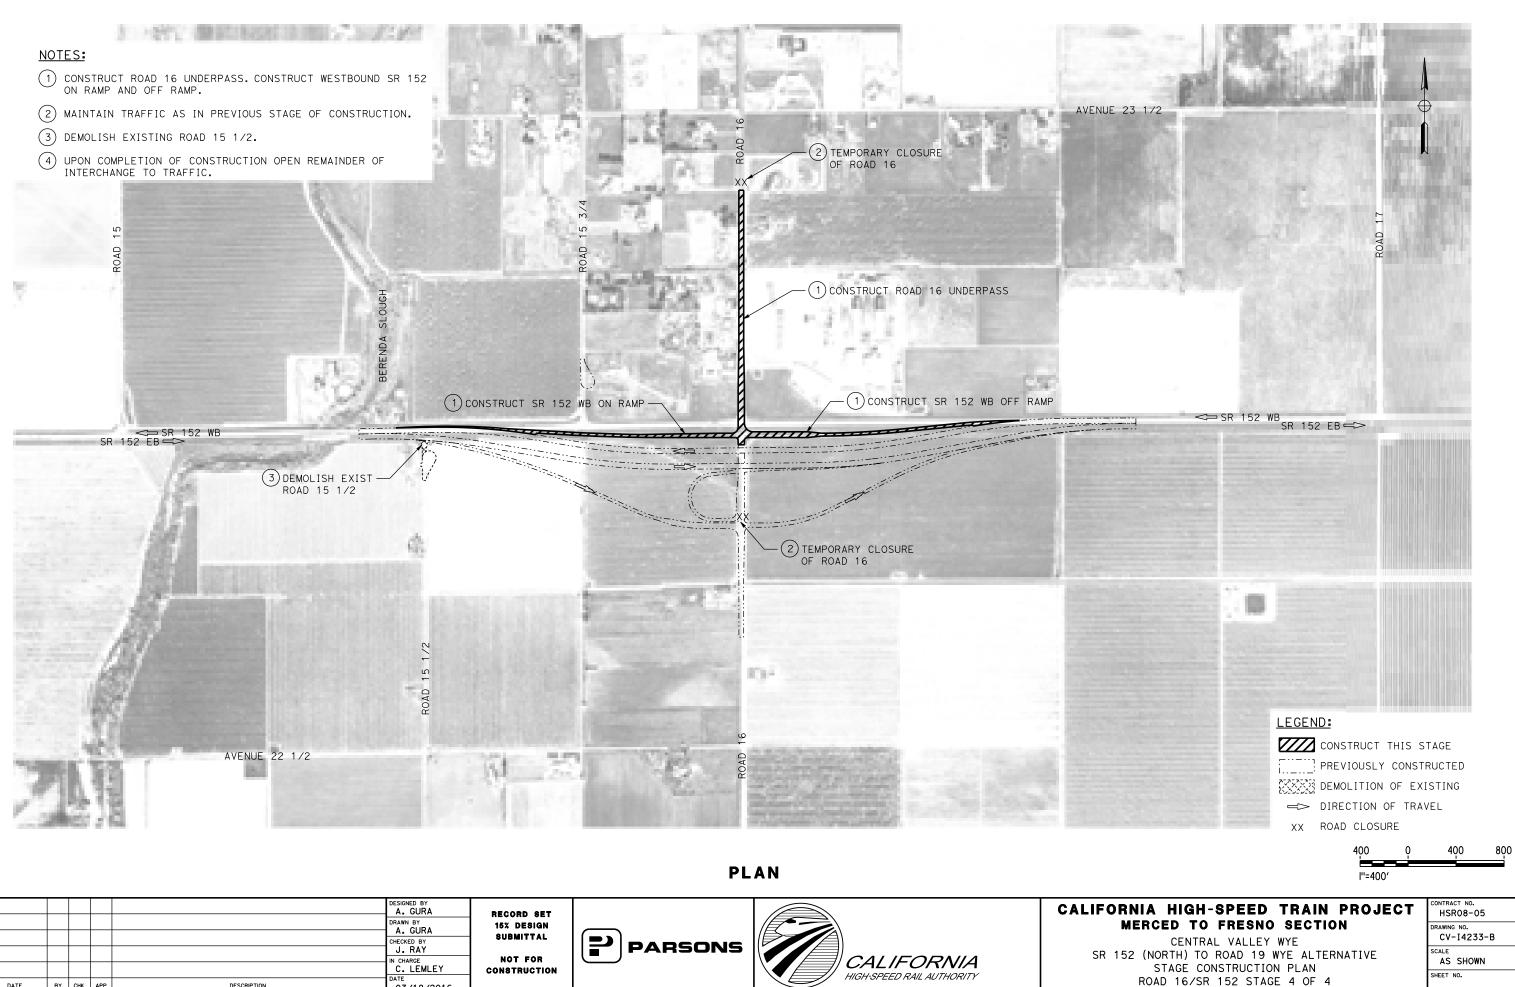

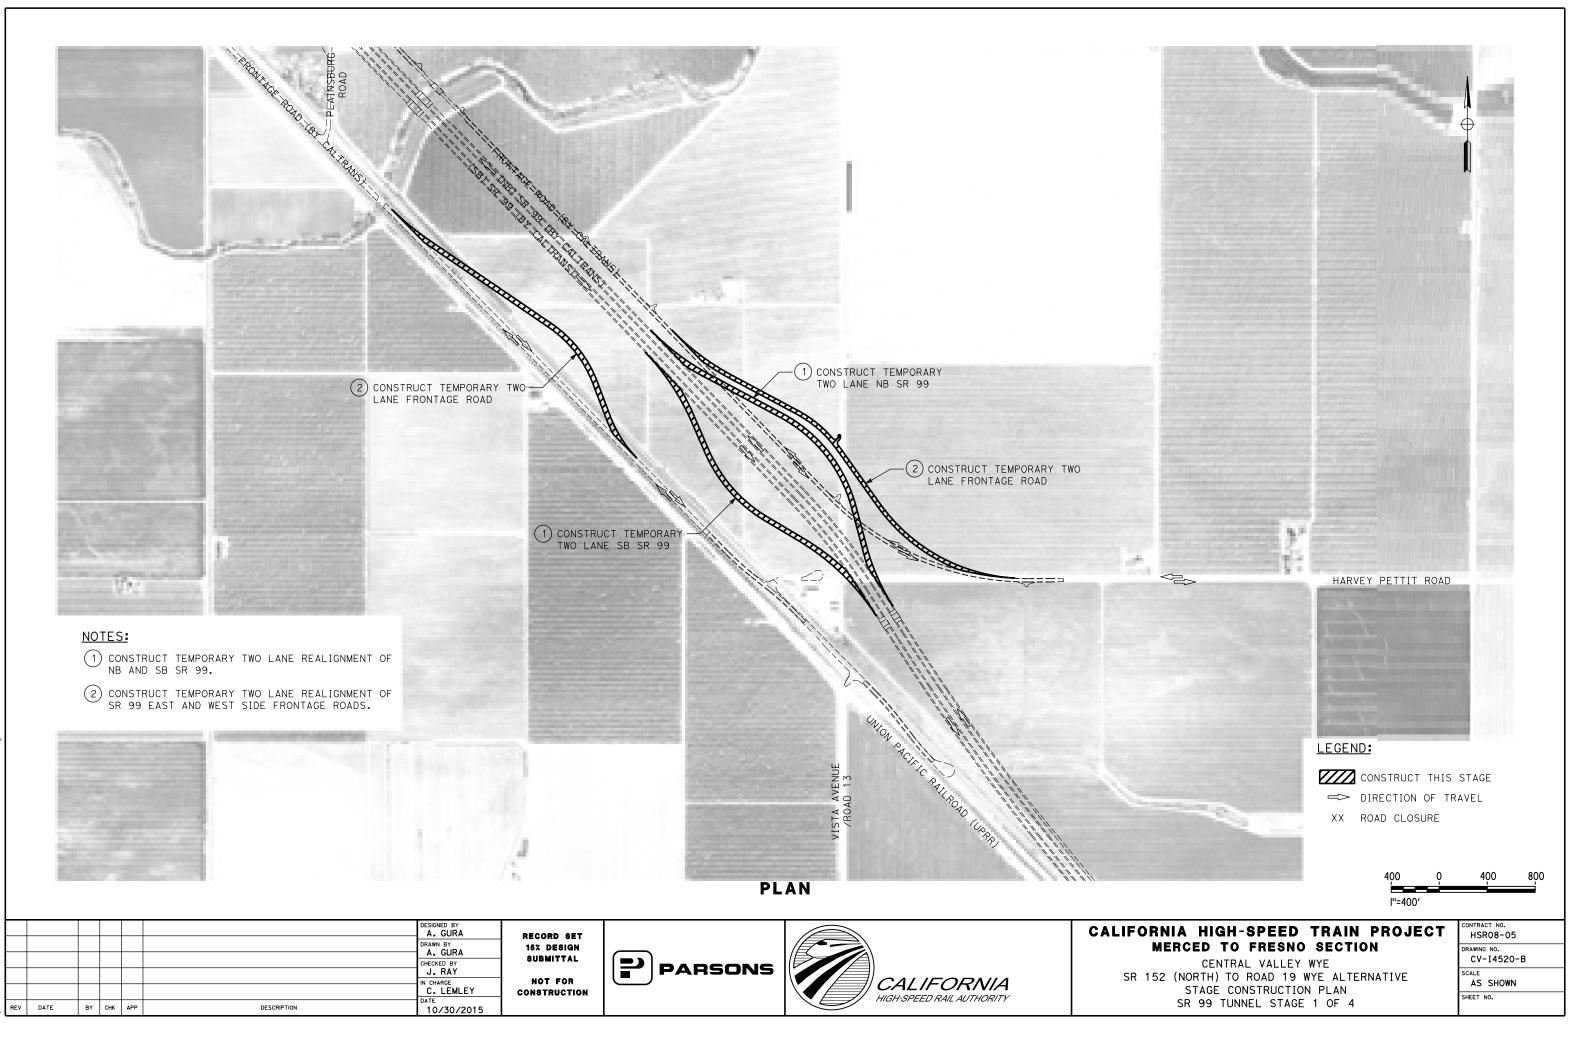


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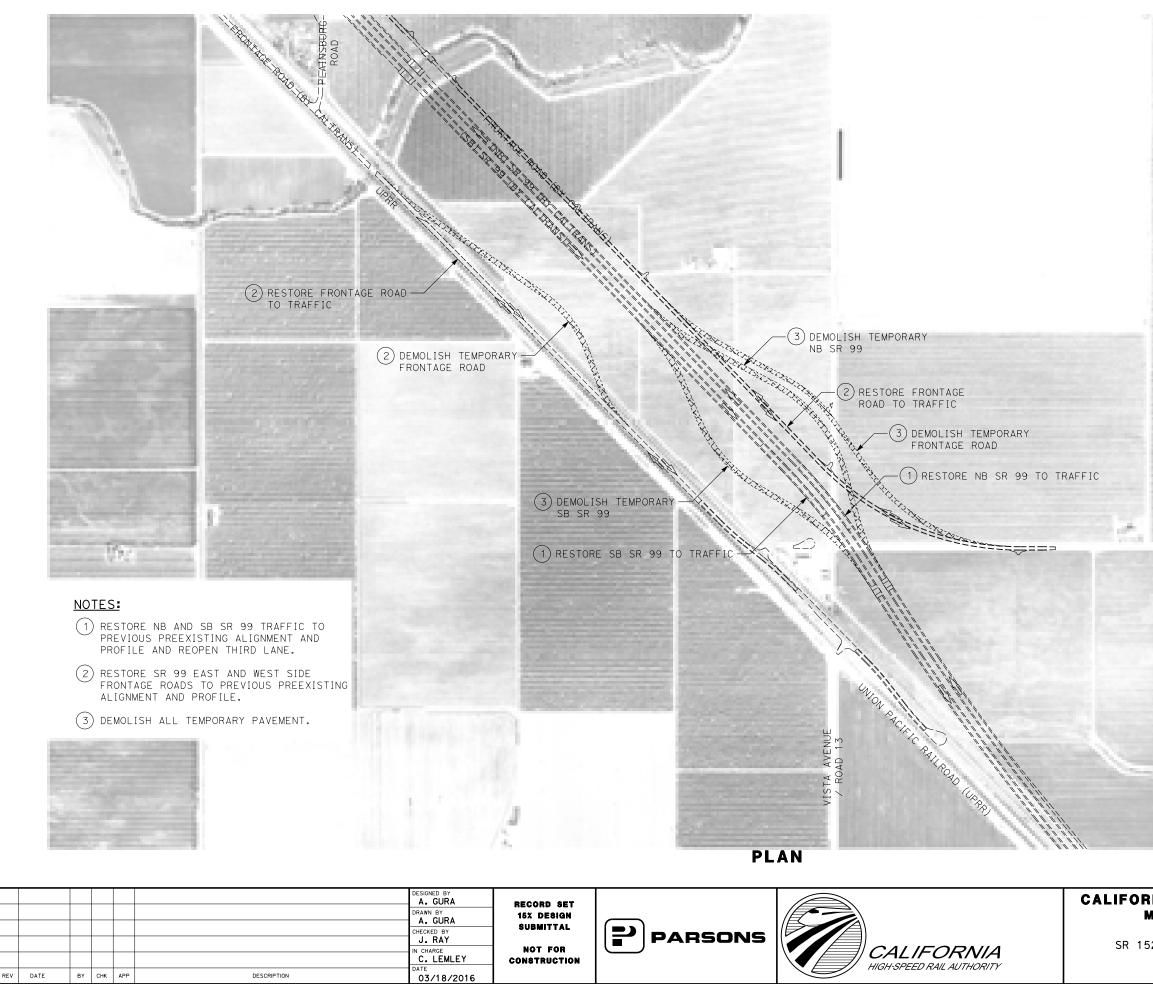
SR 152 (NORTH) TO ROAD 19 WYE ALTERNATIVE STAGE CONSTRUCTION PLAN SR 99 TUNNEL STAGE 2 OF 4

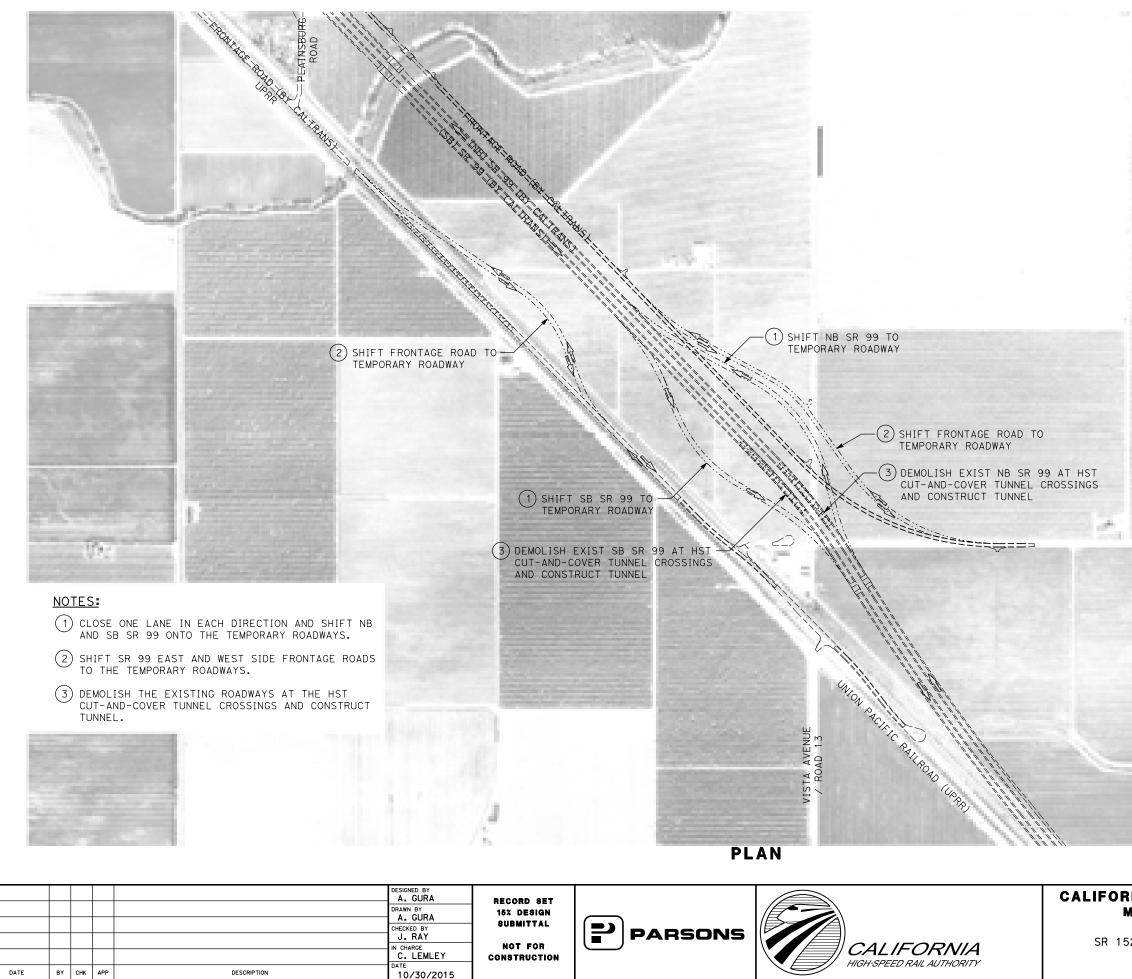SCALE AS SHOWN SHEET NO.



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CENTRAL VALLEY WYE SR 152 (NORTH) TO ROAD 19 WYE ALTERNATIVE STAGE CONSTRUCTION PLAN SR 99 TUNNEL STAGE 3 OF 4 DRAWING NO. CV-I4522-B SCALE AS SHOWN SHEET NO.

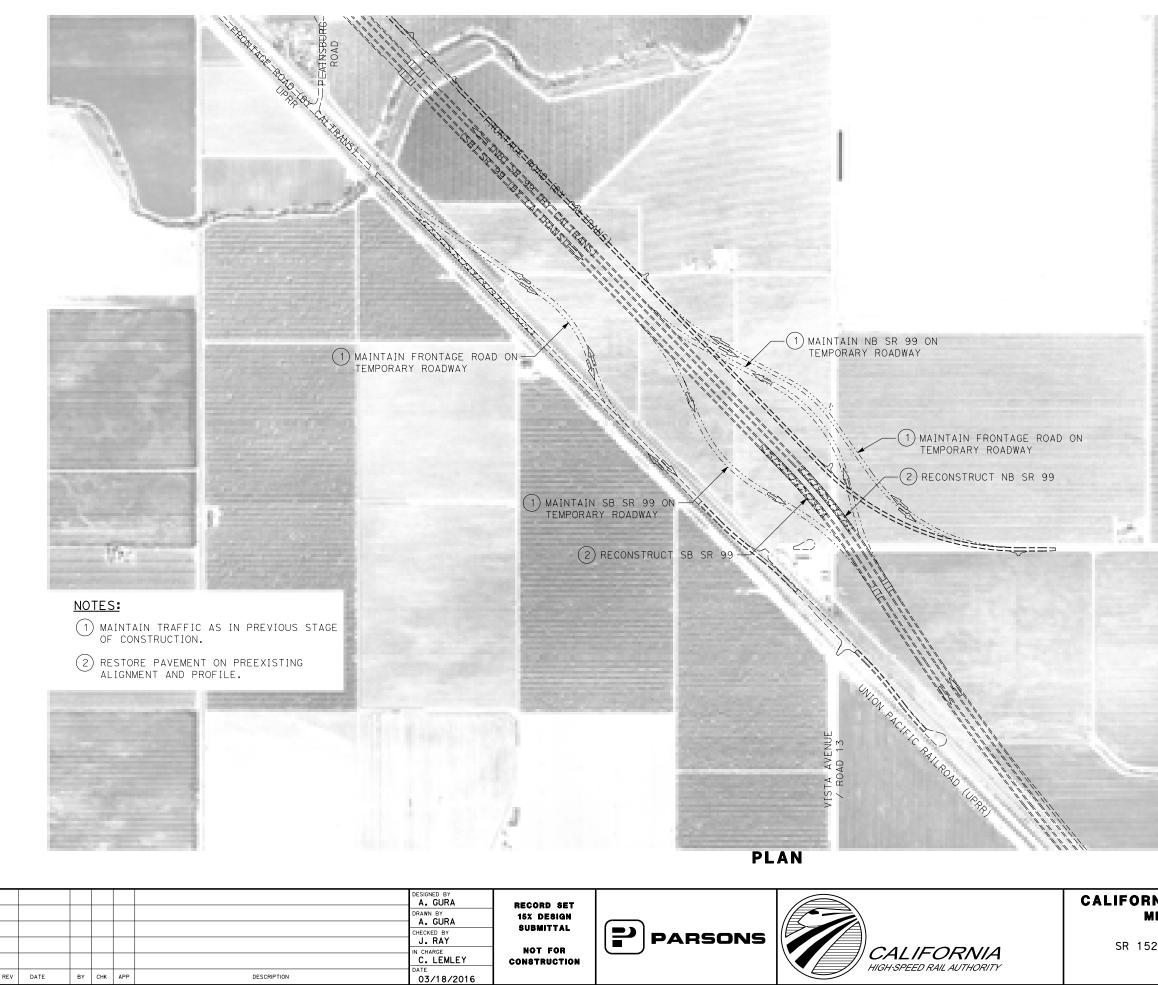

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CENTRAL VALLE	
(NORTH) TO ROAD 19 STAGE CONSTRUCT	ON PLAN AS SHOWN

SR 99 TUNNEL STAGE 4 OF 4